


California High-Speed Rail Authority

Merced to Fresno Section: Central Valley Wye

Alignment and Typical Section Plans (Book 2 of 4)
SR 152 (North) To Road 19 Wye Alternative

Preliminary Engineering for Project Definition
Record Set - September 2016

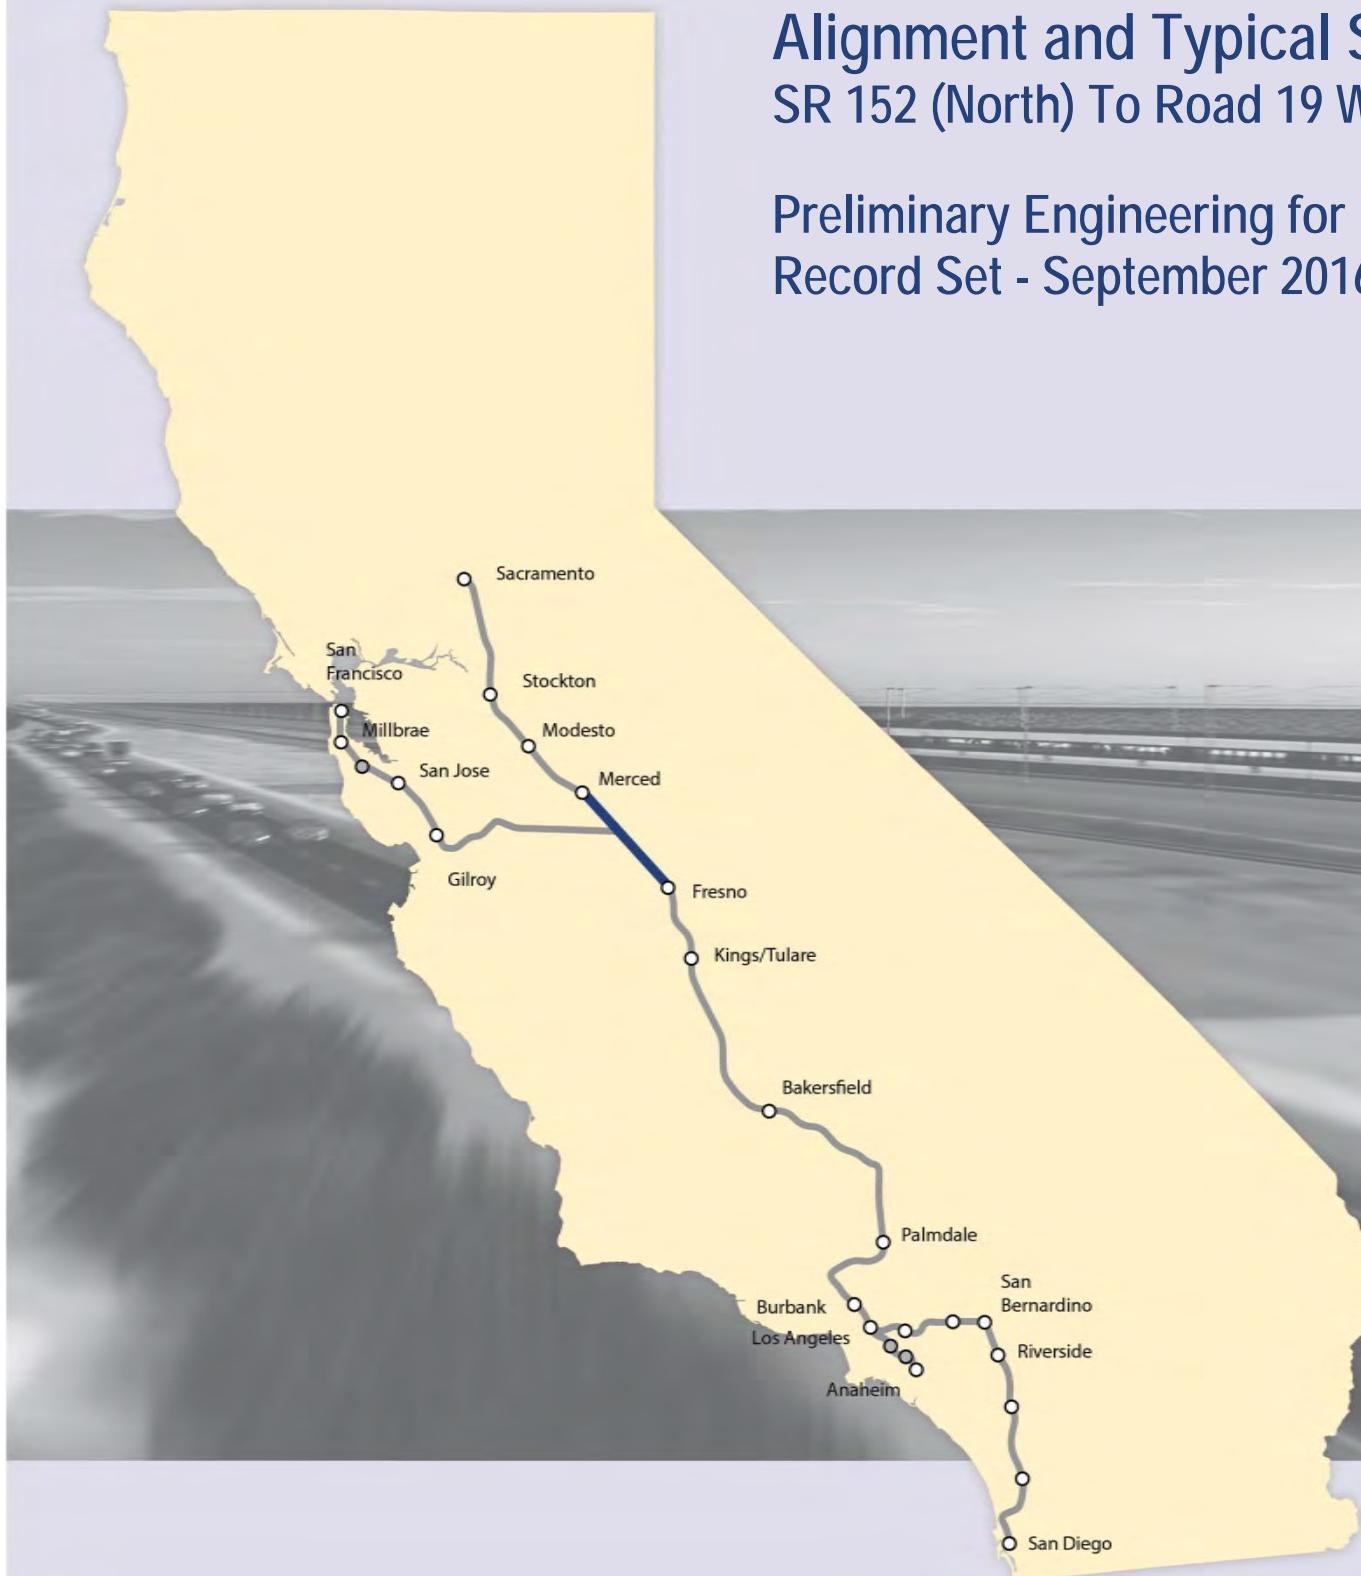

INDEX OF DRAWINGS				
DRAWING NO.	SECTION	ALIGNMENT / PLAN SET	TITLE	DESCRIPTION
GENERAL				
TT-B0001	CENTRAL VALLEY WYE	ALIGNMENT AND TYPICAL SECTION PLANS	COVER	
TT-B0002	CENTRAL VALLEY WYE	ALIGNMENT AND TYPICAL SECTION PLANS	INDEX OF DRAWINGS	SHEET 1 OF 9
TT-B0003	CENTRAL VALLEY WYE	ALIGNMENT AND TYPICAL SECTION PLANS	INDEX OF DRAWINGS	SHEET 2 OF 9
TT-B0004	CENTRAL VALLEY WYE	ALIGNMENT AND TYPICAL SECTION PLANS	INDEX OF DRAWINGS	SHEET 3 OF 9
TT-B0005	CENTRAL VALLEY WYE	ALIGNMENT AND TYPICAL SECTION PLANS	INDEX OF DRAWINGS	SHEET 4 OF 9
TT-B0006	CENTRAL VALLEY WYE	ALIGNMENT AND TYPICAL SECTION PLANS	INDEX OF DRAWINGS	SHEET 5 OF 9
TT-B0007	CENTRAL VALLEY WYE	ALIGNMENT AND TYPICAL SECTION PLANS	INDEX OF DRAWINGS	SHEET 6 OF 9
TT-B0008	CENTRAL VALLEY WYE	ALIGNMENT AND TYPICAL SECTION PLANS	INDEX OF DRAWINGS	SHEET 7 OF 9
TT-B0009	CENTRAL VALLEY WYE	ALIGNMENT AND TYPICAL SECTION PLANS	INDEX OF DRAWINGS	SHEET 8 OF 9
TT-B0010	CENTRAL VALLEY WYE	ALIGNMENT AND TYPICAL SECTION PLANS	INDEX OF DRAWINGS	SHEET 9 OF 9
TT-B0011	CENTRAL VALLEY WYE	ALIGNMENT AND TYPICAL SECTION PLANS	ABBREVIATIONS	SHEET 1 OF 2
TT-B0012	CENTRAL VALLEY WYE	ALIGNMENT AND TYPICAL SECTION PLANS	ABBREVIATIONS	SHEET 1 OF 2
TT-B4000	CENTRAL VALLEY WYE	ALIGNMENT AND TYPICAL SECTION PLANS	LOCATION PLAN	
SR 152 (NORTH) TO ROAD 13 WYE ALTERNATIVE				
TT-C4001-A	CENTRAL VALLEY WYE	SR 152 (NORTH) TO ROAD 13 WYE ALTERNATIVE	KEY MAP	SHEET 1 OF 3
TT-C4002-A	CENTRAL VALLEY WYE	SR 152 (NORTH) TO ROAD 13 WYE ALTERNATIVE	KEY MAP	SHEET 2 OF 3
TT-C4003-A	CENTRAL VALLEY WYE	SR 152 (NORTH) TO ROAD 13 WYE ALTERNATIVE	KEY MAP	SHEET 3 OF 3
TT-B0020-A	CENTRAL VALLEY WYE	SR 152 (NORTH) TO ROAD 13 WYE ALTERNATIVE	TYPICAL SECTION	SHEET 1 OF 12
TT-B0021-A	CENTRAL VALLEY WYE	SR 152 (NORTH) TO ROAD 13 WYE ALTERNATIVE	TYPICAL SECTION	SHEET 2 OF 12
TT-B0022-A	CENTRAL VALLEY WYE	SR 152 (NORTH) TO ROAD 13 WYE ALTERNATIVE	TYPICAL SECTION	SHEET 3 OF 12
TT-B0023-A	CENTRAL VALLEY WYE	SR 152 (NORTH) TO ROAD 13 WYE ALTERNATIVE	TYPICAL SECTION	SHEET 4 OF 12
TT-B0024-A	CENTRAL VALLEY WYE	SR 152 (NORTH) TO ROAD 13 WYE ALTERNATIVE	TYPICAL SECTION	SHEET 5 OF 12
TT-B0025-A	CENTRAL VALLEY WYE	SR 152 (NORTH) TO ROAD 13 WYE ALTERNATIVE	TYPICAL SECTION	SHEET 6 OF 12
TT-B0026-A	CENTRAL VALLEY WYE	SR 152 (NORTH) TO ROAD 13 WYE ALTERNATIVE	TYPICAL SECTION	SHEET 7 OF 12
TT-B0027-A	CENTRAL VALLEY WYE	SR 152 (NORTH) TO ROAD 13 WYE ALTERNATIVE	TYPICAL SECTION	SHEET 8 OF 12
TT-B0028-A	CENTRAL VALLEY WYE	SR 152 (NORTH) TO ROAD 13 WYE ALTERNATIVE	TYPICAL SECTION	SHEET 9 OF 12
TT-B0029-A	CENTRAL VALLEY WYE	SR 152 (NORTH) TO ROAD 13 WYE ALTERNATIVE	TYPICAL SECTION	SHEET 10 OF 12
TT-B0030-A	CENTRAL VALLEY WYE	SR 152 (NORTH) TO ROAD 13 WYE ALTERNATIVE	TYPICAL SECTION	SHEET 11 OF 12
TT-B0031-A	CENTRAL VALLEY WYE	SR 152 (NORTH) TO ROAD 13 WYE ALTERNATIVE	TYPICAL SECTION	SHEET 12 OF 12
TT-B0050-A	CENTRAL VALLEY WYE	SR 152 (NORTH) TO ROAD 13 WYE ALTERNATIVE	SB TRACK SAN JOSE TO FRESNO GEOMETRY DATA	SHEET 1 OF 7
TT-B0051-A	CENTRAL VALLEY WYE	SR 152 (NORTH) TO ROAD 13 WYE ALTERNATIVE	SB TRACK SAN JOSE TO FRESNO GEOMETRY DATA	SHEET 2 OF 7
TT-B0052-A	CENTRAL VALLEY WYE	SR 152 (NORTH) TO ROAD 13 WYE ALTERNATIVE	NB TRACK SAN JOSE TO FRESNO GEOMETRY DATA	SHEET 3 OF 7
TT-B0053-A	CENTRAL VALLEY WYE	SR 152 (NORTH) TO ROAD 13 WYE ALTERNATIVE	NB TRACK SAN JOSE TO FRESNO GEOMETRY DATA	SHEET 4 OF 7
TT-B0054-A	CENTRAL VALLEY WYE	SR 152 (NORTH) TO ROAD 13 WYE ALTERNATIVE	SB TRACK MERCED TO FRESNO GEOMETRY DATA	SHEET 5 OF 7
TT-B0055-A	CENTRAL VALLEY WYE	SR 152 (NORTH) TO ROAD 13 WYE ALTERNATIVE	NB TRACK MERCED TO FRESNO GEOMETRY DATA	SHEET 6 OF 7
TT-B0056-A	CENTRAL VALLEY WYE	SR 152 (NORTH) TO ROAD 13 WYE ALTERNATIVE	SB & NB TRACK SAN JOSE TO MERCED GEOMETRY DATA	SHEET 7 OF 7
TT-D1010-A	CENTRAL VALLEY WYE	SR 152 (NORTH) TO ROAD 13 WYE ALTERNATIVE	TRACK PLAN AND PROFILE	SJD-FRE STA 5338+00.00 TO 5394+00.00
TT-D1020-A	CENTRAL VALLEY WYE	SR 152 (NORTH) TO ROAD 13 WYE ALTERNATIVE	TRACK PLAN AND PROFILE	SJD-FRE STA 5394+00.00 TO 5450+00.00
TT-D1030-A	CENTRAL VALLEY WYE	SR 152 (NORTH) TO ROAD 13 WYE ALTERNATIVE	TRACK PLAN AND PROFILE	SJD-FRE STA 5450+00.00 TO 5506+00.00
TT-D1040-A	CENTRAL VALLEY WYE	SR 152 (NORTH) TO ROAD 13 WYE ALTERNATIVE	TRACK PLAN AND PROFILE	SJD-FRE STA 5506+00.00 TO 5562+00.00
TT-D1050-A	CENTRAL VALLEY WYE	SR 152 (NORTH) TO ROAD 13 WYE ALTERNATIVE	TRACK PLAN AND PROFILE	SJD-FRE STA 5562+00.00 TO 5618+00.00

DESIGNED BY C. LEMLEY	RECORD SET 15% DESIGN SUBMITTAL	NOT FOR CONSTRUCTION		
DRAWN BY J. ALADIN				
CHECKED BY S. WILSON				
IN CHARGE C. LEMLEY				
DATE 08/12/2016				
REV	DATE	BY	CHK	APP
DESCRIPTION				

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							DESIGNED BY C. LEMLEY	RECORD SET 15% DESIGN SUBMITTAL	 PARSONS		CALIFORNIA HIGH-SPEED RAIL AUTHORITY	CALIFORNIA HIGH-SPEED TRAIN PROJECT MERCED TO FRESNO SECTION CENTRAL VALLEY WYE ALIGNMENT AND TYPICAL SECTION PLANS INDEX OF DRAWINGS SHEET 2 OF 9	CONTRACT NO. HSR08-05
							DRAWN BY J. ALADIN						DRAWING NO. TT-B0003
							CHECKED BY S. WILSON						SCALE NO SCALE
							IN CHARGE C. LEMLEY						SHEET NO.
REV	DATE	BY	CHK	APP		DESCRIPTION	DATE 08/12/2016						

INDEX OF DRAWINGS				
DRAWING NO.	SECTION	ALIGNMENT / PLAN SET	TITLE	DESCRIPTION
TT-D1520-A	CENTRAL VALLEY WYE	SR 152 (NORTH) TO ROAD 13 WYE ALTERNATIVE	TRACK PLAN AND PROFILE	MER-FRE STA 15556+00.00 TO 15612+00.00
TT-D1530-A	CENTRAL VALLEY WYE	SR 152 (NORTH) TO ROAD 13 WYE ALTERNATIVE	TRACK PLAN AND PROFILE	MER-FRE STA 15612+00.00 TO 15655+00.00
TT-D1610-A	CENTRAL VALLEY WYE	SR 152 (NORTH) TO ROAD 13 WYE ALTERNATIVE	TRACK PLAN	SJD-MER STA 36246+00.00 TO 36302+00.00
TT-D1611-A	CENTRAL VALLEY WYE	SR 152 (NORTH) TO ROAD 13 WYE ALTERNATIVE	TRACK PROFILE	SJD-MER STA 36246+00.00 TO 36302+00.00
TT-D1620-A	CENTRAL VALLEY WYE	SR 152 (NORTH) TO ROAD 13 WYE ALTERNATIVE	TRACK PLAN	SJD-MER STA 36302+00.00 TO 36358+00.00
TT-D1621-A	CENTRAL VALLEY WYE	SR 152 (NORTH) TO ROAD 13 WYE ALTERNATIVE	TRACK PROFILE	SJD-MER STA 36302+00.00 TO 36358+00.00
TT-D1630-A	CENTRAL VALLEY WYE	SR 152 (NORTH) TO ROAD 13 WYE ALTERNATIVE	TRACK PLAN	SJD-MER STA 36358+00.00 TO 36414+00.00
TT-D1631-A	CENTRAL VALLEY WYE	SR 152 (NORTH) TO ROAD 13 WYE ALTERNATIVE	TRACK PROFILE	SJD-MER STA 36358+00.00 TO 36414+00.00
TT-D1640-A	CENTRAL VALLEY WYE	SR 152 (NORTH) TO ROAD 13 WYE ALTERNATIVE	TRACK PLAN	SJD-MER STA 36414+00.00 TO 36470+00.00
TT-D1641-A	CENTRAL VALLEY WYE	SR 152 (NORTH) TO ROAD 13 WYE ALTERNATIVE	TRACK PROFILE	SJD-MER STA 36414+00.00 TO 36470+00.00
TT-D1650-A	CENTRAL VALLEY WYE	SR 152 (NORTH) TO ROAD 13 WYE ALTERNATIVE	TRACK PLAN	SJD-MER STA 36470+00.00 TO 36526+00.00
TT-D1651-A	CENTRAL VALLEY WYE	SR 152 (NORTH) TO ROAD 13 WYE ALTERNATIVE	TRACK PROFILE	SJD-MER STA 36470+00.00 TO 36526+00.00
TT-D1660-A	CENTRAL VALLEY WYE	SR 152 (NORTH) TO ROAD 13 WYE ALTERNATIVE	TRACK PLAN	SJD-MER STA 36526+00.00 TO 36544+07.50
TT-D1661-A	CENTRAL VALLEY WYE	SR 152 (NORTH) TO ROAD 13 WYE ALTERNATIVE	TRACK PROFILE	SJD-MER STA 36526+00.00 TO 36544+07.50
SR 152 (NORTH) TO ROAD 19 WYE ALTERNATIVE				
TT-C4001-B	CENTRAL VALLEY WYE	SR 152 (NORTH) TO ROAD 19 WYE ALTERNATIVE	KEY MAP	SHEET 1 OF 3
TT-C4002-B	CENTRAL VALLEY WYE	SR 152 (NORTH) TO ROAD 19 WYE ALTERNATIVE	KEY MAP	SHEET 2 OF 3
TT-C4003-B	CENTRAL VALLEY WYE	SR 152 (NORTH) TO ROAD 19 WYE ALTERNATIVE	KEY MAP	SHEET 3 OF 3
TT-B0020-B	CENTRAL VALLEY WYE	SR 152 (NORTH) TO ROAD 19 WYE ALTERNATIVE	TYPICAL SECTION	SHEET 1 OF 12
TT-B0021-B	CENTRAL VALLEY WYE	SR 152 (NORTH) TO ROAD 19 WYE ALTERNATIVE	TYPICAL SECTION	SHEET 2 OF 12
TT-B0022-B	CENTRAL VALLEY WYE	SR 152 (NORTH) TO ROAD 19 WYE ALTERNATIVE	TYPICAL SECTION	SHEET 3 OF 12
TT-B0023-B	CENTRAL VALLEY WYE	SR 152 (NORTH) TO ROAD 19 WYE ALTERNATIVE	TYPICAL SECTION	SHEET 4 OF 12
TT-B0024-B	CENTRAL VALLEY WYE	SR 152 (NORTH) TO ROAD 19 WYE ALTERNATIVE	TYPICAL SECTION	SHEET 5 OF 12
TT-B0025-B	CENTRAL VALLEY WYE	SR 152 (NORTH) TO ROAD 19 WYE ALTERNATIVE	TYPICAL SECTION	SHEET 6 OF 12
TT-B0026-B	CENTRAL VALLEY WYE	SR 152 (NORTH) TO ROAD 19 WYE ALTERNATIVE	TYPICAL SECTION	SHEET 7 OF 12
TT-B0027-B	CENTRAL VALLEY WYE	SR 152 (NORTH) TO ROAD 19 WYE ALTERNATIVE	TYPICAL SECTION	SHEET 8 OF 12
TT-B0028-B	CENTRAL VALLEY WYE	SR 152 (NORTH) TO ROAD 19 WYE ALTERNATIVE	TYPICAL SECTION	SHEET 9 OF 12
TT-B0029-B	CENTRAL VALLEY WYE	SR 152 (NORTH) TO ROAD 19 WYE ALTERNATIVE	TYPICAL SECTION	SHEET 10 OF 12
TT-B0030-B	CENTRAL VALLEY WYE	SR 152 (NORTH) TO ROAD 19 WYE ALTERNATIVE	TYPICAL SECTION	SHEET 11 OF 12
TT-B0031-B	CENTRAL VALLEY WYE	SR 152 (NORTH) TO ROAD 19 WYE ALTERNATIVE	TYPICAL SECTION	SHEET 12 OF 12
TT-B0050-B	CENTRAL VALLEY WYE	SR 152 (NORTH) TO ROAD 19 WYE ALTERNATIVE	SB TRACK SAN JOSE TO FRESNO GEOMETRY DATA	SHEET 1 OF 9
TT-B0051-B	CENTRAL VALLEY WYE	SR 152 (NORTH) TO ROAD 19 WYE ALTERNATIVE	SB TRACK SAN JOSE TO FRESNO GEOMETRY DATA	SHEET 2 OF 9
TT-B0052-B	CENTRAL VALLEY WYE	SR 152 (NORTH) TO ROAD 19 WYE ALTERNATIVE	SB & NB TRACK SAN JOSE TO FRESNO GEOMETRY DATA	SHEET 3 OF 9
TT-B0053-B	CENTRAL VALLEY WYE	SR 152 (NORTH) TO ROAD 19 WYE ALTERNATIVE	NB TRACK SAN JOSE TO FRESNO GEOMETRY DATA	SHEET 4 OF 9
TT-B0054-B	CENTRAL VALLEY WYE	SR 152 (NORTH) TO ROAD 19 WYE ALTERNATIVE	NB TRACK SAN JOSE TO FRESNO GEOMETRY DATA	SHEET 5 OF 9
TT-B0055-B	CENTRAL VALLEY WYE	SR 152 (NORTH) TO ROAD 19 WYE ALTERNATIVE	SB TRACK MERCED TO FRESNO GEOMETRY DATA	SHEET 6 OF 9
TT-B0056-B	CENTRAL VALLEY WYE	SR 152 (NORTH) TO ROAD 19 WYE ALTERNATIVE	SB & NB TRACK MERCED TO FRESNO GEOMETRY DATA	SHEET 7 OF 9
TT-B0057-B	CENTRAL VALLEY WYE	SR 152 (NORTH) TO ROAD 19 WYE ALTERNATIVE	NB TRACK MERCED TO FRESNO GEOMETRY DATA	SHEET 8 OF 9
TT-B0058-B	CENTRAL VALLEY WYE	SR 152 (NORTH) TO ROAD 19 WYE ALTERNATIVE	SB & NB TRACK SAN JOSE TO MERCED GEOMETRY DATA	SHEET 9 OF 9
TT-D1010-B	CENTRAL VALLEY WYE	SR 152 (NORTH) TO ROAD 19 WYE ALTERNATIVE	TRACK PLAN AND PROFILE	SJD-FRE STA 5338+00.00 TO 5394+00.00
TT-D1020-B	CENTRAL VALLEY WYE	SR 152 (NORTH) TO ROAD 19 WYE ALTERNATIVE	TRACK PLAN AND PROFILE	SJD-FRE STA 5394+00.00 TO 5450+00.00

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15-AUG-2016 4:57

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REV DATE BY CHK APP DESCRIPTION

DESIGNED BY
C. LEMLEY
DRAWN BY
J. ALADIN
CHECKED BY
S. WILSON
IN CHARGE
C. LEMLEY
DATE
08/12/2016RECORD SET
15% DESIGN
SUBMITTAL
NOT FOR
CONSTRUCTION**PARSONS**

CALIFORNIA HIGH-SPEED TRAIN PROJECT
MERCED TO FRESNO SECTION
CENTRAL VALLEY WYE
ALIGNMENT AND TYPICAL SECTION PLANS
INDEX OF DRAWINGS
SHEET 3 OF 9

CONTRACT NO.
HSR08-05
DRAWING NO.
TT-B0004
SCALE
NO SCALE
SHEET NO.

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						DESIGNED BY C. LEMLEY	RECORD SET 15% DESIGN SUBMITTAL	 PARSONS		CALIFORNIA HIGH-SPEED RAIL AUTHORITY	CALIFORNIA HIGH-SPEED TRAIN PROJECT MERCED TO FRESNO SECTION CENTRAL VALLEY WYE ALIGNMENT AND TYPICAL SECTION PLANS INDEX OF DRAWINGS SHEET 4 OF 9	CONTRACT NO. HSR08-05
						DRAWN BY J. ALADIN					DRAWING NO. TT-B0005	
						CHECKED BY S. WILSON					SCALE NO SCALE	
						IN CHARGE C. LEMLEY	NOT FOR CONSTRUCTION				SHEET NO.	
REV	DATE	BY	CHK	APP	DESCRIPTION	DATE 08/12/2016						

INDEX OF DRAWINGS				
DRAWING NO.	SECTION	ALIGNMENT / PLAN SET	TITLE	DESCRIPTION
TT-D1460-B	CENTRAL VALLEY WYE	SR 152 (NORTH) TO ROAD 19 WYE ALTERNATIVE	TRACK PLAN	MER-FRE STA 14995+00.00 TO 15051+00.00
TT-D1461-B	CENTRAL VALLEY WYE	SR 152 (NORTH) TO ROAD 19 WYE ALTERNATIVE	TRACK PROFILE	MER-FRE STA 14995+00.00 TO 15051+00.00
TT-D1470-B	CENTRAL VALLEY WYE	SR 152 (NORTH) TO ROAD 19 WYE ALTERNATIVE	TRACK PLAN	MER-FRE STA 15051+00.00 TO 15107+00.00
TT-D1471-B	CENTRAL VALLEY WYE	SR 152 (NORTH) TO ROAD 19 WYE ALTERNATIVE	TRACK PROFILE	MER-FRE STA 15051+00.00 TO 15107+00.00
TT-D1480-B	CENTRAL VALLEY WYE	SR 152 (NORTH) TO ROAD 19 WYE ALTERNATIVE	TRACK PLAN	MER-FRE STA 15107+00.00 TO 15163+00.00
TT-D1481-B	CENTRAL VALLEY WYE	SR 152 (NORTH) TO ROAD 19 WYE ALTERNATIVE	TRACK PROFILE	MER-FRE STA 15107+00.00 TO 15163+00.00
TT-D1490-B	CENTRAL VALLEY WYE	SR 152 (NORTH) TO ROAD 19 WYE ALTERNATIVE	TRACK PLAN	MER-FRE STA 15163+00.00 TO 15219+00.00
TT-D1491-B	CENTRAL VALLEY WYE	SR 152 (NORTH) TO ROAD 19 WYE ALTERNATIVE	TRACK PROFILE	MER-FRE STA 15163+00.00 TO 15219+00.00
TT-D1500-B	CENTRAL VALLEY WYE	SR 152 (NORTH) TO ROAD 19 WYE ALTERNATIVE	TRACK PLAN	MER-FRE STA 15219+00.00 TO 15275+00.00
TT-D1501-B	CENTRAL VALLEY WYE	SR 152 (NORTH) TO ROAD 19 WYE ALTERNATIVE	TRACK PROFILE	MER-FRE STA 15219+00.00 TO 15275+00.00
TT-D1510-B	CENTRAL VALLEY WYE	SR 152 (NORTH) TO ROAD 19 WYE ALTERNATIVE	TRACK PLAN	MER-FRE STA 15275+00.00 TO 15331+00.00
TT-D1511-B	CENTRAL VALLEY WYE	SR 152 (NORTH) TO ROAD 19 WYE ALTERNATIVE	TRACK PROFILE	MER-FRE STA 15275+00.00 TO 15331+00.00
TT-D1520-B	CENTRAL VALLEY WYE	SR 152 (NORTH) TO ROAD 19 WYE ALTERNATIVE	TRACK PLAN	MER-FRE STA 15331+00.00 TO 15387+00.00
TT-D1521-B	CENTRAL VALLEY WYE	SR 152 (NORTH) TO ROAD 19 WYE ALTERNATIVE	TRACK PROFILE	MER-FRE STA 15331+00.00 TO 15387+00.00
TT-D1530-B	CENTRAL VALLEY WYE	SR 152 (NORTH) TO ROAD 19 WYE ALTERNATIVE	TRACK PLAN	MER-FRE STA 15387+00.00 TO 15443+00.00
TT-D1531-B	CENTRAL VALLEY WYE	SR 152 (NORTH) TO ROAD 19 WYE ALTERNATIVE	TRACK PROFILE	MER-FRE STA 15387+00.00 TO 15443+00.00
TT-D1540-B	CENTRAL VALLEY WYE	SR 152 (NORTH) TO ROAD 19 WYE ALTERNATIVE	TRACK PLAN	MER-FRE STA 15443+00.00 TO 15499+00.00
TT-D1541-B	CENTRAL VALLEY WYE	SR 152 (NORTH) TO ROAD 19 WYE ALTERNATIVE	TRACK PROFILE	MER-FRE STA 15443+00.00 TO 15499+00.00
TT-D1550-B	CENTRAL VALLEY WYE	SR 152 (NORTH) TO ROAD 19 WYE ALTERNATIVE	TRACK PLAN	MER-FRE STA 15499+00.00 TO 15555+00.00
TT-D1551-B	CENTRAL VALLEY WYE	SR 152 (NORTH) TO ROAD 19 WYE ALTERNATIVE	TRACK PROFILE	MER-FRE STA 15499+00.00 TO 15555+00.00
TT-D1560-B	CENTRAL VALLEY WYE	SR 152 (NORTH) TO ROAD 19 WYE ALTERNATIVE	TRACK PLAN	MER-FRE STA 15555+00.00 TO 15611+00.00
TT-D1561-B	CENTRAL VALLEY WYE	SR 152 (NORTH) TO ROAD 19 WYE ALTERNATIVE	TRACK PROFILE	MER-FRE STA 15555+00.00 TO 15611+00.00
TT-D1570-B	CENTRAL VALLEY WYE	SR 152 (NORTH) TO ROAD 19 WYE ALTERNATIVE	TRACK PLAN	MER-FRE STA 15611+00.00 TO 15655+00.00
TT-D1571-B	CENTRAL VALLEY WYE	SR 152 (NORTH) TO ROAD 19 WYE ALTERNATIVE	TRACK PROFILE	MER-FRE STA 15611+00.00 TO 15655+00.00
TT-D1610-B	CENTRAL VALLEY WYE	SR 152 (NORTH) TO ROAD 19 WYE ALTERNATIVE	TRACK PLAN	SJD-MER STA 36570+00.00 TO 36626+00.00
TT-D1611-B	CENTRAL VALLEY WYE	SR 152 (NORTH) TO ROAD 19 WYE ALTERNATIVE	TRACK PROFILE	SJD-MER STA 36570+00.00 TO 36626+00.00
TT-D1620-B	CENTRAL VALLEY WYE	SR 152 (NORTH) TO ROAD 19 WYE ALTERNATIVE	TRACK PLAN	SJD-MER STA 36626+00.00 TO 36682+00.00
TT-D1621-B	CENTRAL VALLEY WYE	SR 152 (NORTH) TO ROAD 19 WYE ALTERNATIVE	TRACK PROFILE	SJD-MER STA 36626+00.00 TO 36682+00.00
TT-D1630-B	CENTRAL VALLEY WYE	SR 152 (NORTH) TO ROAD 19 WYE ALTERNATIVE	TRACK PLAN	SJD-MER STA 36682+00.00 TO 36738+00.00
TT-D1631-B	CENTRAL VALLEY WYE	SR 152 (NORTH) TO ROAD 19 WYE ALTERNATIVE	TRACK PROFILE	SJD-MER STA 36682+00.00 TO 36738+00.00
TT-D1640-B	CENTRAL VALLEY WYE	SR 152 (NORTH) TO ROAD 19 WYE ALTERNATIVE	TRACK PLAN	SJD-MER STA 36738+00.00 TO 36794+00.00
TT-D1641-B	CENTRAL VALLEY WYE	SR 152 (NORTH) TO ROAD 19 WYE ALTERNATIVE	TRACK PROFILE	SJD-MER STA 36738+00.00 TO 36794+00.00
TT-D1650-B	CENTRAL VALLEY WYE	SR 152 (NORTH) TO ROAD 19 WYE ALTERNATIVE	TRACK PLAN	SJD-MER STA 36794+00.00 TO 36850+00.00
TT-D1651-B	CENTRAL VALLEY WYE	SR 152 (NORTH) TO ROAD 19 WYE ALTERNATIVE	TRACK PROFILE	SJD-MER STA 36794+00.00 TO 36850+00.00
TT-D1660-B	CENTRAL VALLEY WYE	SR 152 (NORTH) TO ROAD 19 WYE ALTERNATIVE	TRACK PLAN	SJD-MER STA 36850+00.00 TO 36857+28.64
TT-D1661-B	CENTRAL VALLEY WYE	SR 152 (NORTH) TO ROAD 19 WYE ALTERNATIVE	TRACK PROFILE	SJD-MER STA 36850+00.00 TO 36857+28.64
AVENUE 21 TO ROAD 13 WYE ALTERNATIVE				
TT-C0001-C	CENTRAL VALLEY WYE	AVENUE 21 TO ROAD 13 WYE ALTERNATIVE	KEY MAP	SHEET 1 OF 4
TT-C0002-C	CENTRAL VALLEY WYE	AVENUE 21 TO ROAD 13 WYE ALTERNATIVE	KEY MAP	SHEET 2 OF 4
TT-C0003-C	CENTRAL VALLEY WYE	AVENUE 21 TO ROAD 13 WYE ALTERNATIVE	KEY MAP	SHEET 3 OF 4
TT-C0004-C	CENTRAL VALLEY WYE	AVENUE 21 TO ROAD 13 WYE ALTERNATIVE	KEY MAP	SHEET 4 OF 4

DESIGNED BY
C. LEMLEY
DRAWN BY
J. ALADIN
CHECKED BY
S. WILSON
IN CHARGE
C. LEMLEY
DATE
08/12/2016

RECORD SET
15% DESIGN
SUBMITTAL
NOT FOR
CONSTRUCTION



**CALIFORNIA HIGH-SPEED TRAIN PROJECT
MERCED TO FRESNO SECTION**
CENTRAL VALLEY WYE
ALIGNMENT AND TYPICAL SECTION PLANS
INDEX OF DRAWINGS
SHEET 5 OF 9

CONTRACT NO.
HSR08-05
DRAWING NO.
TT-B0006
SCALE
NO SCALE
SHEET NO.

INDEX OF DRAWINGS				
DRAWING NO.	SECTION	ALIGNMENT / PLAN SET	TITLE	DESCRIPTION
TT-B0020-C	CENTRAL VALLEY WYE	AVENUE 21 TO ROAD 13 WYE ALTERNATIVE	TYPICAL SECTIONS	SHEET 1 OF 8
TT-B0021-C	CENTRAL VALLEY WYE	AVENUE 21 TO ROAD 13 WYE ALTERNATIVE	TYPICAL SECTIONS	SHEET 2 OF 8
TT-B0022-C	CENTRAL VALLEY WYE	AVENUE 21 TO ROAD 13 WYE ALTERNATIVE	TYPICAL SECTIONS	SHEET 3 OF 8
TT-B0023-C	CENTRAL VALLEY WYE	AVENUE 21 TO ROAD 13 WYE ALTERNATIVE	TYPICAL SECTIONS	SHEET 4 OF 8
TT-B0024-C	CENTRAL VALLEY WYE	AVENUE 21 TO ROAD 13 WYE ALTERNATIVE	TYPICAL SECTIONS	SHEET 5 OF 8
TT-B0025-C	CENTRAL VALLEY WYE	AVENUE 21 TO ROAD 13 WYE ALTERNATIVE	TYPICAL SECTIONS	SHEET 6 OF 8
TT-B0026-C	CENTRAL VALLEY WYE	AVENUE 21 TO ROAD 13 WYE ALTERNATIVE	TYPICAL SECTIONS	SHEET 7 OF 8
TT-B0027-C	CENTRAL VALLEY WYE	AVENUE 21 TO ROAD 13 WYE ALTERNATIVE	TYPICAL SECTIONS	SHEET 8 OF 8
TT-B0050-C	CENTRAL VALLEY WYE	AVENUE 21 TO ROAD 13 WYE ALTERNATIVE	SB TRACK SAN JOSE TO FRESNO GEOMETRY DATA	SHEET 1 OF 9
TT-B0051-C	CENTRAL VALLEY WYE	AVENUE 21 TO ROAD 13 WYE ALTERNATIVE	SB TRACK SAN JOSE TO FRESNO GEOMETRY DATA	SHEET 2 OF 9
TT-B0052-C	CENTRAL VALLEY WYE	AVENUE 21 TO ROAD 13 WYE ALTERNATIVE	SB TRACK SAN JOSE TO FRESNO GEOMETRY DATA	SHEET 3 OF 9
TT-B0053-C	CENTRAL VALLEY WYE	AVENUE 21 TO ROAD 13 WYE ALTERNATIVE	NB TRACK SAN JOSE TO FRESNO GEOMETRY DATA	SHEET 4 OF 9
TT-B0054-C	CENTRAL VALLEY WYE	AVENUE 21 TO ROAD 13 WYE ALTERNATIVE	NB TRACK SAN JOSE TO FRESNO GEOMETRY DATA	SHEET 5 OF 9
TT-B0055-C	CENTRAL VALLEY WYE	AVENUE 21 TO ROAD 13 WYE ALTERNATIVE	NB TRACK SAN JOSE TO FRESNO GEOMETRY DATA	SHEET 6 OF 9
TT-B0056-C	CENTRAL VALLEY WYE	AVENUE 21 TO ROAD 13 WYE ALTERNATIVE	SB TRACK MERCED TO FRESNO GEOMETRY DATA	SHEET 7 OF 9
TT-B0057-C	CENTRAL VALLEY WYE	AVENUE 21 TO ROAD 13 WYE ALTERNATIVE	NB TRACK MERCED TO FRESNO GEOMETRY DATA	SHEET 8 OF 9
TT-B0058-C	CENTRAL VALLEY WYE	AVENUE 21 TO ROAD 13 WYE ALTERNATIVE	NB & SB TRACK SAN JOSE TO MERCED GEOMETRY DATA	SHEET 9 OF 9
TT-D1010-C	CENTRAL VALLEY WYE	AVENUE 21 TO ROAD 13 WYE ALTERNATIVE	TRACK PLAN AND PROFILE	SJD-FRE STA 5338+00.00 TO 5394+00.00
TT-D1020-C	CENTRAL VALLEY WYE	AVENUE 21 TO ROAD 13 WYE ALTERNATIVE	TRACK PLAN AND PROFILE	SJD-FRE STA 5394+00.00 TO 5450+00.00
TT-D1030-C	CENTRAL VALLEY WYE	AVENUE 21 TO ROAD 13 WYE ALTERNATIVE	TRACK PLAN AND PROFILE	SJD-FRE STA 5450+00.00 TO 5506+00.00
TT-D1040-C	CENTRAL VALLEY WYE	AVENUE 21 TO ROAD 13 WYE ALTERNATIVE	TRACK PLAN AND PROFILE	SJD-FRE STA 5506+00.00 TO 5562+00.00
TT-D1050-C	CENTRAL VALLEY WYE	AVENUE 21 TO ROAD 13 WYE ALTERNATIVE	TRACK PLAN AND PROFILE	SJD-FRE STA 5562+00.00 TO 5618+00.00
TT-D1060-C	CENTRAL VALLEY WYE	AVENUE 21 TO ROAD 13 WYE ALTERNATIVE	TRACK PLAN AND PROFILE	SJD-FRE STA 5618+00.00 TO 5674+00.00
TT-D1070-C	CENTRAL VALLEY WYE	AVENUE 21 TO ROAD 13 WYE ALTERNATIVE	TRACK PLAN AND PROFILE	SJD-FRE STA 5674+00.00 TO 5730+00.00
TT-D1080-C	CENTRAL VALLEY WYE	AVENUE 21 TO ROAD 13 WYE ALTERNATIVE	TRACK PLAN AND PROFILE	SJD-FRE STA 5730+00.00 TO 5786+00.00
TT-D1090-C	CENTRAL VALLEY WYE	AVENUE 21 TO ROAD 13 WYE ALTERNATIVE	TRACK PLAN AND PROFILE	SJD-FRE STA 5786+00.00 TO 5842+00.00
TT-D1100-C	CENTRAL VALLEY WYE	AVENUE 21 TO ROAD 13 WYE ALTERNATIVE	TRACK PLAN AND PROFILE	SJD-FRE STA 5842+00.00 TO 5898+00.00
TT-D1110-C	CENTRAL VALLEY WYE	AVENUE 21 TO ROAD 13 WYE ALTERNATIVE	TRACK PLAN AND PROFILE	SJD-FRE STA 5898+00.00 TO 5954+00.00
TT-D1120-C	CENTRAL VALLEY WYE	AVENUE 21 TO ROAD 13 WYE ALTERNATIVE	TRACK PLAN AND PROFILE	SJD-FRE STA 5954+00.00 TO 6010+00.00
TT-D1130-C	CENTRAL VALLEY WYE	AVENUE 21 TO ROAD 13 WYE ALTERNATIVE	TRACK PLAN AND PROFILE	SJD-FRE STA 6010+00.00 TO 6066+00.00
TT-D1140-C	CENTRAL VALLEY WYE	AVENUE 21 TO ROAD 13 WYE ALTERNATIVE	TRACK PLAN AND PROFILE	SJD-FRE STA 6066+00.00 TO 6122+00.00
TT-D1150-C	CENTRAL VALLEY WYE	AVENUE 21 TO ROAD 13 WYE ALTERNATIVE	TRACK PLAN AND PROFILE	SJD-FRE STA 6122+00.00 TO 6178+00.00
TT-D1160-C	CENTRAL VALLEY WYE	AVENUE 21 TO ROAD 13 WYE ALTERNATIVE	TRACK PLAN AND PROFILE	SJD-FRE STA 6178+00.00 TO 6234+00.00
TT-D1170-C	CENTRAL VALLEY WYE	AVENUE 21 TO ROAD 13 WYE ALTERNATIVE	TRACK PLAN AND PROFILE	SJD-FRE STA 6234+00.00 TO 6290+00.00
TT-D1180-C	CENTRAL VALLEY WYE	AVENUE 21 TO ROAD 13 WYE ALTERNATIVE	TRACK PLAN AND PROFILE	SJD-FRE STA 6290+00.00 TO 6346+00.00
TT-D1190-C	CENTRAL VALLEY WYE	AVENUE 21 TO ROAD 13 WYE ALTERNATIVE	TRACK PLAN AND PROFILE	SJD-FRE STA 6346+00.00 TO 6402+00.00
TT-D1200-C	CENTRAL VALLEY WYE	AVENUE 21 TO ROAD 13 WYE ALTERNATIVE	TRACK PLAN AND PROFILE	SJD-FRE STA 6402+00.00 TO 6458+00.00
TT-D1210-C	CENTRAL VALLEY WYE	AVENUE 21 TO ROAD 13 WYE ALTERNATIVE	TRACK PLAN AND PROFILE	SJD-FRE STA 6458+00.00 TO 6514+00.00
TT-D1220-C	CENTRAL VALLEY WYE	AVENUE 21 TO ROAD 13 WYE ALTERNATIVE	TRACK PLAN AND PROFILE	SJD-FRE STA 6514+00.00 TO 6570+00.00
TT-D1230-C	CENTRAL VALLEY WYE	AVENUE 21 TO ROAD 13 WYE ALTERNATIVE	TRACK PLAN AND PROFILE	SJD-FRE STA 6570+00.00 TO 6626+00.00
TT-D1240-C	CENTRAL VALLEY WYE	AVENUE 21 TO ROAD 13 WYE ALTERNATIVE	TRACK PLAN AND PROFILE	SJD-FRE STA 6626+00.00 TO 6682+00.00

				DESIGNED BY C. LEMLEY	RECORD SET 15% DESIGN SUBMITTAL	 PARSONS	 CALIFORNIA HIGH-SPEED RAIL AUTHORITY	CALIFORNIA HIGH-SPEED TRAIN PROJECT MERCED TO FRESNO SECTION	CONTRACT NO. HSR08-05
				DRAWN BY J. ALADIN				CENTRAL VALLEY WYE ALIGNMENT AND TYPICAL SECTION PLANS INDEX OF DRAWINGS SHEET 6 OF 9	DRAWING NO. TT-B0007
				CHECKED BY S. WILSON					SCALE NO SCALE
				IN CHARGE C. LEMLEY					SHEET NO. 9
REV	DATE	BY	CHK	APP	DESCRIPTION	08/12/2016			

INDEX OF DRAWINGS				
DRAWING NO.	SECTION	ALIGNMENT / PLAN SET	TITLE	DESCRIPTION
TT-D1250-C	CENTRAL VALLEY WYE	AVENUE 21 TO ROAD 13 WYE ALTERNATIVE	TRACK PLAN AND PROFILE	SJD-FRE STA 6682+00.00 TO 6738+00.00
TT-D1260-C	CENTRAL VALLEY WYE	AVENUE 21 TO ROAD 13 WYE ALTERNATIVE	TRACK PLAN AND PROFILE	SJD-FRE STA 6738+00.00 TO 6794+00.00
TT-D1270-C	CENTRAL VALLEY WYE	AVENUE 21 TO ROAD 13 WYE ALTERNATIVE	TRACK PLAN AND PROFILE	SJD-FRE STA 6794+00.00 TO 6850+00.00
TT-D1280-C	CENTRAL VALLEY WYE	AVENUE 21 TO ROAD 13 WYE ALTERNATIVE	TRACK PLAN AND PROFILE	SJD-FRE STA 6850+00.00 TO 6906+00.00
TT-D1290-C	CENTRAL VALLEY WYE	AVENUE 21 TO ROAD 13 WYE ALTERNATIVE	TRACK PLAN AND PROFILE	SJD-FRE STA 6906+00.00 TO 6962+00.00
TT-D1300-C	CENTRAL VALLEY WYE	AVENUE 21 TO ROAD 13 WYE ALTERNATIVE	TRACK PLAN AND PROFILE	SJD-FRE STA 6962+00.00 TO 7018+00.00
TT-D1310-C	CENTRAL VALLEY WYE	AVENUE 21 TO ROAD 13 WYE ALTERNATIVE	TRACK PLAN AND PROFILE	SJD-FRE STA 7018+00.00 TO 7074+00.00
TT-D1320-C	CENTRAL VALLEY WYE	AVENUE 21 TO ROAD 13 WYE ALTERNATIVE	TRACK PLAN AND PROFILE	SJD-FRE STA 7074+00.00 TO 7130+00.00
TT-D1330-C	CENTRAL VALLEY WYE	AVENUE 21 TO ROAD 13 WYE ALTERNATIVE	TRACK PLAN AND PROFILE	SJD-FRE STA 7130+00.00 TO 7147+86.07
TT-D1410-C	CENTRAL VALLEY WYE	AVENUE 21 TO ROAD 13 WYE ALTERNATIVE	TRACK PLAN	MER-FRE STA 14840+42.06 TO 14896+00.00
TT-D1411-C	CENTRAL VALLEY WYE	AVENUE 21 TO ROAD 13 WYE ALTERNATIVE	TRACK PROFILE	MER-FRE STA 14840+42.06 TO 14896+00.00
TT-D1420-C	CENTRAL VALLEY WYE	AVENUE 21 TO ROAD 13 WYE ALTERNATIVE	TRACK PLAN	MER-FRE STA 14896+00.00 TO 14952+00.00
TT-D1421-C	CENTRAL VALLEY WYE	AVENUE 21 TO ROAD 13 WYE ALTERNATIVE	TRACK PROFILE	MER-FRE STA 14896+00.00 TO 14952+00.00
TT-D1430-C	CENTRAL VALLEY WYE	AVENUE 21 TO ROAD 13 WYE ALTERNATIVE	TRACK PLAN	MER-FRE STA 14952+00.00 TO 15008+00.00
TT-D1431-C	CENTRAL VALLEY WYE	AVENUE 21 TO ROAD 13 WYE ALTERNATIVE	TRACK PROFILE	MER-FRE STA 14952+00.00 TO 15008+00.00
TT-D1440-C	CENTRAL VALLEY WYE	AVENUE 21 TO ROAD 13 WYE ALTERNATIVE	TRACK PLAN	MER-FRE STA 15008+00.00 TO 15064+00.00
TT-D1441-C	CENTRAL VALLEY WYE	AVENUE 21 TO ROAD 13 WYE ALTERNATIVE	TRACK PROFILE	MER-FRE STA 15008+00.00 TO 15064+00.00
TT-D1450-C	CENTRAL VALLEY WYE	AVENUE 21 TO ROAD 13 WYE ALTERNATIVE	TRACK PLAN	MER-FRE STA 15064+00.00 TO 15120+00.00
TT-D1451-C	CENTRAL VALLEY WYE	AVENUE 21 TO ROAD 13 WYE ALTERNATIVE	TRACK PROFILE	MER-FRE STA 15064+00.00 TO 15120+00.00
TT-D1460-C	CENTRAL VALLEY WYE	AVENUE 21 TO ROAD 13 WYE ALTERNATIVE	TRACK PLAN AND PROFILE	MER-FRE STA 15120+00.00 TO 15176+00.00
TT-D1470-C	CENTRAL VALLEY WYE	AVENUE 21 TO ROAD 13 WYE ALTERNATIVE	TRACK PLAN AND PROFILE	MER-FRE STA 15176+00.00 TO 15232+00.00
TT-D1480-C	CENTRAL VALLEY WYE	AVENUE 21 TO ROAD 13 WYE ALTERNATIVE	TRACK PLAN AND PROFILE	MER-FRE STA 15232+00.00 TO 15288+00.00
TT-D1490-C	CENTRAL VALLEY WYE	AVENUE 21 TO ROAD 13 WYE ALTERNATIVE	TRACK PLAN AND PROFILE	MER-FRE STA 15288+00.00 TO 15344+00.00
TT-D1500-C	CENTRAL VALLEY WYE	AVENUE 21 TO ROAD 13 WYE ALTERNATIVE	TRACK PLAN AND PROFILE	MER-FRE STA 15344+00.00 TO 15400+00.00
TT-D1510-C	CENTRAL VALLEY WYE	AVENUE 21 TO ROAD 13 WYE ALTERNATIVE	TRACK PLAN AND PROFILE	MER-FRE STA 15400+00.00 TO 15456+00.00
TT-D1520-C	CENTRAL VALLEY WYE	AVENUE 21 TO ROAD 13 WYE ALTERNATIVE	TRACK PLAN AND PROFILE	MER-FRE STA 15456+00.00 TO 15512+00.00
TT-D1530-C	CENTRAL VALLEY WYE	AVENUE 21 TO ROAD 13 WYE ALTERNATIVE	TRACK PLAN AND PROFILE	MER-FRE STA 15512+00.00 TO 15568+00.00
TT-D1540-C	CENTRAL VALLEY WYE	AVENUE 21 TO ROAD 13 WYE ALTERNATIVE	TRACK PLAN AND PROFILE	MER-FRE STA 15568+00.00 TO 15624+00.00
TT-D1550-C	CENTRAL VALLEY WYE	AVENUE 21 TO ROAD 13 WYE ALTERNATIVE	TRACK PLAN AND PROFILE	MER-FRE STA 15624+00.00 TO 15655+00.00
TT-D1610-C	CENTRAL VALLEY WYE	AVENUE 21 TO ROAD 13 WYE ALTERNATIVE	TRACK PLAN	SJD-MER STA 36269+99.76 TO 36324+00.00
TT-D1611-C	CENTRAL VALLEY WYE	AVENUE 21 TO ROAD 13 WYE ALTERNATIVE	TRACK PROFILE	SJD-MER STA 36269+99.76 TO 36324+00.00
TT-D1620-C	CENTRAL VALLEY WYE	AVENUE 21 TO ROAD 13 WYE ALTERNATIVE	TRACK PLAN	SJD-MER STA 36324+00.00 TO 36380+00.00
TT-D1621-C	CENTRAL VALLEY WYE	AVENUE 21 TO ROAD 13 WYE ALTERNATIVE	TRACK PROFILE	SJD-MER STA 36324+00.00 TO 36380+00.00
TT-D1630-C	CENTRAL VALLEY WYE	AVENUE 21 TO ROAD 13 WYE ALTERNATIVE	TRACK PLAN	SJD-MER STA 36380+00.00 TO 36436+00.00
TT-D1631-C	CENTRAL VALLEY WYE	AVENUE 21 TO ROAD 13 WYE ALTERNATIVE	TRACK PROFILE	SJD-MER STA 36380+00.00 TO 36436+00.00
TT-D1640-C	CENTRAL VALLEY WYE	AVENUE 21 TO ROAD 13 WYE ALTERNATIVE	TRACK PLAN	SJD-MER STA 36436+00.00 TO 36492+00.00
TT-D1641-C	CENTRAL VALLEY WYE	AVENUE 21 TO ROAD 13 WYE ALTERNATIVE	TRACK PROFILE	SJD-MER STA 36436+00.00 TO 36492+00.00
TT-D1650-C	CENTRAL VALLEY WYE	AVENUE 21 TO ROAD 13 WYE ALTERNATIVE	TRACK PLAN	SJD-MER STA 36492+00.00 TO 36548+00.00
TT-D1651-C	CENTRAL VALLEY WYE	AVENUE 21 TO ROAD 13 WYE ALTERNATIVE	TRACK PROFILE	SJD-MER STA 36492+00.00 TO 36548+00.00
TT-D1660-C	CENTRAL VALLEY WYE	AVENUE 21 TO ROAD 13 WYE ALTERNATIVE	TRACK PLAN	SJD-MER STA 36548+00.00 TO 36567+19.00
TT-D1661-C	CENTRAL VALLEY WYE	AVENUE 21 TO ROAD 13 WYE ALTERNATIVE	TRACK PROFILE	SJD-MER STA 36548+00.00 TO 36567+19.00

DESIGNED BY C. LEMLEY	RECORD SET 15% DESIGN SUBMITTAL	 PARSONS	 CALIFORNIA HIGH-SPEED RAIL AUTHORITY	CALIFORNIA HIGH-SPEED TRAIN PROJECT MERCED TO FRESNO SECTION CENTRAL VALLEY WYE ALIGNMENT AND TYPICAL SECTION PLANS INDEX OF DRAWINGS SHEET 7 OF 9	CONTRACT NO. HSR08-05
DRAWN BY J. ALADIN	NOT FOR CONSTRUCTION				DRAWING NO. TT-B0008
CHECKED BY S. WILSON					SCALE NO SCALE
IN CHARGE C. LEMLEY					SHEET NO. 9
DATE 08/12/2016					
REV	DATE	BY	CHK	APP	DESCRIPTION

INDEX OF DRAWINGS				
DRAWING NO.	SECTION	ALIGNMENT / PLAN SET	TITLE	DESCRIPTION
SR 152 (NORTH) TO ROAD 11 WYE ALTERNATIVE				
TT-C4001-D	CENTRAL VALLEY WYE	SR 152 (NORTH) TO ROAD 11 WYE ALTERNATIVE	KEY MAP	SHEET 1 OF 3
TT-C4002-D	CENTRAL VALLEY WYE	SR 152 (NORTH) TO ROAD 11 WYE ALTERNATIVE	KEY MAP	SHEET 2 OF 3
TT-C4003-D	CENTRAL VALLEY WYE	SR 152 (NORTH) TO ROAD 11 WYE ALTERNATIVE	KEY MAP	SHEET 3 OF 3
TT-B0020-D	CENTRAL VALLEY WYE	SR 152 (NORTH) TO ROAD 11 WYE ALTERNATIVE	TYPICAL SECTION	SHEET 1 OF 11
TT-B0021-D	CENTRAL VALLEY WYE	SR 152 (NORTH) TO ROAD 11 WYE ALTERNATIVE	TYPICAL SECTION	SHEET 2 OF 11
TT-B0022-D	CENTRAL VALLEY WYE	SR 152 (NORTH) TO ROAD 11 WYE ALTERNATIVE	TYPICAL SECTION	SHEET 3 OF 11
TT-B0023-D	CENTRAL VALLEY WYE	SR 152 (NORTH) TO ROAD 11 WYE ALTERNATIVE	TYPICAL SECTION	SHEET 4 OF 11
TT-B0024-D	CENTRAL VALLEY WYE	SR 152 (NORTH) TO ROAD 11 WYE ALTERNATIVE	TYPICAL SECTION	SHEET 5 OF 11
TT-B0025-D	CENTRAL VALLEY WYE	SR 152 (NORTH) TO ROAD 11 WYE ALTERNATIVE	TYPICAL SECTION	SHEET 6 OF 11
TT-B0026-D	CENTRAL VALLEY WYE	SR 152 (NORTH) TO ROAD 11 WYE ALTERNATIVE	TYPICAL SECTION	SHEET 7 OF 11
TT-B0027-D	CENTRAL VALLEY WYE	SR 152 (NORTH) TO ROAD 11 WYE ALTERNATIVE	TYPICAL SECTION	SHEET 8 OF 11
TT-B0028-D	CENTRAL VALLEY WYE	SR 152 (NORTH) TO ROAD 11 WYE ALTERNATIVE	TYPICAL SECTION	SHEET 9 OF 11
TT-B0029-D	CENTRAL VALLEY WYE	SR 152 (NORTH) TO ROAD 11 WYE ALTERNATIVE	TYPICAL SECTION	SHEET 10 OF 11
TT-B0030-D	CENTRAL VALLEY WYE	SR 152 (NORTH) TO ROAD 11 WYE ALTERNATIVE	TYPICAL SECTION	SHEET 11 OF 11
TT-B0050-D	CENTRAL VALLEY WYE	SR 152 (NORTH) TO ROAD 11 WYE ALTERNATIVE	SB TRACK SAN JOSE TO FRESNO GEOMETRY DATA	SHEET 1 OF 7
TT-B0051-D	CENTRAL VALLEY WYE	SR 152 (NORTH) TO ROAD 11 WYE ALTERNATIVE	SB TRACK SAN JOSE TO FRESNO GEOMETRY DATA	SHEET 2 OF 7
TT-B0052-D	CENTRAL VALLEY WYE	SR 152 (NORTH) TO ROAD 11 WYE ALTERNATIVE	NB TRACK SAN JOSE TO FRESNO GEOMETRY DATA	SHEET 3 OF 7
TT-B0053-D	CENTRAL VALLEY WYE	SR 152 (NORTH) TO ROAD 11 WYE ALTERNATIVE	NB TRACK SAN JOSE TO FRESNO GEOMETRY DATA	SHEET 4 OF 7
TT-B0054-D	CENTRAL VALLEY WYE	SR 152 (NORTH) TO ROAD 11 WYE ALTERNATIVE	SB TRACK MERCED TO FRESNO GEOMETRY DATA	SHEET 5 OF 7
TT-B0055-D	CENTRAL VALLEY WYE	SR 152 (NORTH) TO ROAD 11 WYE ALTERNATIVE	NB TRACK MERCED TO FRESNO GEOMETRY DATA	SHEET 6 OF 7
TT-B0056-D	CENTRAL VALLEY WYE	SR 152 (NORTH) TO ROAD 11 WYE ALTERNATIVE	SB & NB TRACK SAN JOSE TO MERCED GEOMETRY DATA	SHEET 7 OF 7
TT-D1010-D	CENTRAL VALLEY WYE	SR 152 (NORTH) TO ROAD 11 WYE ALTERNATIVE	TRACK PLAN AND PROFILE	SJD-FRE STA 5338+00.00 TO 5394+00.00
TT-D1020-D	CENTRAL VALLEY WYE	SR 152 (NORTH) TO ROAD 11 WYE ALTERNATIVE	TRACK PLAN AND PROFILE	SJD-FRE STA 5394+00.00 TO 5450+00.00
TT-D1030-D	CENTRAL VALLEY WYE	SR 152 (NORTH) TO ROAD 11 WYE ALTERNATIVE	TRACK PLAN AND PROFILE	SJD-FRE STA 5450+00.00 TO 5506+00.00
TT-D1040-D	CENTRAL VALLEY WYE	SR 152 (NORTH) TO ROAD 11 WYE ALTERNATIVE	TRACK PLAN AND PROFILE	SJD-FRE STA 5506+00.00 TO 5562+00.00
TT-D1050-D	CENTRAL VALLEY WYE	SR 152 (NORTH) TO ROAD 11 WYE ALTERNATIVE	TRACK PLAN AND PROFILE	SJD-FRE STA 5562+00.00 TO 5618+00.00
TT-D1060-D	CENTRAL VALLEY WYE	SR 152 (NORTH) TO ROAD 11 WYE ALTERNATIVE	TRACK PLAN AND PROFILE	SJD-FRE STA 5618+00.00 TO 5674+00.00
TT-D1070-D	CENTRAL VALLEY WYE	SR 152 (NORTH) TO ROAD 11 WYE ALTERNATIVE	TRACK PLAN AND PROFILE	SJD-FRE STA 5674+00.00 TO 5730+00.00
TT-D1080-D	CENTRAL VALLEY WYE	SR 152 (NORTH) TO ROAD 11 WYE ALTERNATIVE	TRACK PLAN AND PROFILE	SJD-FRE STA 5730+00.00 TO 5786+00.00
TT-D1090-D	CENTRAL VALLEY WYE	SR 152 (NORTH) TO ROAD 11 WYE ALTERNATIVE	TRACK PLAN AND PROFILE	SJD-FRE STA 5786+00.00 TO 5842+00.00
TT-D1100-D	CENTRAL VALLEY WYE	SR 152 (NORTH) TO ROAD 11 WYE ALTERNATIVE	TRACK PLAN AND PROFILE	SJD-FRE STA 5842+00.00 TO 5898+00.00
TT-D1110-D	CENTRAL VALLEY WYE	SR 152 (NORTH) TO ROAD 11 WYE ALTERNATIVE	TRACK PLAN AND PROFILE	SJD-FRE STA 5898+00.00 TO 5954+00.00
TT-D1120-D	CENTRAL VALLEY WYE	SR 152 (NORTH) TO ROAD 11 WYE ALTERNATIVE	TRACK PLAN AND PROFILE	SJD-FRE STA 5954+00.00 TO 6010+00.00
TT-D1130-D	CENTRAL VALLEY WYE	SR 152 (NORTH) TO ROAD 11 WYE ALTERNATIVE	TRACK PLAN AND PROFILE	SJD-FRE STA 6010+00.00 TO 6066+00.00
TT-D1140-D	CENTRAL VALLEY WYE	SR 152 (NORTH) TO ROAD 11 WYE ALTERNATIVE	TRACK PLAN AND PROFILE	SJD-FRE STA 6066+00.00 TO 6122+00.00
TT-D1150-D	CENTRAL VALLEY WYE	SR 152 (NORTH) TO ROAD 11 WYE ALTERNATIVE	TRACK PLAN AND PROFILE	SJD-FRE STA 6122+00.00 TO 6178+00.00
TT-D1160-D	CENTRAL VALLEY WYE	SR 152 (NORTH) TO ROAD 11 WYE ALTERNATIVE	TRACK PLAN AND PROFILE	SJD-FRE STA 6178+00.00 TO 6234+00.00
TT-D1170-D	CENTRAL VALLEY WYE	SR 152 (NORTH) TO ROAD 11 WYE ALTERNATIVE	TRACK PLAN AND PROFILE	SJD-FRE STA 6234+00.00 TO 6290+00.00
TT-D1180-D	CENTRAL VALLEY WYE	SR 152 (NORTH) TO ROAD 11 WYE ALTERNATIVE	TRACK PLAN AND PROFILE	SJD-FRE STA 6290+00.00 TO 6346+00.00
TT-D1190-D	CENTRAL VALLEY WYE	SR 152 (NORTH) TO ROAD 11 WYE ALTERNATIVE	TRACK PLAN AND PROFILE	SJD-FRE STA 6346+00.00 TO 6402+00.00

REV	DATE	BY	CHK	APP	DESCRIPTION
					08/12/2016

DESIGNED BY
C. LEMLEY
DRAWN BY
J. ALADIN
CHECKED BY
S. WILSON
IN CHARGE
C. LEMLEY
DATE
08/12/2016

RECORD SET
15% DESIGN
SUBMITTAL
NOT FOR
CONSTRUCTION



CALIFORNIA HIGH-SPEED TRAIN PROJECT
MERCED TO FRESNO SECTION
CENTRAL VALLEY WYE
ALIGNMENT AND TYPICAL SECTION PLANS
INDEX OF DRAWINGS
SHEET 8 OF 9

CONTRACT NO.
HSR08-05
DRAWING NO.
TT-B0009
SCALE
NO SCALE
SHEET NO.

INDEX OF DRAWINGS				
DRAWING NO.	SECTION	ALIGNMENT / PLAN SET	TITLE	DESCRIPTION
TT-D1200-D	CENTRAL VALLEY WYE	SR 152 (NORTH) TO ROAD 11 WYE ALTERNATIVE	TRACK PLAN AND PROFILE	SJD-FRE STA 6402+00.00 TO 6458+00.00
TT-D1210-D	CENTRAL VALLEY WYE	SR 152 (NORTH) TO ROAD 11 WYE ALTERNATIVE	TRACK PLAN AND PROFILE	SJD-FRE STA 6458+00.00 TO 6514+00.00
TT-D1220-D	CENTRAL VALLEY WYE	SR 152 (NORTH) TO ROAD 11 WYE ALTERNATIVE	TRACK PLAN AND PROFILE	SJD-FRE STA 6514+00.00 TO 6570+00.00
TT-D1230-D	CENTRAL VALLEY WYE	SR 152 (NORTH) TO ROAD 11 WYE ALTERNATIVE	TRACK PLAN AND PROFILE	SJD-FRE STA 6570+00.00 TO 6626+00.00
TT-D1240-D	CENTRAL VALLEY WYE	SR 152 (NORTH) TO ROAD 11 WYE ALTERNATIVE	TRACK PLAN AND PROFILE	SJD-FRE STA 6626+00.00 TO 6682+00.00
TT-D1250-D	CENTRAL VALLEY WYE	SR 152 (NORTH) TO ROAD 11 WYE ALTERNATIVE	TRACK PLAN AND PROFILE	SJD-FRE STA 6682+00.00 TO 6738+00.00
TT-D1260-D	CENTRAL VALLEY WYE	SR 152 (NORTH) TO ROAD 11 WYE ALTERNATIVE	TRACK PLAN AND PROFILE	SJD-FRE STA 6738+00.00 TO 6794+00.00
TT-D1270-D	CENTRAL VALLEY WYE	SR 152 (NORTH) TO ROAD 11 WYE ALTERNATIVE	TRACK PLAN AND PROFILE	SJD-FRE STA 6794+00.00 TO 6850+00.00
TT-D1280-D	CENTRAL VALLEY WYE	SR 152 (NORTH) TO ROAD 11 WYE ALTERNATIVE	TRACK PLAN AND PROFILE	SJD-FRE STA 6850+00.00 TO 6906+00.00
TT-D1290-D	CENTRAL VALLEY WYE	SR 152 (NORTH) TO ROAD 11 WYE ALTERNATIVE	TRACK PLAN AND PROFILE	SJD-FRE STA 6906+00.00 TO 6962+00.00
TT-D1300-D	CENTRAL VALLEY WYE	SR 152 (NORTH) TO ROAD 11 WYE ALTERNATIVE	TRACK PLAN AND PROFILE	SJD-FRE STA 6962+00.00 TO 7018+00.00
TT-D1310-D	CENTRAL VALLEY WYE	SR 152 (NORTH) TO ROAD 11 WYE ALTERNATIVE	TRACK PLAN AND PROFILE	SJD-FRE STA 7018+00.00 TO 7074+00.00
TT-D1320-D	CENTRAL VALLEY WYE	SR 152 (NORTH) TO ROAD 11 WYE ALTERNATIVE	TRACK PLAN AND PROFILE	SJD-FRE STA 7074+00.00 TO 7130+00.00
TT-D1330-D	CENTRAL VALLEY WYE	SR 152 (NORTH) TO ROAD 11 WYE ALTERNATIVE	TRACK PLAN AND PROFILE	SJD-FRE STA 7130+00.00 TO 7171+85.19
TT-D1410-D	CENTRAL VALLEY WYE	SR 152 (NORTH) TO ROAD 11 WYE ALTERNATIVE	TRACK PLAN	MER-FRE STA 15009+29.85 TO 15052+00.00
TT-D1411-D	CENTRAL VALLEY WYE	SR 152 (NORTH) TO ROAD 11 WYE ALTERNATIVE	TRACK PROFILE	MER-FRE STA 15009+29.85 TO 15052+00.00
TT-D1420-D	CENTRAL VALLEY WYE	SR 152 (NORTH) TO ROAD 11 WYE ALTERNATIVE	TRACK PLAN	MER-FRE STA 15052+00.00 TO 15108+00.00
TT-D1421-D	CENTRAL VALLEY WYE	SR 152 (NORTH) TO ROAD 11 WYE ALTERNATIVE	TRACK PROFILE	MER-FRE STA 15052+00.00 TO 15108+00.00
TT-D1430-D	CENTRAL VALLEY WYE	SR 152 (NORTH) TO ROAD 11 WYE ALTERNATIVE	TRACK PLAN	MER-FRE STA 15108+00.00 TO 15164+00.00
TT-D1431-D	CENTRAL VALLEY WYE	SR 152 (NORTH) TO ROAD 11 WYE ALTERNATIVE	TRACK PROFILE	MER-FRE STA 15108+00.00 TO 15164+00.00
TT-D1440-D	CENTRAL VALLEY WYE	SR 152 (NORTH) TO ROAD 11 WYE ALTERNATIVE	TRACK PLAN	MER-FRE STA 15164+00.00 TO 15220+00.00
TT-D1441-D	CENTRAL VALLEY WYE	SR 152 (NORTH) TO ROAD 11 WYE ALTERNATIVE	TRACK PROFILE	MER-FRE STA 15164+00.00 TO 15220+00.00
TT-D1450-D	CENTRAL VALLEY WYE	SR 152 (NORTH) TO ROAD 11 WYE ALTERNATIVE	TRACK PLAN	MER-FRE STA 15220+00.00 TO 15276+00.00
TT-D1451-D	CENTRAL VALLEY WYE	SR 152 (NORTH) TO ROAD 11 WYE ALTERNATIVE	TRACK PROFILE	MER-FRE STA 15220+00.00 TO 15276+00.00
TT-D1460-D	CENTRAL VALLEY WYE	SR 152 (NORTH) TO ROAD 11 WYE ALTERNATIVE	TRACK PLAN AND PROFILE	MER-FRE STA 15276+00.00 TO 15332+00.00
TT-D1470-D	CENTRAL VALLEY WYE	SR 152 (NORTH) TO ROAD 11 WYE ALTERNATIVE	TRACK PLAN AND PROFILE	MER-FRE STA 15332+00.00 TO 15388+00.00
TT-D1480-D	CENTRAL VALLEY WYE	SR 152 (NORTH) TO ROAD 11 WYE ALTERNATIVE	TRACK PLAN AND PROFILE	MER-FRE STA 15388+00.00 TO 15444+00.00
TT-D1490-D	CENTRAL VALLEY WYE	SR 152 (NORTH) TO ROAD 11 WYE ALTERNATIVE	TRACK PLAN AND PROFILE	MER-FRE STA 15444+00.00 TO 15500+00.00
TT-D1500-D	CENTRAL VALLEY WYE	SR 152 (NORTH) TO ROAD 11 WYE ALTERNATIVE	TRACK PLAN AND PROFILE	MER-FRE STA 15500+00.00 TO 15556+00.00
TT-D1510-D	CENTRAL VALLEY WYE	SR 152 (NORTH) TO ROAD 11 WYE ALTERNATIVE	TRACK PLAN AND PROFILE	MER-FRE STA 15556+00.00 TO 15612+00.00
TT-D1520-D	CENTRAL VALLEY WYE	SR 152 (NORTH) TO ROAD 11 WYE ALTERNATIVE	TRACK PLAN AND PROFILE	MER-FRE STA 15612+00.00 TO 15655+00.00
TT-D1610-D	CENTRAL VALLEY WYE	SR 152 (NORTH) TO ROAD 11 WYE ALTERNATIVE	TRACK PLAN	SJD-MER STA 36128+14.76 TO 36184+00.00
TT-D1611-D	CENTRAL VALLEY WYE	SR 152 (NORTH) TO ROAD 11 WYE ALTERNATIVE	TRACK PROFILE	SJD-MER STA 36128+14.76 TO 36184+00.00
TT-D1620-D	CENTRAL VALLEY WYE	SR 152 (NORTH) TO ROAD 11 WYE ALTERNATIVE	TRACK PLAN	SJD-MER STA 36184+00.00 TO 36240+00.00
TT-D1621-D	CENTRAL VALLEY WYE	SR 152 (NORTH) TO ROAD 11 WYE ALTERNATIVE	TRACK PROFILE	SJD-MER STA 36184+00.00 TO 36240+00.00
TT-D1630-D	CENTRAL VALLEY WYE	SR 152 (NORTH) TO ROAD 11 WYE ALTERNATIVE	TRACK PLAN	SJD-MER STA 36240+00.00 TO 36296+00.00
TT-D1631-D	CENTRAL VALLEY WYE	SR 152 (NORTH) TO ROAD 11 WYE ALTERNATIVE	TRACK PROFILE	SJD-MER STA 36240+00.00 TO 36296+00.00
TT-D1640-D	CENTRAL VALLEY WYE	SR 152 (NORTH) TO ROAD 11 WYE ALTERNATIVE	TRACK PLAN	SJD-MER STA 36296+00.00 TO 36352+00.00
TT-D1641-D	CENTRAL VALLEY WYE	SR 152 (NORTH) TO ROAD 11 WYE ALTERNATIVE	TRACK PROFILE	SJD-MER STA 36296+00.00 TO 36352+00.00
TT-D1650-D	CENTRAL VALLEY WYE	SR 152 (NORTH) TO ROAD 11 WYE ALTERNATIVE	TRACK PLAN	SJD-MER STA 36352+00.00 TO 36408+00.00
TT-D1651-D	CENTRAL VALLEY WYE	SR 152 (NORTH) TO ROAD 11 WYE ALTERNATIVE	TRACK PROFILE	SJD-MER STA 36352+00.00 TO 36408+00.00
TT-D1660-D	CENTRAL VALLEY WYE	SR 152 (NORTH) TO ROAD 11 WYE ALTERNATIVE	TRACK PLAN	SJD-MER STA 36408+00.00 TO 36457+64.82
TT-D1661-D	CENTRAL VALLEY WYE	SR 152 (NORTH) TO ROAD 11 WYE ALTERNATIVE	TRACK PROFILE	SJD-MER STA 36408+00.00 TO 36457+64.82

REV	DATE	BY	CHK	APP	DESCRIPTION
					08/12/2016

DESIGNED BY
C. LEMLEYDRAWN BY
J. ALADINCHECKED BY
S. WILSONIN CHARGE
C. LEMLEYRECORD SET
15% DESIGN
SUBMITTAL

NOT FOR
CONSTRUCTION

PARSONS



CALIFORNIA HIGH-SPEED TRAIN PROJECT
MERCED TO FRESNO SECTION
 CENTRAL VALLEY WYE
 ALIGNMENT AND TYPICAL SECTION PLANS
 INDEX OF DRAWINGS
 SHEET 9 OF 9

CONTRACT NO.
HSR08-05
 DRAWING NO.
TT-B0010
 SCALE
NO SCALE
 SHEET NO.

A		C CONTINUED		D CONTINUED		F CONTINUED	
AB	AGGREGATE BASE	CB	CONCRETE BARRIER	DF	DOUGLAS FIR	FIG	FIGURE
ABBC	ASBESTOS BONDED BITUMINOUS COATED	CBW	CONCRETE BLOCK WALL	DI	DRAINAGE INLET,	FL	FLOW LINE
ABM	AIR-BLOWN MORTAR	C-C	CENTER TO CENTER		DROP INLET	FNB	FACING NORTHBOUND TRAFFIC
ABN	ABANDON	CHSRA	CALIFORNIA HIGH SPEED RAIL	DIA	DIAMETER	FOB	FREE ON BOARD
ABUT	ABUTMENT		AUTHORITY	DIAPH	DIAPHRAGM	FOC	FACE OF CONCRETE
AC	ASPHALT CONCRETE	CHST	CALIFORNIA HIGH SPEED TRAIN	DIST	DISTANCE,	FR RD	FRONTAGE ROAD
ACB	ASPHALT CONCRETE BASE	CHSR	CALIFORNIA HIGH SPEED RAIL	DMBB	DOUBLE METAL BEAM BARRIER	FS	FAR SIDE, FINISHED SURFACE
ACP	ASBESTOS CEMENT PIPE	CG	CENTER OF GRAVITY	DR	DRIVE	FSBT	FACING SOUTHBOUND TRAFFIC
ADL	ADDED DEAD LOAD	CHNL	CHANNEL	DTBB	DOUBLE THRIE BEAM BARRIER	FTG	FOOTING
ADJ	ADJUST	CI	CAST IRON	DWY	DRIVEWAY	FWBT	FACING WESTBOUND TRAFFIC
AFES	ALTERNATIVE FLARED END SECTION	CIDH	CAST-IN-DRILLED-HOLE			FWY	FREEWAY
AHD	AHEAD	CIP	CAST-IN-PLACE,				
ALT	ALTERNATE		CAST IRON PIPE				
AM	TIME FROM MIDNIGHT TO NOON	CIPCP	CAST IN PLACE CONCRETE PIPE	E	EAST	G	GRADE,
AP	ALTERNATIVE PIPE	CISS	CAST-IN-STEEL-SHELL	EA	ACTUAL SUPERELEVATION		ACCELERATION DUE TO GRAVITY
APC	ALTERNATIVE PIPE CULVERT	CJP	COMPLETE JOINT PENETRATION	EASE	EASEMENT	GA	GAGE
APPROX	APPROXIMATE	CL	CHAIN LINK	EB	END OF BRIDGE,	GALV	GALVANIZED
APU	ALTERNATIVE PIPE UNDERDRAIN	CL-6	CHAIN LINK FENCE (6 FT)		EASTBOUND	GP	GRADING PLANE
ARS	ACCELERATION RESPONSE SPECTRUM	CL	CLASS	EC	END HORIZONTAL CURVE	GR	GUARD RAILING
AS	AGGREGATE SUBBASE	CLR	CLEAR,	ECR	END CURB RETURN	GSP	GALVANIZED STEEL PIPE
ASRP	ALUMINUM SPIRAL RIB PIPE		CLEARANCE	ED	EDGE DRAIN	GTR	GUTTER
ASSY	ASSEMBLY	CM	CORRUGATED METAL	EDC	EDGE DRAIN CLEANOUT		
ATPB	ASPHALT TREATED PERMEABLE BASE	CMP	CORRUGATED METAL PIPE	EDO	EDGE DRAIN OUTLET		
ATPM	ASPHALT TREATED PERMEABLE MATERIAL	CO	COUNTY	EDV	EDGE DRAIN VENT	H	HEIGHT
AVE	AVENUE	COL	COLUMN	ELEC	ELECTROLIER	H, HR	HOUR
AVG	AVERAGE	CONC	CONCRETE	ELECT	ELECTRIC	HD	HORIZONTAL DRAIN
@	AT	COND	CONDUIT	ELEV	ELEVATION	HDWL	HEADWALL
		CONN	CONNECTOR	EMB	EMBANKMENT	HEX HD	HEXAGONAL HEAD
		CONST	CONSTRUCT,	ENGR	ENGINEER	HMA	HOT MIXED ASPHALT
BAGR	BRIDGE APPROACH GUARD RAILING		CONSTRUCTION	EOD	EDGE OF DECK	HORIZ	HORIZONTAL
BB	BEGINNING OF BRIDGE	CONT	CONTINUOUS	EP	EDGE OF PAVEMENT	HP	HINGE POINT, HORSEPOWER
B-B	BACK-TO-BACK	COORD	COORDINATE	EQ	EQUATION	HPS	HIGH PERFORMANCE STEEL
BC	BEGIN HORIZONTAL CURVE	CP	CANDLEPOWER	ES	EDGE OF SHOULDER	HS	HIGH STRENGTH
BCR	BEGIN CURB RETURN	CR	CREEK	ETW	EDGE OF TRAVELED WAY	HST	HIGH SPEED TRAIN
BEG	BEGIN	CRCP	CONTINUOUS REINFORCED CONCRETE PAVEMENT	EU	UNBALANCED SUPERELEVATION	HSR	HIGH SPEED RAIL
BIT CTD	BITUMINOUS COATED	CRSP	CONCRETED ROCK SLOPE PROTECTION	EVC	END VERTICAL CURVE	HW	HEADWALL,
BK	BACK	CS	CURVE SPIRAL POINT	EW	ENDWALL	HWM	HIGH WATER
BKF	BACKFILL	CSP	CORRUGATED STEEL PIPE	EXC	EXCAVATION	HWY	HIGH WATER MARK
BLDG	BUILDING	CSPA	CORRUGATED STEEL PIPE ARCH	EXIST, (E)	EXISTING		
BLM	BRIDGE-LOG MILE	CTB	CEMENT TREATED BASE	EXP	EXPANSION,		
BLVD	BOULEVARD	CTPB	CEMENT TREATED PERMEABLE BASE		EXPRESSWAY		
BM	BENCH MARK	CTPM	CEMENT TREATED PERMEABLE MATERIAL	EXP JT	EXPANSION JOINT	IB	IMPORTED BORROW
BOT	BOTTOM	CTRS	CENTERS	EXT	EXTERIOR	ID	INSIDE DIAMETER
BR	BRIDGE	CULV	CULVERT			IF	INSIDE FACE
BRG	BEARING	¢	CENTERLINE			INT	INTERIOR
BTU	BRITISH THERMAL UNIT			F & C	FRAME AND COVER	INV	INVERT
BVC	BEGIN VERTICAL CURVE			F & G	FRAME AND GRATE	IRR	IRRIGATION
BW	BARBED WIRE	D	DEPTH	FB	FLOOR BEAM		
		DD	DOWNDRAIN	FDN	FOUNDATION		
		DBL	DOUBLE	FEBT	FACING EASTBOUND TRAFFIC	JCT	JUNCTION
CAA	CABLE ANCHOR ASSEMBLY	DEG	DEGREE	FES	FLARED END SECTION	JP	JOINT POLE
CAP	CORRUGATED ALUMINUM PIPE	DEL	DELINEATOR	FF	FILTER FABRIC	JPCP	JOINTED PLAIN CONCRETE PAVEMENT
CAPA	CORRUGATED ALUMINUM PIPE ARCH	DET	DETAIL, DETOUR	FG	FINISHED GRADE	JS	JUNCTION STRUCTURE
CAS	CONSTRUCTION AREA SIGN			FH	FIRE HYDRANT	JT	JOINT

DESIGNED BY E. BALTAY	RECORD SET 15% DESIGN SUBMITTAL	NOT FOR CONSTRUCTION	PARSONS	CALIFORNIA HIGH-SPEED RAIL AUTHORITY	CALIFORNIA HIGH-SPEED TRAIN PROJECT SAN JOSE TO MERCED SEGMENT	CONTRACT NO. HSR08-05
DRAWN BY E. BALTAY						DRAWING NO. TT-B0011
CHECKED BY KRIT W.						SCALE NO SCALE
IN CHARGE D. WEMMER						SHEET NO.
DATE 08/12/2016						
REV	DATE	BY	CHK	APP	DESCRIPTION	

ABBREVIATIONS
SHEET 1 OF 2

16-AUG-2010@9:14	MF-TT-B0011.dgn
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O		P CONTINUED		S CONTINUED		T CONTINUED	
OC	OVERCROSSING	PVI	POINT OF VERTICAL INTERSECTION	SJM	SAN JOSE TO MERCED	TS	TRANSVERSE, TRAFFIC SIGNAL,
OCS	OVERHEAD CONTACT SYSTEM	PVMT	PAVEMENT	SVJ	SAN JOAQUIN VALLEY		TUBULAR STEEL, TANGENT SPIRAL POINT
OD	OUTSIDE DIAMETER	PVT	POINT OF VERTICAL TANGENT	S	STATION LINE	TYP	TYPICAL
OF	OUTSIDE FACE			SM	SELECTED MATERIAL		
OG	ORIGINAL GROUND			SPEC	SPECIAL, SPECIFICATIONS		
OGAC	OPEN GRADED ASPHALT CONCRETE	QTY	QUANTITY	SPP	SLOTTED PLASTIC PIPE	UC	UNDERCROSSING
OH	OVERHEAD			SR	STATE ROUTE	UD	UNDERDRAIN
O-O	OUT TO OUT			SRS	STANDALONE RADIO SITE	UON	UNLESS OTHERWISE NOTED
OPP	OPPOSITE	R	RADIUS	SS	SLOPE STAKE, SUBSTATION	UP	UNDERPASS
		R & D	REMOVE AND DISPOSE	SSBM	STRAP AND SADDLE BRACKET METHOD	UPRR	UNION PACIFIC RAILROAD
		R & S	REMOVE AND SALVAGE	SSD	STRUCTURAL SECTION DRAIN	UXO	UNIVERSAL CROSSOVER
P				SSPA	STRUCTURAL STEEL PLATE ARCH		
P	PAGE	R/C	RATE OF CHANGE	SSPP	STRUCTURAL STEEL PLATE PIPE	V	
PAP	PERFORATED ALUMINUM PIPE	RCA	REINFORCED CONCRETE ARCH	SSPPA	STRUCTURAL STEEL PLATE PIPE ARCH		DESIGN SPEED, VALVE
PB	PULL BOX, PHASE BREAK	RCB	REINFORCED CONCRETE BOX	SSRP	STEEL SPIRAL RIB PIPE	VAR	VARIABLE
PC	POINT OF CURVATURE, PRECAST	RCP	REINFORCED CONCRETE PIPE	ST	STREET, SPIRAL TANGENT POINT	VC	VERTICAL CURVE
PCC	POINT OF COMPOUND CURVE,	RCPA	REINFORCED CONCRETE PIPE ARCH	STA	STATION	VCP	VITRIFIED CLAY PIPE
	PORTLAND CEMENT CONCRETE	RD	ROAD	STBB	SINGLE THRIE BEAM BARRIER	VERT	VERTICAL
PCP	PERFORATED CONCRETE PIPE,	REINF	REINFORCED, REINFORCEMENT,	STD	STANDARD	VIA	VIADUCT
	PRESTRESSED CONCRETE PIPE		REINFORCING	STR	STRUCTURE	VOL	VOLUME
PCVC	POINT OF COMPOUND VERTICAL CURVE	REL	RELOCATE	SURF	SURFACING		
PED	PEDESTRIAN	REPL	REPLACEMENT	SW	SIDEWALK, SOUND WALL		
PED OC	PEDESTRIAN OVERCROSSING	RET	RETAINING	SWR	SEWER	W	WEST, WIDTH
PED UC	PEDESTRIAN UNDERCROSSING	REV	REVISED	SWS	SWITCHING STATION	WB	WESTBOUND
PERM MTL	PERMEABLE MATERIAL	RDWY	ROADWAY	SYM	SYMMETRICAL	WCB	WORLD COORDINATE BEARING
PG	PROFILE GRADE	RM	ROAD-MIXED	S4S	SURFACE 4 SIDES	WH	WEEP HOLE
PG&E	PACIFIC GAS AND ELECTRIC	RP	RADIUS POINT,			WM	WIRE MESH
PI	POINT OF INTERSECTION		REFERENCE POINT			WS	WATER SURFACE
PITO	POINT OF INTERSECTION TURNOUT	RR	RAILROAD	T	SEMI-TANGENT	WSP	WELDED STEEL PIPE
PJP	PARTIAL JOINT PENETRATION	RSP	ROCK SLOPE PROTECTION	TAB	TABLET	WT	WEIGHT
P, PL	PLATE	RT	RIGHT	TAN	TANGENT	WV	WATER VALVE
P/L	PROPERTY LINE	RTE	ROUTE	TBB	THRIE BEAM BARRIER	WW	WINGWALL
PM	POST MILE,	RW	REDWOOD,	TBD	TO BE DETERMINED	WWLOL	WINGWALL LAYOUT LINE
	TIME FROM NOON TO MIDNIGHT		RETAINING WALL	TBR	TIMBER		
PN	PAVING NOTCH	R/W	RIGHT-OF-WAY	TC	TOP OF CURB, TRAIN CONTROL	X SEC	CROSS SECTION
POB	POINT OF BEGINNING	RWY	RAILWAY	TCB	TRAFFIC CONTROL BOX	XING	CROSSING
POC	POINT OF HORIZONTAL CURVE			TCE	TEMPORARY CONSTRUCTION EASEMENT	XO	Crossover
POE	POINT OF END			TEL	TELEPHONE		
POT	POINT OF TANGENT	S	SOUTH, SUPPLEMENT	TEMP	TEMPORARY		
POVC	POINT OF VERTICAL CURVE	SAE	STRUCTURE APPROACH EMBANKMENT	TG	TOP OF GRADE		
PP	PIPE PILE, PLASTIC PIPE,	SALV	SALVAGE	TM	TECHNICAL MEMORANDUM	YR	YEAR
	POWER POLE	SAPP	STRUCTURAL ALUMINUM PLATE PIPE	TO	TURNOUT	YRS	YEARS
PPL	PREFORMED PERMEABLE LINER	SB	SOUTHBOUND	TOT	TOTAL		
PPP	PERFORATED PLASTIC PIPE	SC	SAND CUSHION, SPIRAL CURVE POINT	TP	TELEPHONE POLE		
PRC	POINT OF REVERSE CURVE	SCSP	SLOTTED CORRUGATED STEEL PIPE	TPB	TREATED PERMEABLE BASE		
PRF	PAVEMENT REINFORCING FABRIC	SD	STORM DRAIN	TPF	TRACTION POWER FACILITY		
PRVC	POINT OF REVERSE VERTICAL CURVE	SEC	SECOND, SECTION	TPM	TREATED PERMEABLE MATERIAL		
PS&E	PLANS, SPECIFICATIONS AND ESTIMATES	SEP	SEPARATION	TPSS	TRACTION POWER SUBSTATION		
PS, P/S	POINT OF SWITCH, PRESTRESSED,	SG	SUBGRADE	T/R	TOP OF RAIL		
	PARALLELING STATION	SHLD	SHOULDER	TRANS	TRANSITION		
PSP	PERFORATED STEEL PIPE	SHT	SHEET	TRK	TRACK		
PT	POINT OF TANGENCY	SIM	SIMILAR				
PVC	POLYVINYL CHLORIDE,	SJD	SAN JOSE DIRIDON STATION				
	POINT OF VERTICAL CURVE						

DESIGNED BY E. BALTAY	DRAWN BY E. BALTAY	RECORD SET 15% DESIGN SUBMITTAL	NOT FOR CONSTRUCTION		
DRAWN BY E. BALTAY	CHECKED BY KRIT W.				
IN CHARGE D. WEMMER	DATE 08/12/2016				
REV	DATE	BY	CHK	APP	DESCRIPTION




CALIFORNIA HIGH-SPEED TRAIN PROJECT SAN JOSE TO MERCED SEGMENT

ABBREVIATIONS
SHEET 2 OF 2

CONTRACT NO. HSR08-05
DRAWING NO. TT-B0012
SCALE NO SCALE
SHEET NO.

WYE CONNECTIONS SCHEMATIC

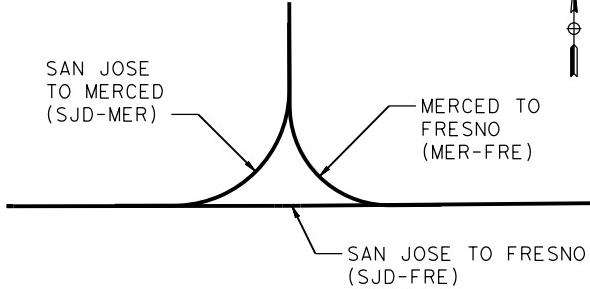

TO SACRAMENTO




TO SAN JOSE



MERCED COUNTY

MERCED COUNTY

MADERA COUNTY

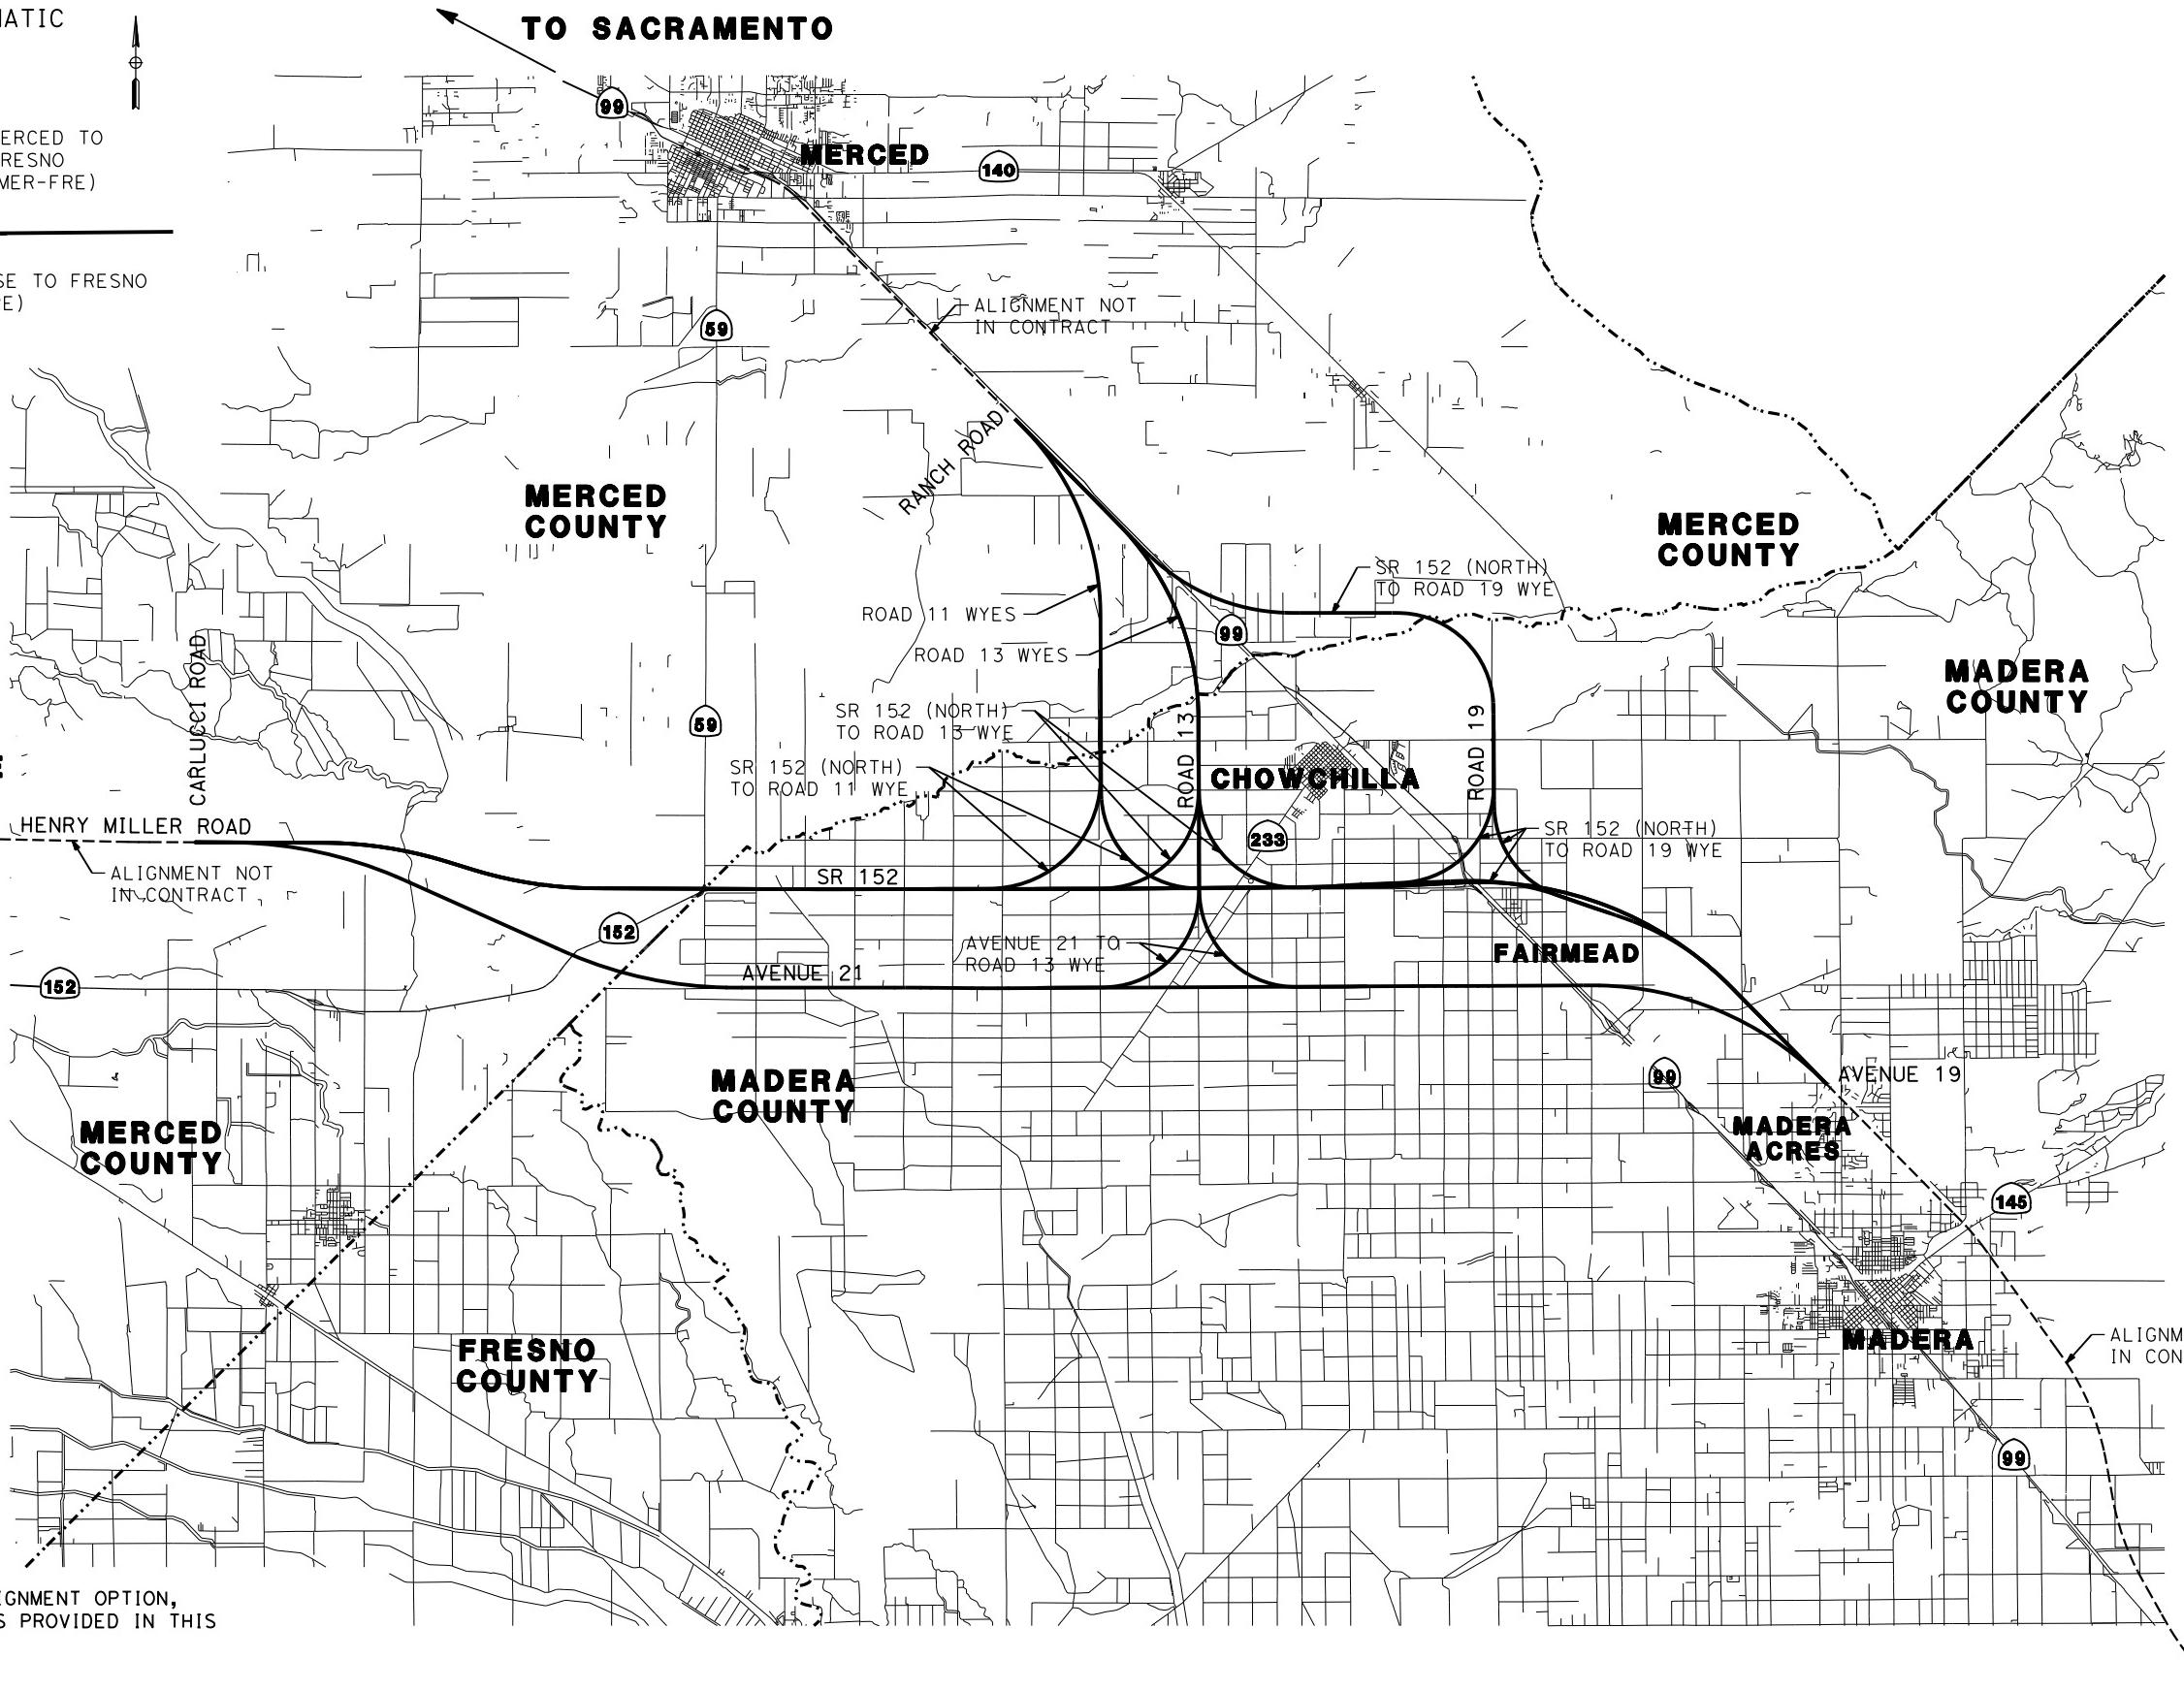

CONTRACT NO.
HSR08-05
DRAWING NO.
TT-B4000
SCALE
NTS
SHEET NO.



CALIFORNIA HIGH-SPEED TRAIN PROJECT
MERCED TO FRESNO SECTIONCENTRAL VALLEY WYE
ALIGNMENT AND TYPICAL SECTION PLANS
LOCATION PLAN

RECORD SET
15% DESIGN
SUBMITTAL
NOT FOR
CONSTRUCTION



PARSONS

CALIFORNIA
HIGH-SPEED RAIL AUTHORITY

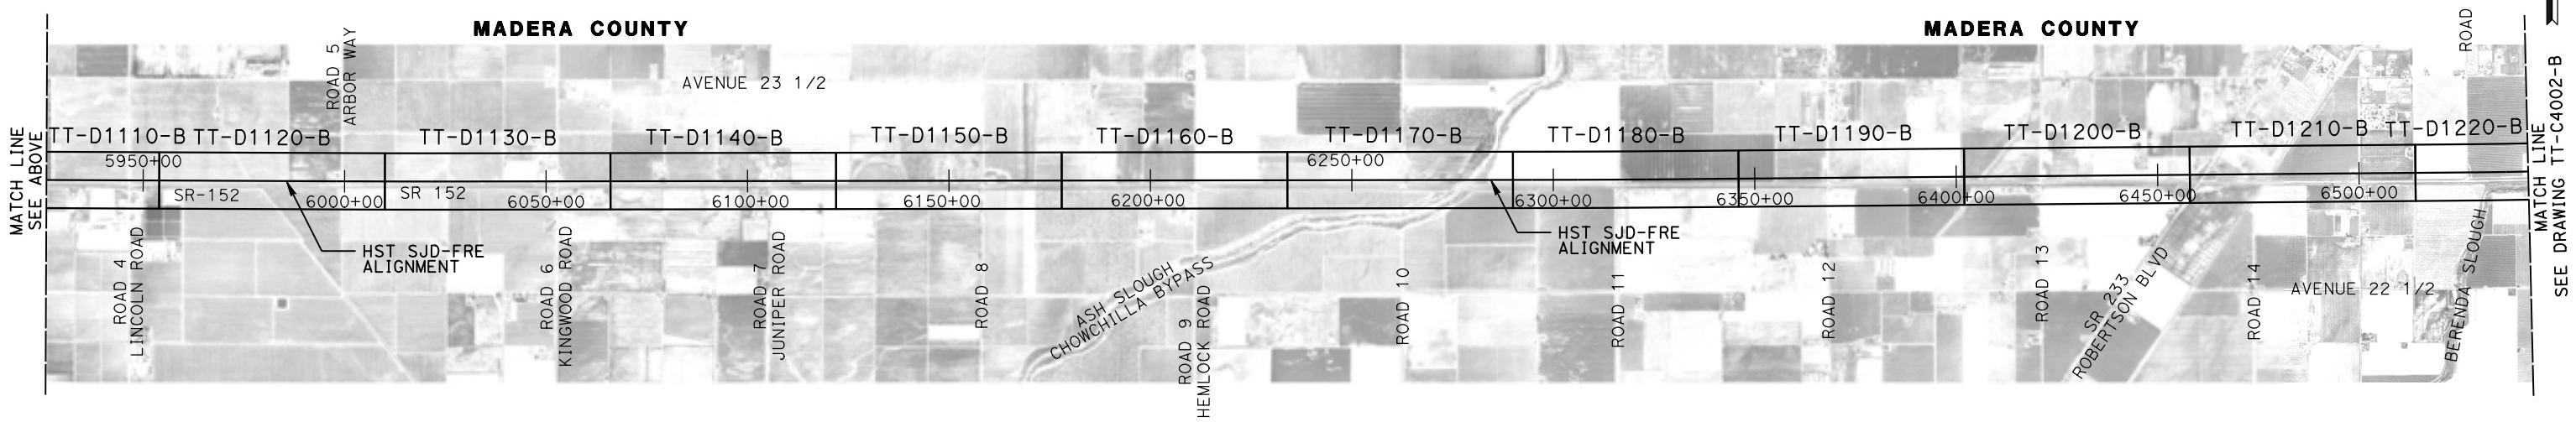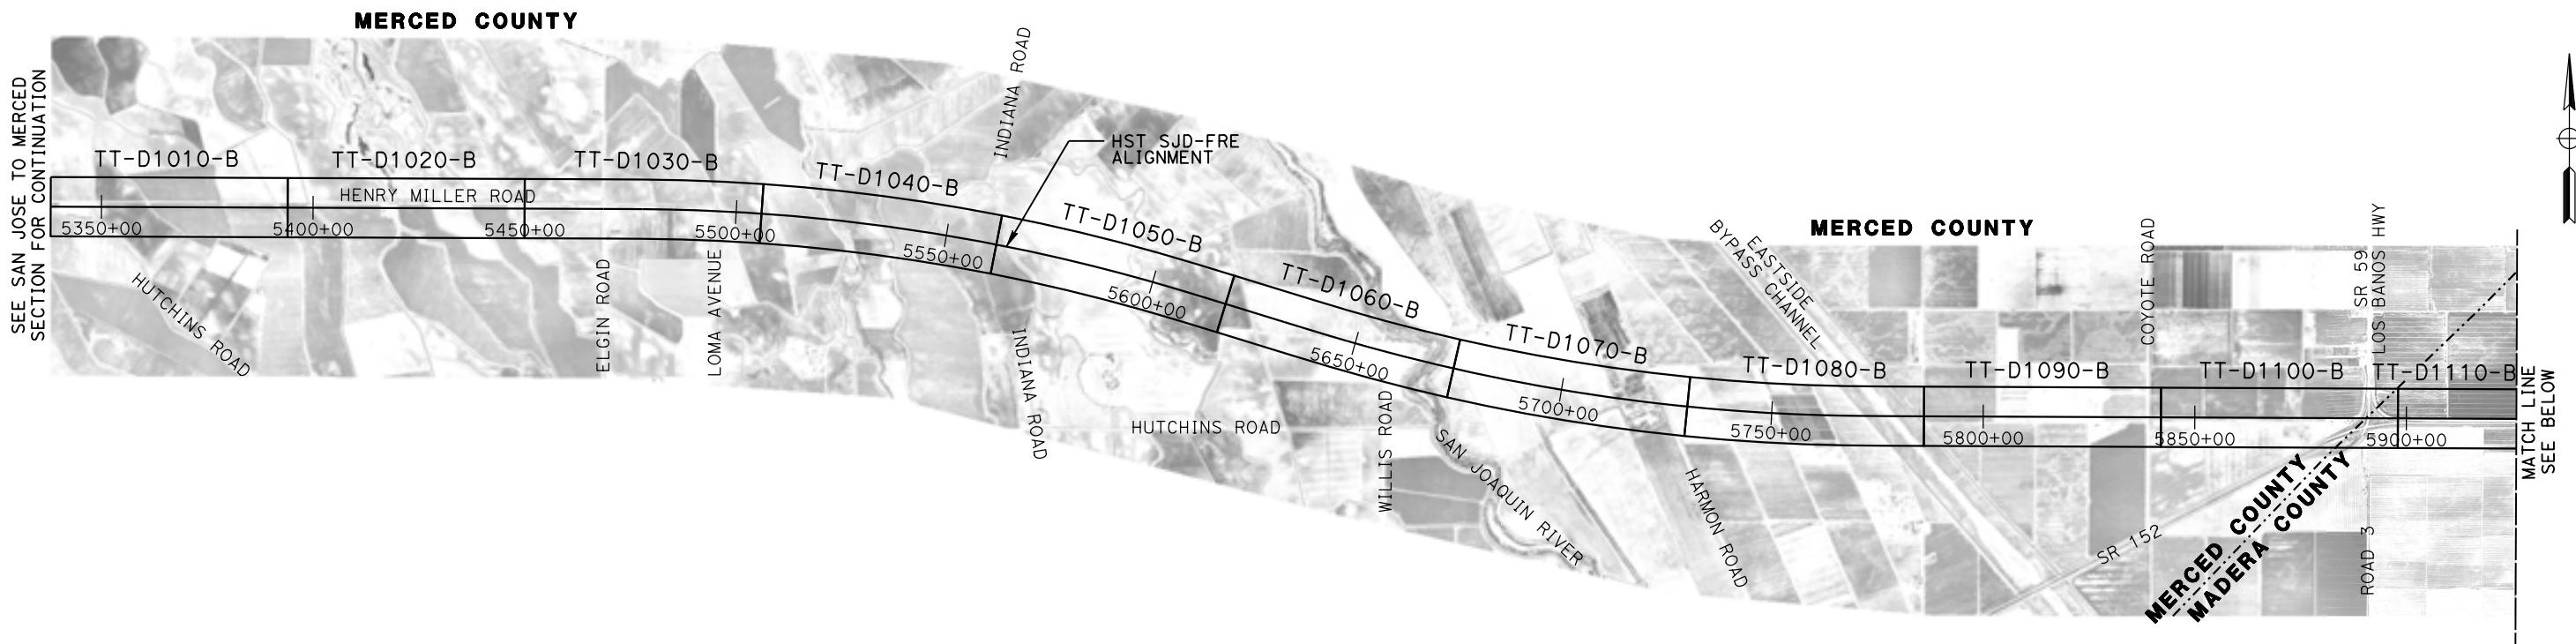

MF-TT-C4001-B.dwg

17-MAR-2016 1:26

p00513A

REV	DATE	BY	CHK	APP	DESCRIPTION
					03/18/2016

DESIGNED BY D. OLIVETI	RECORD SET 15% DESIGN SUBMITTAL	 PARSONS	 CALIFORNIA HIGH-SPEED RAIL AUTHORITY
DRAWN BY D. OLIVETI			
CHECKED BY N. OUM			
IN CHARGE C. LEMLEY			
DATE 03/18/2016	NOT FOR CONSTRUCTION		

CALIFORNIA HIGH-SPEED TRAIN PROJECT
MERCED TO FRESNO SECTION
CENTRAL VALLEY WYE
SR 152 (NORTH) TO ROAD 19 WYE ALTERNATIVE
KEY MAP
SHEET 1 OF 3

CONTRACT NO.
HSR08-05
DRAWING NO.
TT-C4001-B
SCALE
N. T. S.
SHEET NO.

P0042226 03-MAR-2016 06:35

F - 1 | - C4002-B.dgn


0.3-M						
00042226						
REV	DATE	BY	CHK	APP		

DESCRIPTION	D. C.
	DRAWN
	D. C.
	CHECKED
	N. C.
	IN CHARGE
	C. L.
DESCRIPTION	DATE 03/

**RECORD S
15% DESI
SUBMITTA
NOT FO
CONSTRUCT**



PARSONS

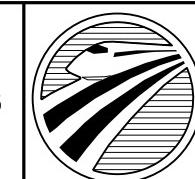

CALIFORNIA
HIGH-SPEED RAIL AUTHORITY

**CALIFORNIA HIGH-SPEED TRAIN PROJECT
MERCED TO FRESNO SECTION**

MERCED TO VALLEY WYE
CENTRAL VALLEY WYE
SR 152 (NORTH) TO ROAD 19 WYE ALTERNATIVE
KEY MAP
SHEET 2 OF 3

CONTRACT NO.
HSR08-05
DRAWING NO.
TT-C4002-B
SCALE
N. T. S.
SHEET NO.


SECTION A-A

TANGENT


STATION SJD-FRE 5338+00.00 TO 5468+71.17
 STATION SJD-FRE 5617+79.47 TO 5632+50.67
 STATION SJD-FRE 5785+40.00 TO 5898+00.00
 STATION SJD-FRE 6651+60.92 TO 6657+54.00
 STATION SJD-FRE 6658+94.00 TO 6692+54.93
 STATION SJD-FRE 6868+50.00 TO 6875+46.72
 STATION SJD-FRE 7027+24.72 TO 7128+15.53
 STATION SJD-FRE 7130+55.53 TO 7195+36.56
 STATION SJD-FRE 7197+76.56 TO 7322+45.56

SUPERELEVATED


STATION SJD-FRE 5468+71.17 TO 5617+79.47
 STATION SJD-FRE 5632+50.67 TO 5656+47.00
 STATION SJD-FRE 5657+77.00 TO 5664+90.00
 STATION SJD-FRE 5672+70.00 TO 5683+29.93
 STATION SJD-FRE 5689+20.00 TO 5723+00.00
 STATION SJD-FRE 5725+40.00 TO 5769+80.00
 STATION SJD-FRE 6692+54.93 TO 6704+37.00
 STATION SJD-FRE 6725+98.00 TO 6790+61.00
 STATION SJD-FRE 6793+01.00 TO 6800+39.93
 STATION SJD-FRE 6875+46.72 TO 7027+24.72

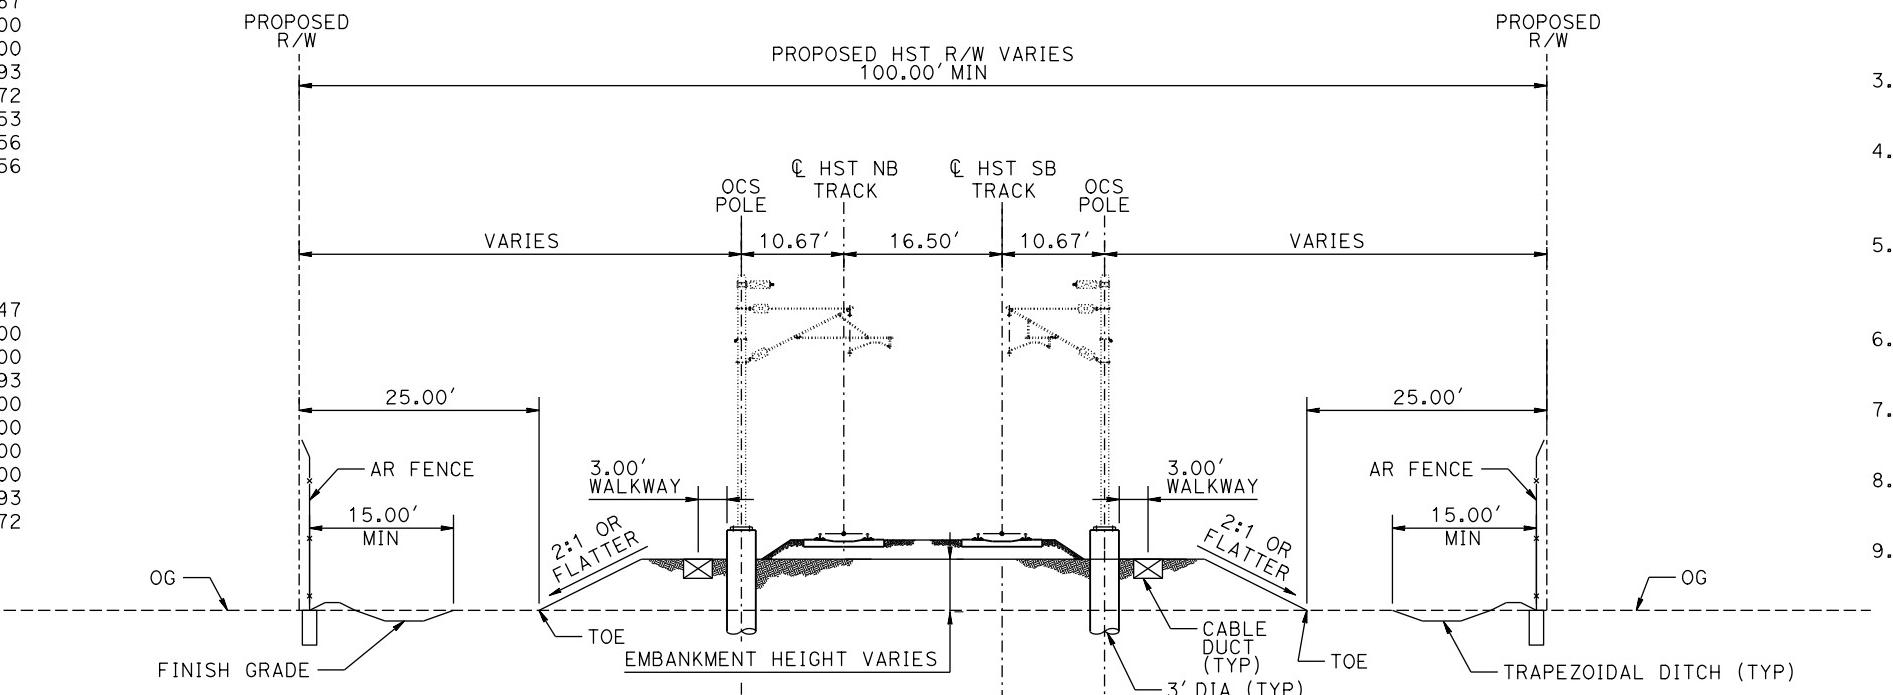

**SECTION A-A
TWO TRACKS ON EMBANKMENT**

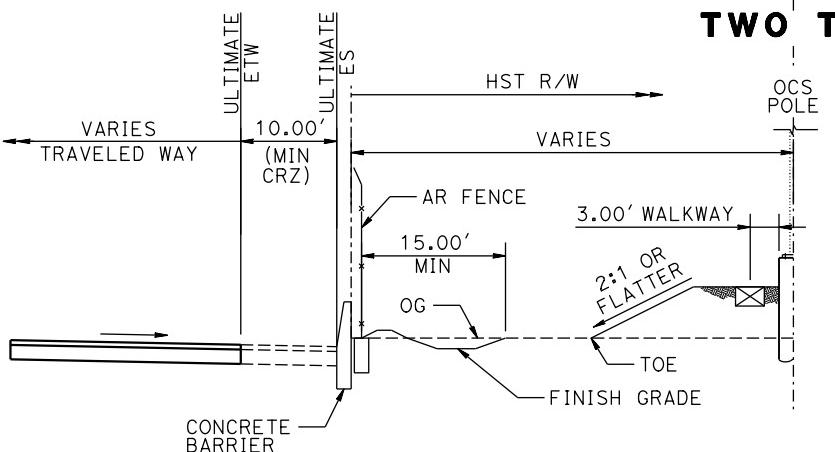

**SUBSECTION A-A
HST ADJACENT TO ROADWAY**
WITH 10' CLEAR RECOVERY ZONE (CRZ)

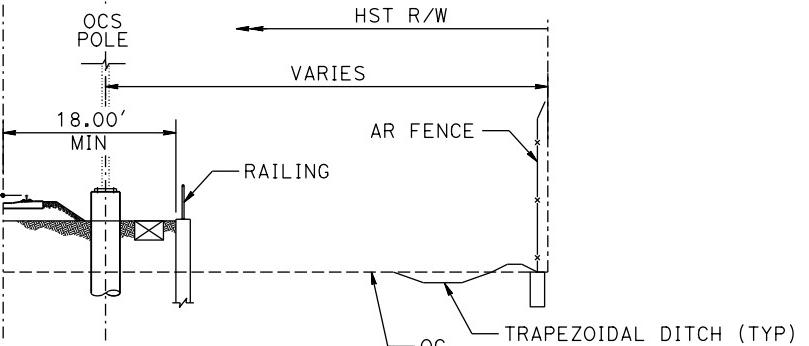

**SUBSECTION A-A
HST WITH RETAINING WALL**

GENERAL TYPICAL SECTION NOTES:

1. TRACK, OCS POLES AND FOUNDATIONS, CABLE DUCTS AND DRAINAGE ARE SCHEMATIC AND DO NOT REPRESENT DESIGN.
2. RIGHT-OF-WAY REQUIRED FOR THE HST GUIDEWAY WILL DEPEND UPON CONDITIONS ALONG THE ALIGNMENT, INCLUDING, BUT NOT LIMITED TO, TERRAIN WHERE CUT/FILL SLOPES, RETAINING STRUCTURES, AND ACCESS ARE REQUIRED.
3. SEE STRUCTURES, VIADUCT AND TUNNEL PLANS FOR DETAILED CROSS SECTIONS OF STRUCTURES.
4. RIGHT-OF-WAY TO BE PLACED A MINIMUM OF 15.00' FROM EDGE OF PIER FOUNDATION OR STRUCTURE DECK.
5. BALLASTED TRACK STRUCTURE AT ALL LOCATIONS EXCEPT ON STRUCTURES OVER 1000 FEET IN LENGTH.
6. TANGENT AND SUPERELEVATED SECTION IS FOR THE PURPOSE OF ILLUSTRATION ONLY.
7. ALL STATION LIMITS ARE TAKEN FROM SOUTHBOUND ALIGNMENT STATIONING.
8. SEE CIVIL AND GRADE SEPARATION PLANS FOR PERMANENT ACCESS AND UTILITY EASEMENTS.
9. 6 FEET BENCH REQUIRED FOR EMBANKMENT HEIGHT OVER 30' (NOT SHOWN).

SECTION B-B

TANGENT

STATION SJD-FRE 5780+47.93 TO 5785+40.00
 STATION SJD-FRE 6274+90.00 TO 6284+20.00
 STATION SJD-FRE 6657+54.00 TO 6658+94.00
 STATION SJD-FRE 7128+15.53 TO 7130+55.53
 STATION SJD-FRE 7195+36.56 TO 7197+76.56

SUPERELEVATED

STATION SJD-FRE 5656+47.00 TO 5657+77.00
 STATION SJD-FRE 5664+90.00 TO 5672+70.00
 STATION SJD-FRE 5683+29.93 TO 5689+20.00
 STATION SJD-FRE 5723+00.00 TO 5725+40.00
 STATION SJD-FRE 5769+80.00 TO 5780+47.93
 STATION SJD-FRE 6543+20.00 TO 6549+60.00
 STATION SJD-FRE 6704+37.00 TO 6725+98.00
 STATION SJD-FRE 6790+61.00 TO 6793+01.00
 STATION MER-FRE 15006+95.00 TO 15014+70.00*
 STATION MER-FRE 15031+42.98 TO 15035+59.98*

*TYPICAL SECTION IS VIEWED IN THE DIRECTION OF DECREASING STATIONING


SECTION C-C

TANGENT

STATION SJD-FRE 5898+00.00 TO 5944+06.22
 STATION SJD-FRE 5948+60.10 TO 5997+98.36
 STATION SJD-FRE 6033+22.76 TO 6264+37.13
 STATION SJD-FRE 6334+52.80 TO 6524+45.15
 STATION SJD-FRE 6562+75.24 TO 6570+00.00

SUPERELEVATED

STATION SJD-FRE 5997+98.36 TO 6033+22.76
 STATION SJD-FRE 6304+92.40 TO 6334+52.80
 STATION SJD-FRE 6524+45.14 TO 6543+20.00
 STATION SJD-FRE 6549+60.00 TO 6562+75.24

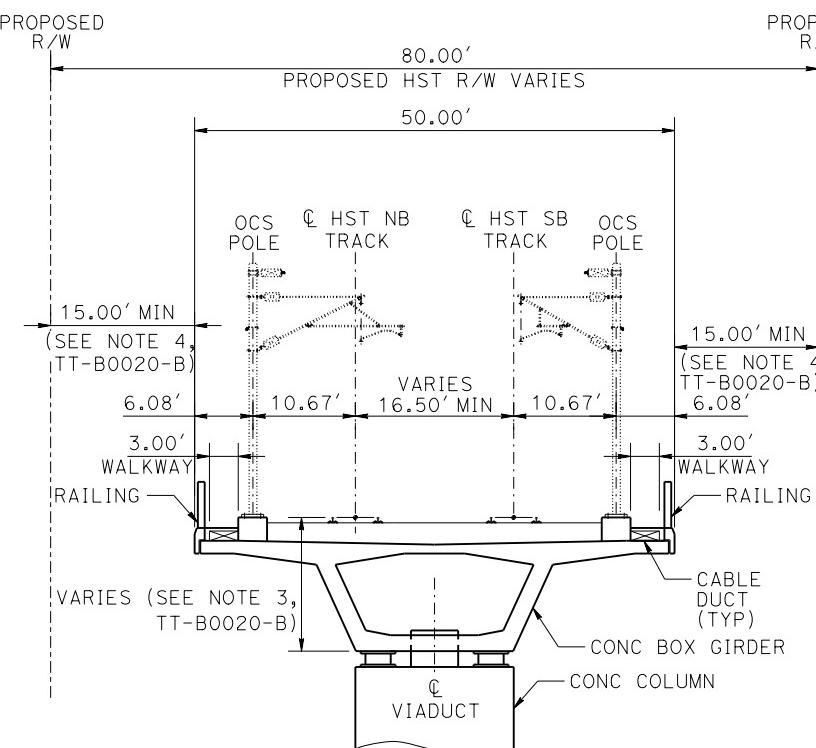

NOTES:

- SEE DRAWING TT-B0020-B FOR GENERAL TYPICAL SECTION NOTES.
- FOR LOCATIONS WHERE 52' MINIMUM SEPARATION BETWEEN HIGHWAY'S ETW AND THE HST FENCE IS NOT ACHIEVABLE, A CONCRETE BARRIER WILL BE PROVIDED.

**SECTION B-B
TWO TRACKS ON AERIAL STRUCTURE**


PROPOSED R/W

PROPOSED HST R/W VARIES 130' MIN

PROPOSED R/W

EXIST SR 152 R/W VARIES

EXIST R/W

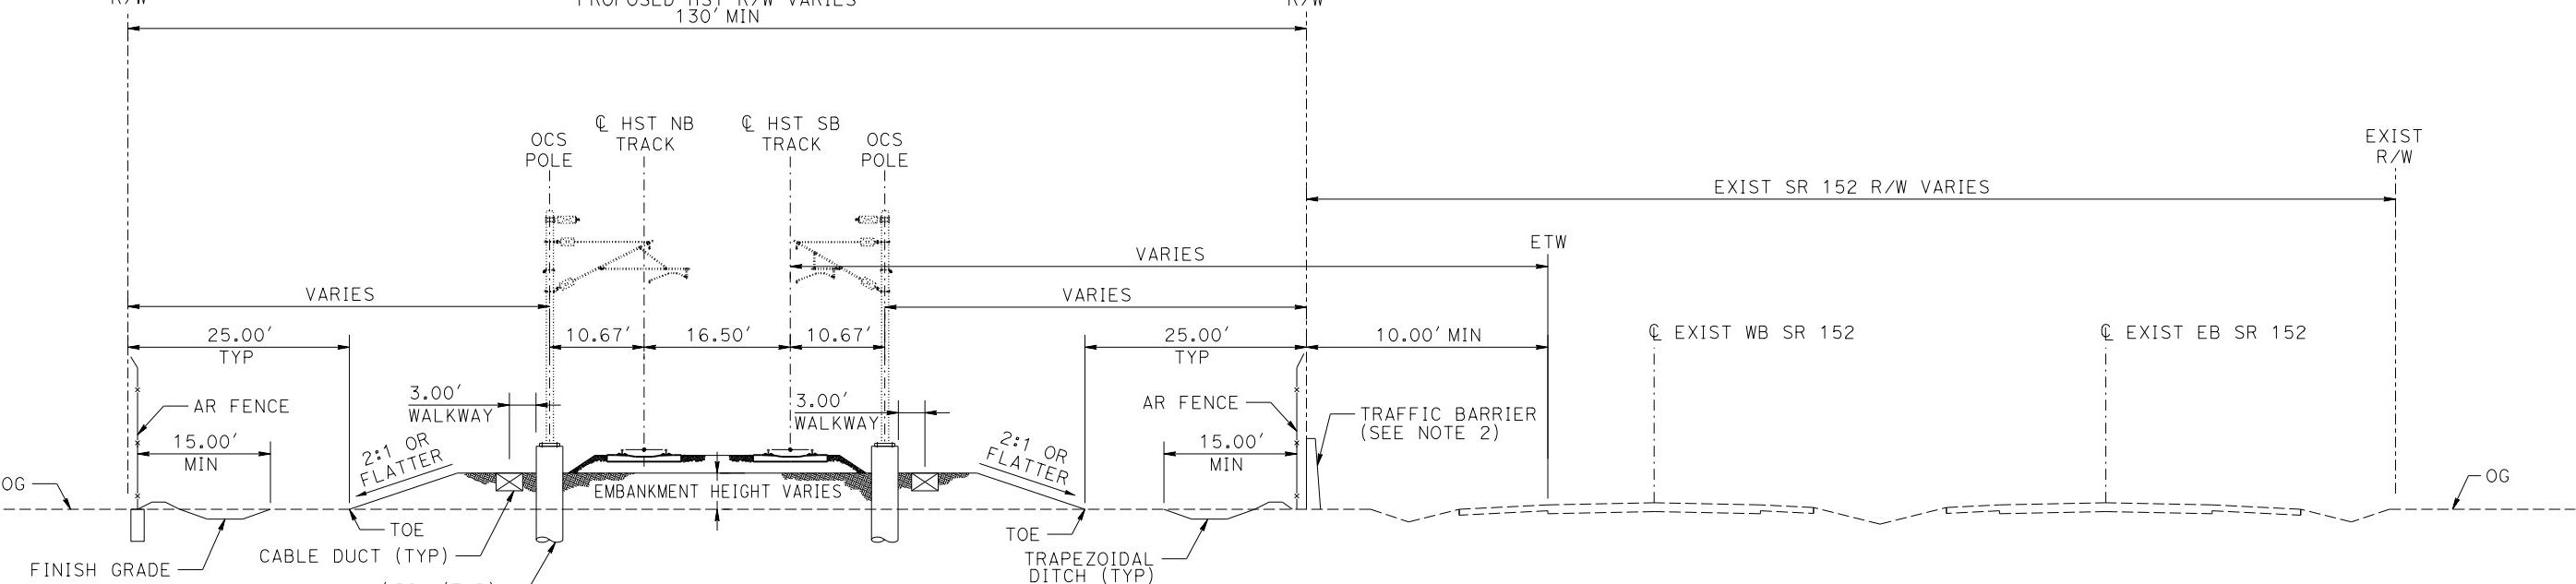

**SECTION C-C
TWO TRACKS ON EMBANKMENT ADJACENT TO SR 152**

REV	DATE	BY	CHK	APP	DESCRIPTION

DESIGNED BY
D. OLIVETI
 DRAWN BY
D. OLIVETI
 CHECKED BY
N. OUM
 IN CHARGE
C. LEMLEY
 DATE
 10/30/2015

RECORD SET
 15% DESIGN
 SUBMITTAL
 NOT FOR
 CONSTRUCTION



**CALIFORNIA HIGH-SPEED TRAIN PROJECT
MERCED TO FRESNO SECTION**
 CENTRAL VALLEY WYE
 SR 152 (NORTH) TO ROAD 19 WYE ALTERNATIVE
 TYPICAL SECTION
 SHEET 2 OF 12

CONTRACT NO.
HSR08-05
 DRAWING NO.
TT-B0021-B
 SCALE
N.T.S.
 SHEET NO.
2

SECTION D-D

TANGENT


STATION SJD-FRE 5944+06.22 TO 5948+60.10
 STATION SJD-FRE 6264+37.13 TO 6274+90.00
 STATION SJD-FRE 6284+20.00 TO 6294+70.18

SUPERELEVATED

STATION SJD-FRE 6294+70.18 TO 6304+92.40

NOTES:

- SEE DRAWING TT-B0020-B FOR GENERAL TYPICAL SECTION NOTES.
- FOR LOCATIONS WHERE 52' MINIMUM SEPARATION BETWEEN HIGHWAY ETW AND THE HST FENCE IS NOT ACHIEVABLE, A CONCRETE BARRIER WILL BE PROVIDED.

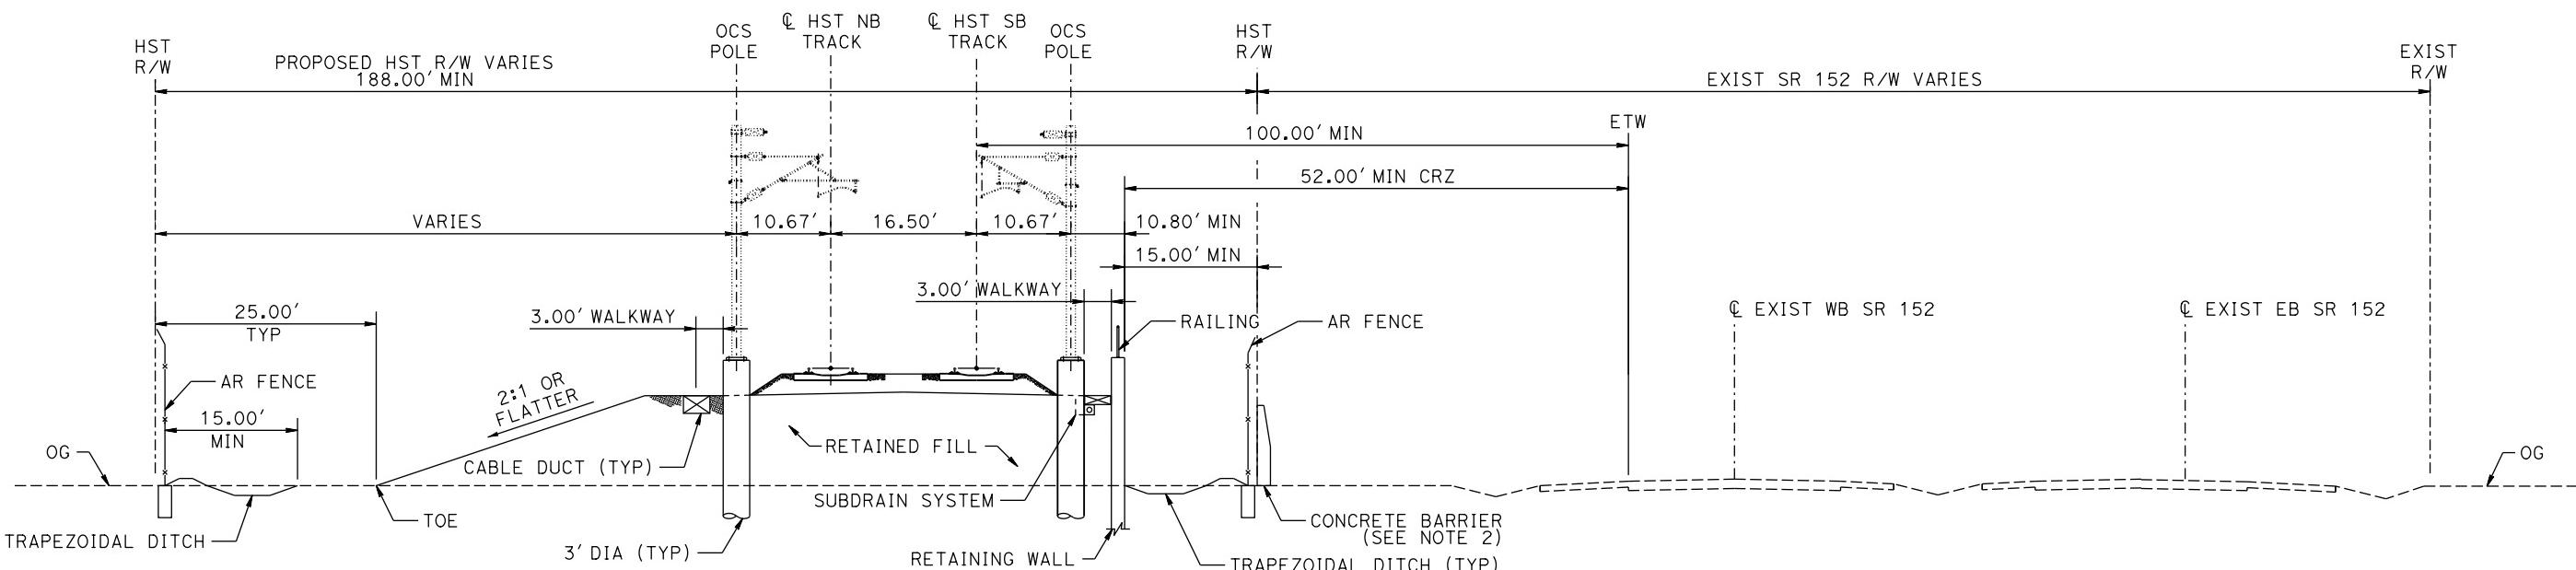


SECTION D-D
TWO TRACKS ON RETAINED FILL ADJACENT TO AN INTERCHANGE

REV	DATE	BY	CHK	APP	DESCRIPTION	DESIGNED BY D. OLIVETI	DRAWN BY D. OLIVETI	CHECKED BY N. OUM	IN CHARGE C. LEMLEY	DATE 03/18/2016

RECORD SET
15% DESIGN
SUBMITTAL
**NOT FOR
CONSTRUCTION**



PARSONS

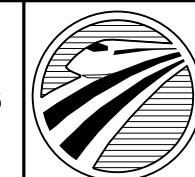

CALIFORNIA
HIGH-SPEED RAIL AUTHORITY

CALIFORNIA HIGH-SPEED TRAIN PROJECT
MERCED TO FRESNO SECTION
 CENTRAL VALLEY WYE
 SR 152 (NORTH) TO ROAD 19 WYE ALTERNATIVE
 TYPICAL SECTION
 SHEET 3 OF 12

CONTRACT NO.
HSR08-05
 DRAWING NO.
TT-B0022-B
 SCALE
N.T.S.
 SHEET NO.

SECTION E-E


TANGENT

STATION SJD-FRE 6645+64.50 TO 6651+60.92

SUPERELEVATED

STATION SJD-FRE 6800+27.00 TO 6804+36.00
 STATION MER-FRE 14780+10.00 TO 14783+60.00*
 STATION MER-FRE 14908+46.40 TO 14918+54.00
 STATION SJD-MER 36646+00.00 TO 36651+50.49
 STATION SJD-MER 36785+85.58 TO 36795+77.67

*TYPICAL SECTION IS VIEWED
IN THE DIRECTION OF
DECREASING STATIONING

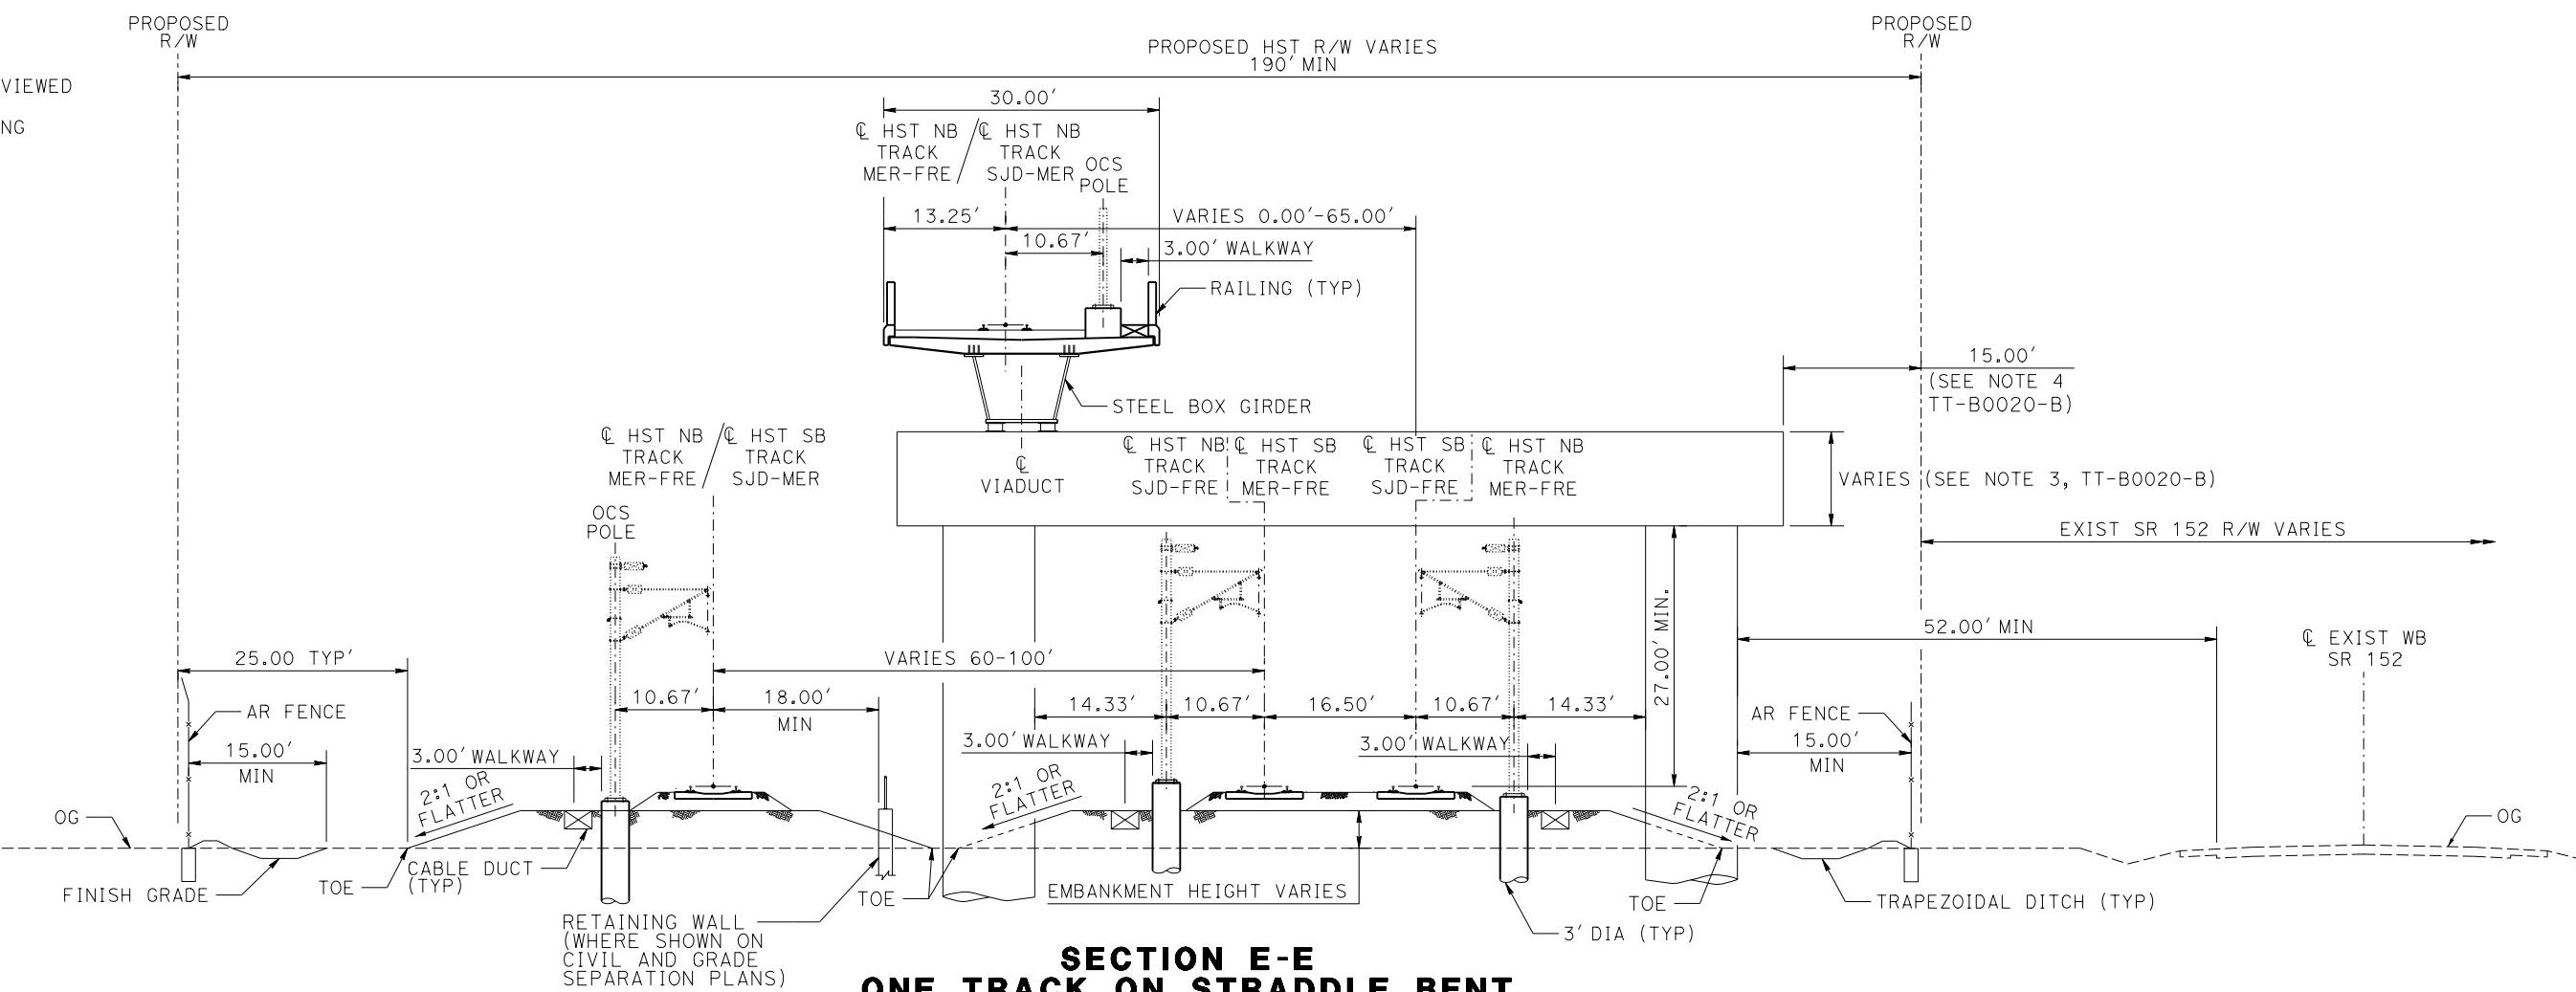

NOTES:

- SEE DRAWING TT-B0020-B FOR GENERAL TYPICAL SECTION NOTES.

REV	DATE	BY	CHK	APP	DESCRIPTION

DESIGNED BY
D. OLIVETI
DRAWN BY
M. TACTAY
CHECKED BY
N. OUM
IN CHARGE
C. LEMLEY
DATE
10/30/2015

RECORD SET
15% DESIGN
SUBMITTAL
**NOT FOR
CONSTRUCTION**




PARSONS



**CALIFORNIA HIGH-SPEED TRAIN PROJECT
MERCED TO FRESNO SECTION**
CENTRAL VALLEY WYE
SR 152 (NORTH) TO ROAD 19 WYE ALTERNATIVE
TYPICAL SECTION
SHEET 4 OF 12

CONTRACT NO.
HSR08-05
DRAWING NO.
TT-B0023-B
SCALE
N.T.S.
SHEET NO.

NOTES:
1. SEE DRAWING TT-B0020-B FOR
GENERAL TYPICAL SECTION
NOTES.

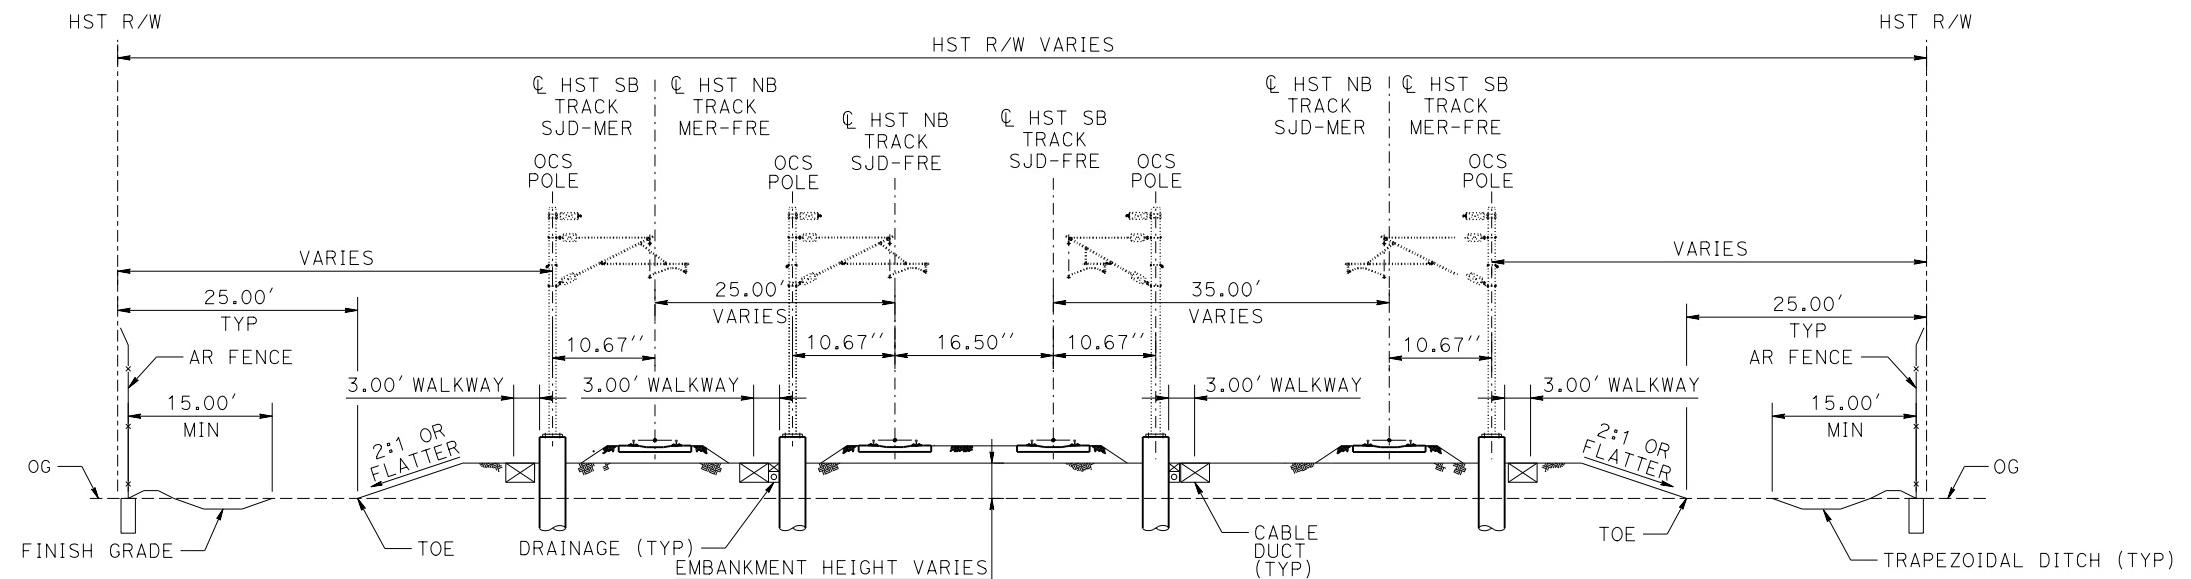

SECTION F-F FOUR TRACKS AT-GRADE

SECTION F-F

TANGENT

STATION SJD-FRE 6570+00.00 TO 6577+70.30
 STATION SJD-FRE 6579+20.30 TO 6625+19.60
 STATION SJD-FRE 6826+21.70 TO 6868+50.00
 STATION SJD-MER 36570+00.00 TO 36577+70.36
 STATION SJD-MER 36579+20.40 TO 36625+20.00
 STATION MER-FRE 14737+18.92 TO 14757+80.00

SUPERELEVATED
N/A

					DESIGNED BY D. OLIVETI	RECORD SET 15% DESIGN SUBMITTAL	 PARSONS	 CALIFORNIA HIGH-SPEED RAIL AUTHORITY	CALIFORNIA HIGH-SPEED TRAIN PROJECT MERCED TO FRESNO SECTION	CONTRACT NO. HSR08-05
					DRAWN BY D. OLIVETI				CENTRAL VALLEY WYE	DRAWING NO. TT-B0024-B
					CHECKED BY N. OUM				SR 152 (NORTH) TO ROAD 19 WYE ALTERNATIVE	SCALE N.T.S.
					IN CHARGE C. LEMLEY	NOT FOR CONSTRUCTION			TYPICAL SECTION	SHEET NO. 5 OF 12
REV	DATE	BY	CHK	APP	DATE 10/30/2015	DESCRIPTION				

**SECTION G-G
THREE TRACKS AT GRADE
ONE TRACK ON AERIAL STRUCTURE**


TANGENT

STATION SJD-FRE 6819+72.57 TO 6826+21.70*
 STATION MER-FRE 14757+80.00 TO 14767+30.14
 STATION MER-FRE 14958+52.25 TO 14934+11.90

SUPERELEVATED

STATION SJD-FRE 6809+48.29 TO 6819+72.57*
STATION MER-FRE 14767+30.14 TO 14774+54.00

* TYPICAL SECTIONS VIEWED IN THE DIRECTION OF DECREASING STATIONING

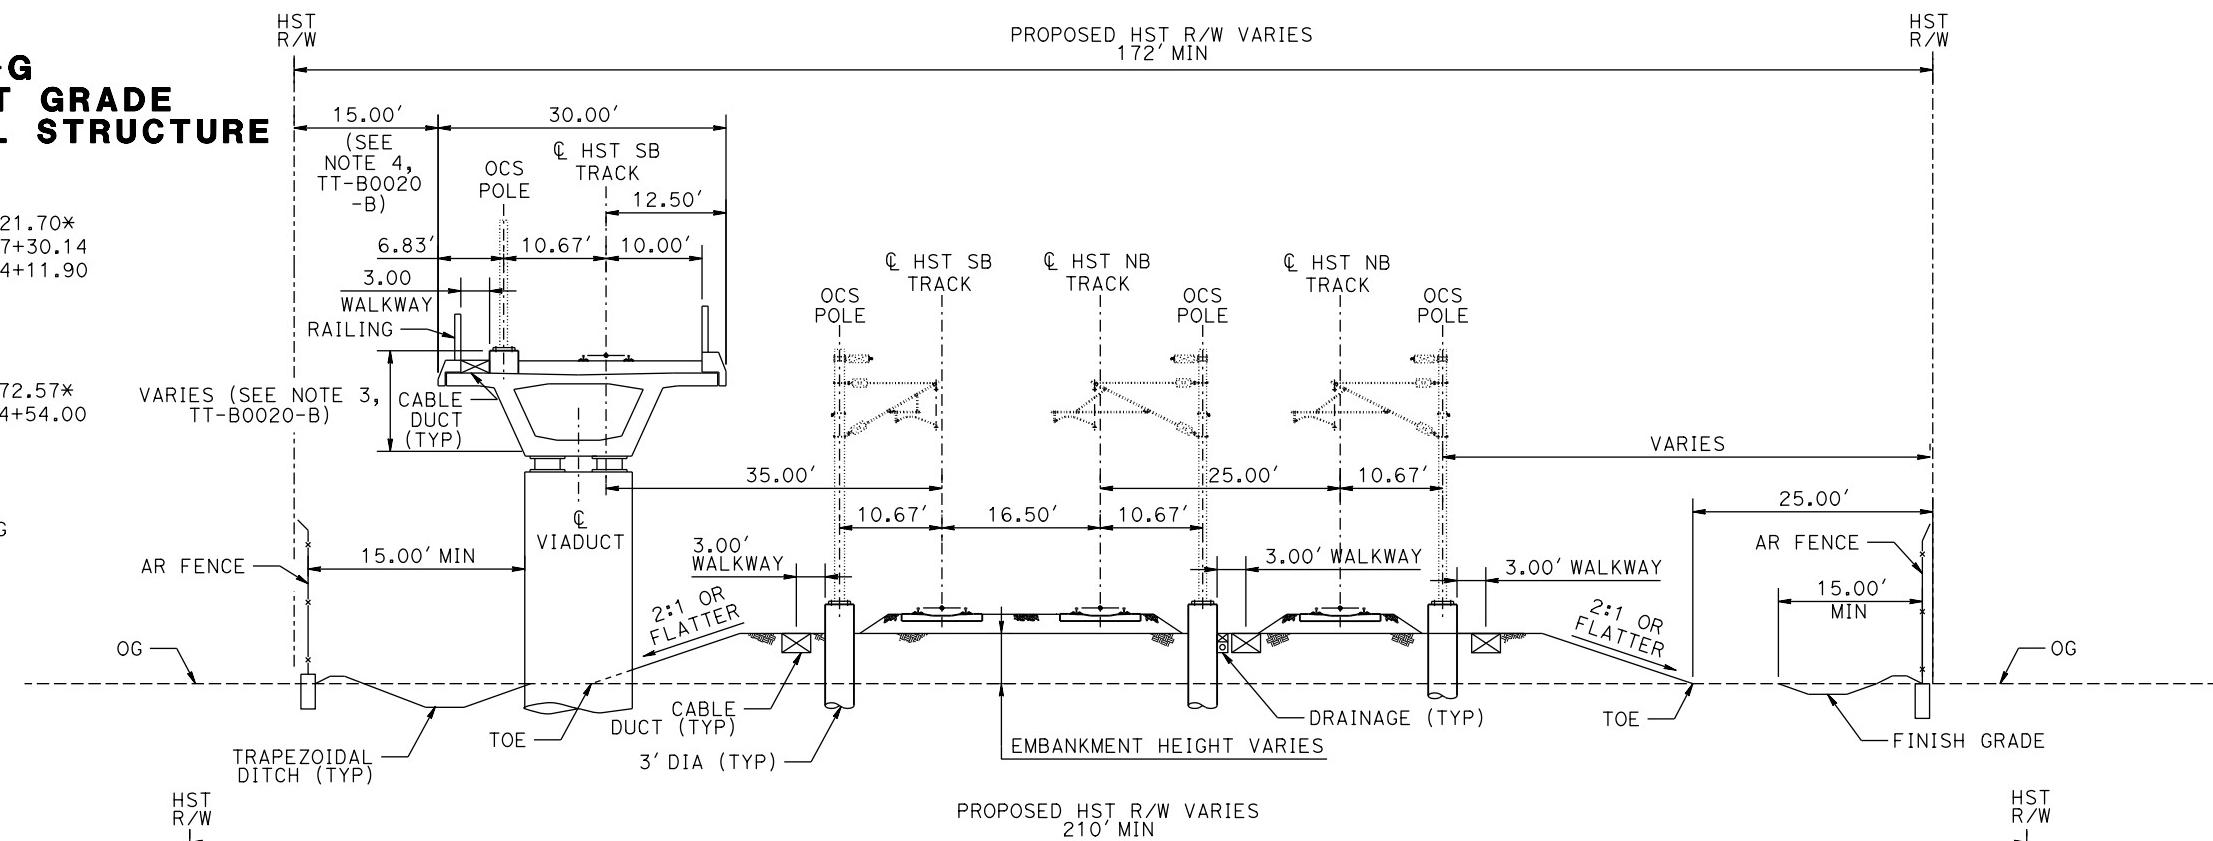

SECTION H-H

TANGENT


STATION SJD-FRE 6642+58.76 TO 6645+60.92*

SUPERELEVATED

STATION SJD-FRE 6803+95.00 TO 6809+48.29*
STATION MER-FRE 14774+54.00 TO 14780+10.00
STATION SJD-MER 36642+51.50 TO 36646+00.00*

* TYPICAL SECTIONS VIEWED IN THE DIRECTION
OF DECREASING STATIONING

SECTION H-H
**ONE TRACK ON STRADDLE BENT
OVER THREE TRACKS AT-GRADE**

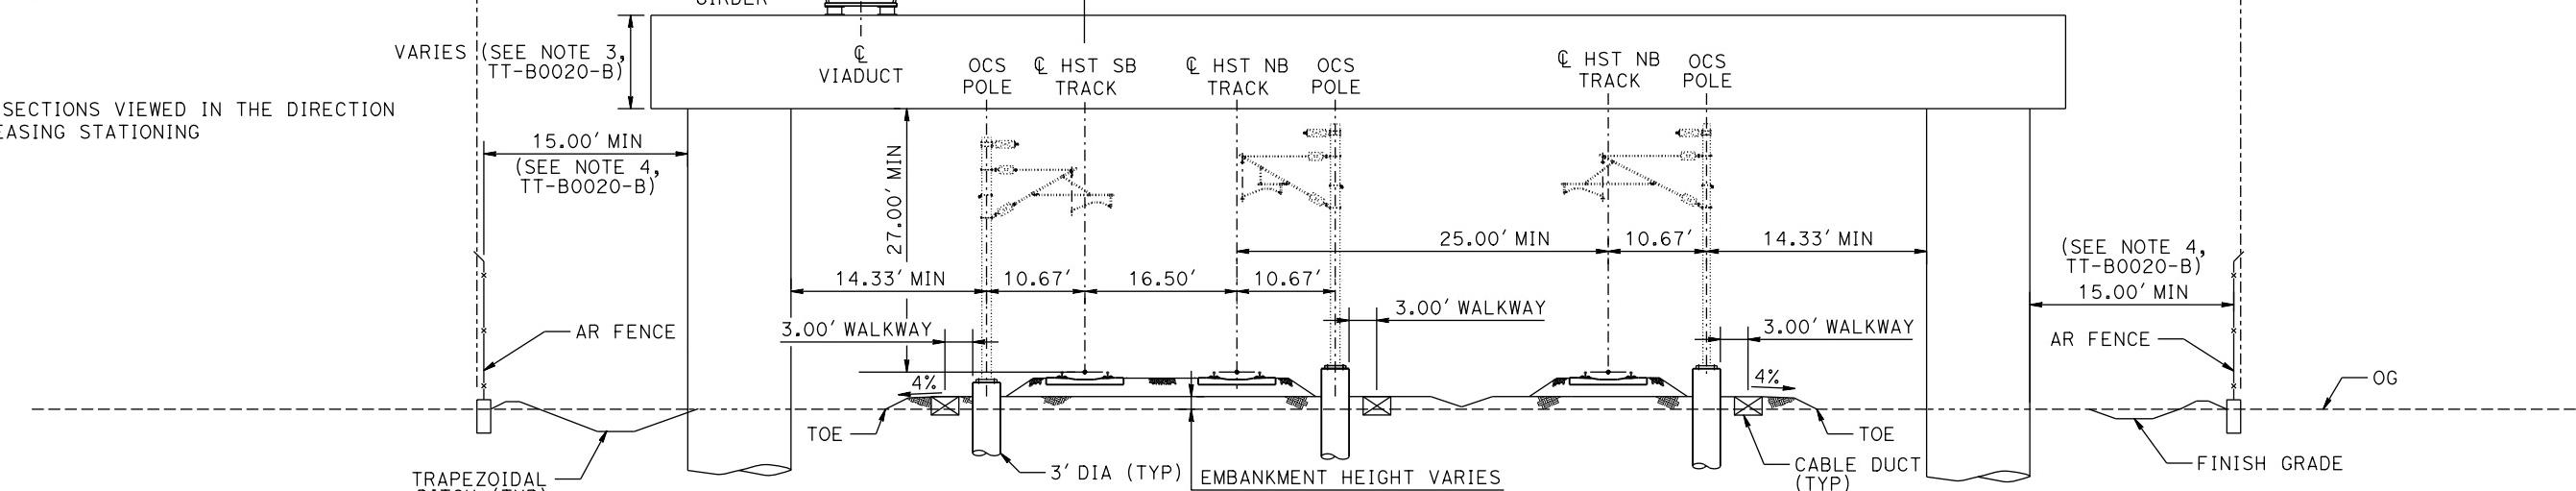

F-TT-B0025-B.dgn

3-MAR-2016:34


00042226

SEARCHED	INDEXED
SERIALIZED	FILED
APR 1 1968	
FBI - BOSTON	

**RECORD S
15% DESIG
SUBMITTA
NOT FOR
CONSTRUCT**



PARSONS

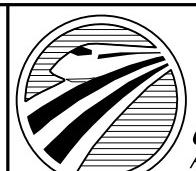

CALIFORNIA HIGH-SPEED RAIL AUTHORITY

**CALIFORNIA HIGH-SPEED TRAIN PROJECT
MERCED TO FRESNO SECTION**

CENTRAL VALLEY WYE
SR 152 (NORTH) TO ROAD 19 WYE ALTERNATIVE
TYPICAL SECTION
SHEET 6 OF 12

CONTRACT NO.
HSR08-05
DRAWING NO.
TT-B0025-B
SCALE
N.T.S.
SHEET NO.


SECTION I-I

TANGENT

STATION MER-FRE 14906+19.71 TO 14908+46.40
STATION MER-FRE 14980+00.00 TO 14999+01.77
STATION MER-FRE 15172+21.06 TO 15270+76.31

SUPERELEVATED

STATION MER-FRE 14807+40.00 TO 14831+75.40
STATION MER-FRE 14834+15.40 TO 14862+18.00
STATION MER-FRE 14864+58.00 TO 14906+19.71
STATION MER-FRE 14999+01.77 TO 15006+95.00
STATION MER-FRE 15014+69.91 TO 15031+43.00
STATION MER-FRE 15035+54.98 TO 15106+65.00
STATION MER-FRE 15114+75.00 TO 15172+21.06
STATION MER-FRE 15270+76.31 TO 15331+00.00
STATION SJD-MER 36668+56.16 TO 36700+20.00
STATION SJD-MER 36713+50.00 TO 36736+75.00
STATION SJD-MER 36739+55.00 TO 36778+91.42

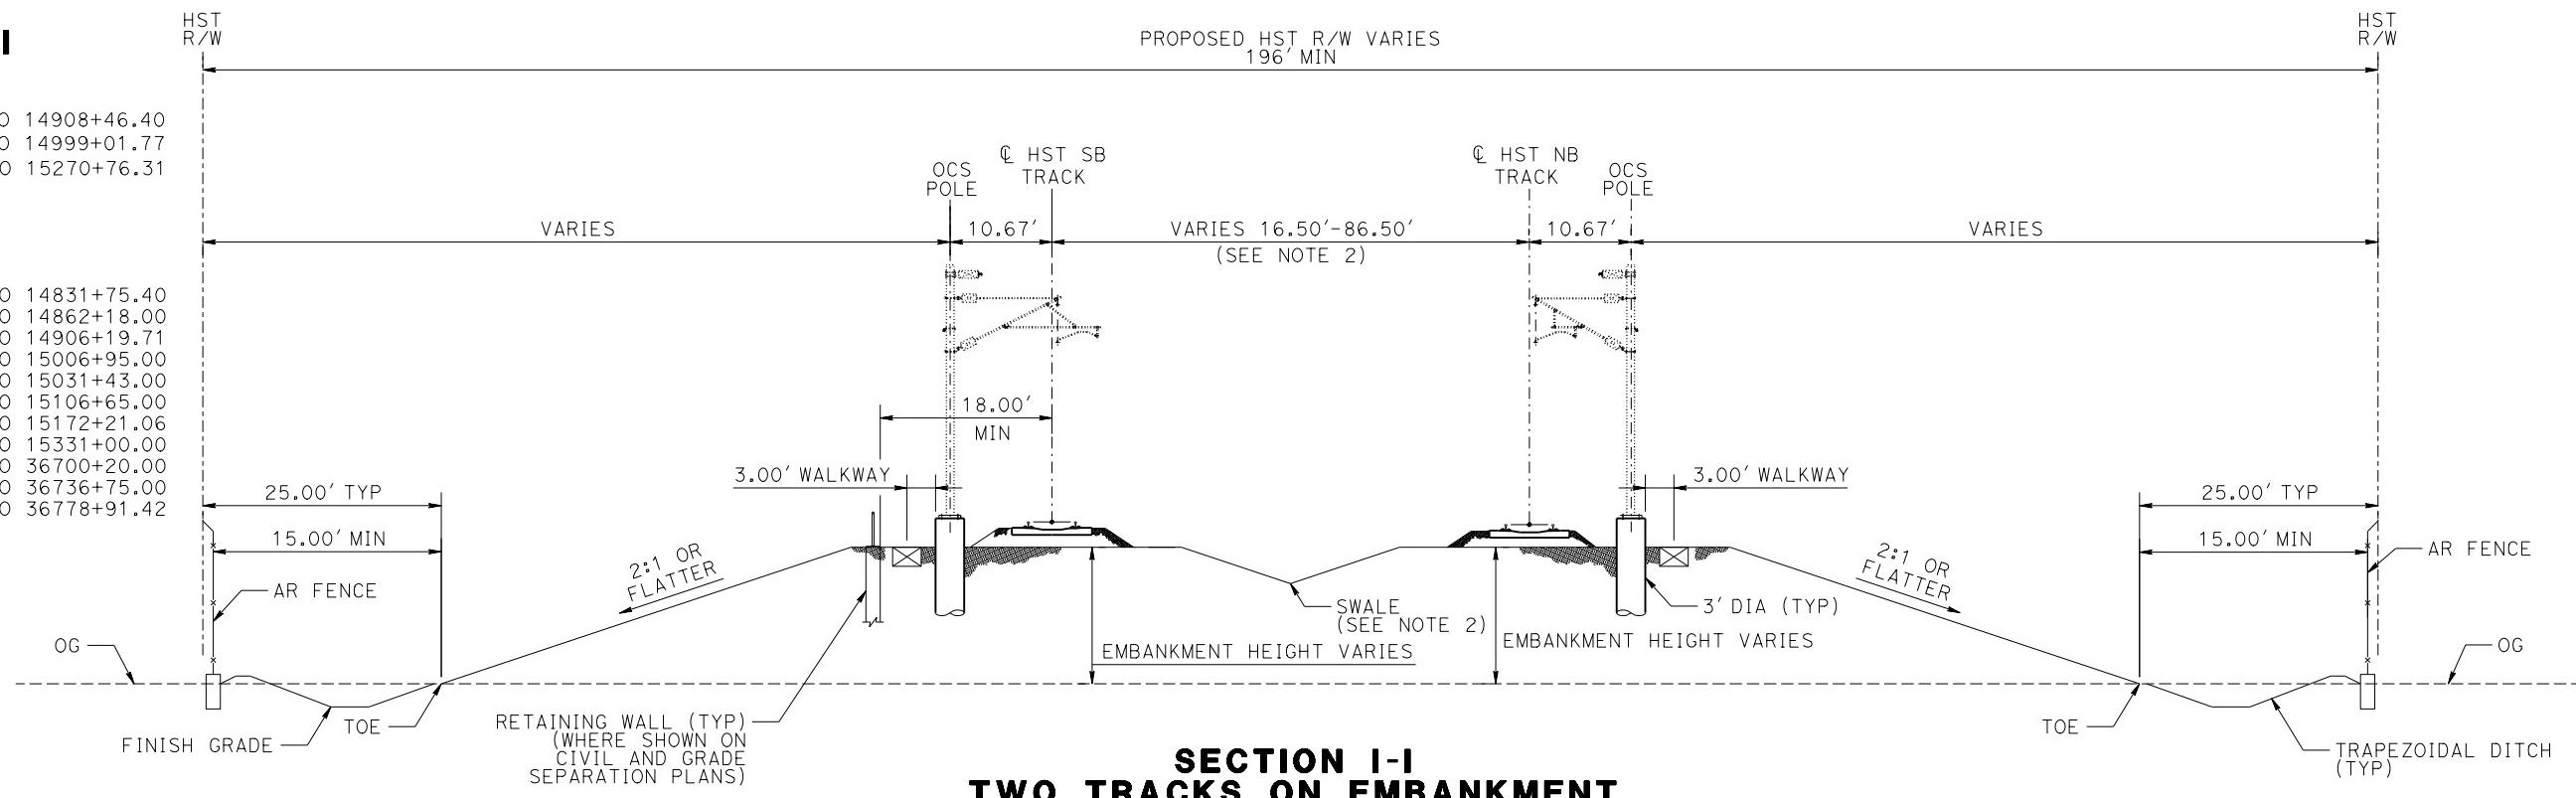


SECTION J-J

TANGENT

N/A

SUPERELEVATED

STATION MER-FRE 14831+75.40 TO 14834+15.40
STATION MER-FRE 14862+18.00 TO 14864+58.00
STATION MER-FRE 15106+65.00 TO 15114+75.00
STATION SJD-MER 36657+24.30 TO 36659+64.30
STATION SJD-MER 36700+20.00 TO 36713+50.00
STATION SJD-MER 36736+75.00 TO 36739+55.00

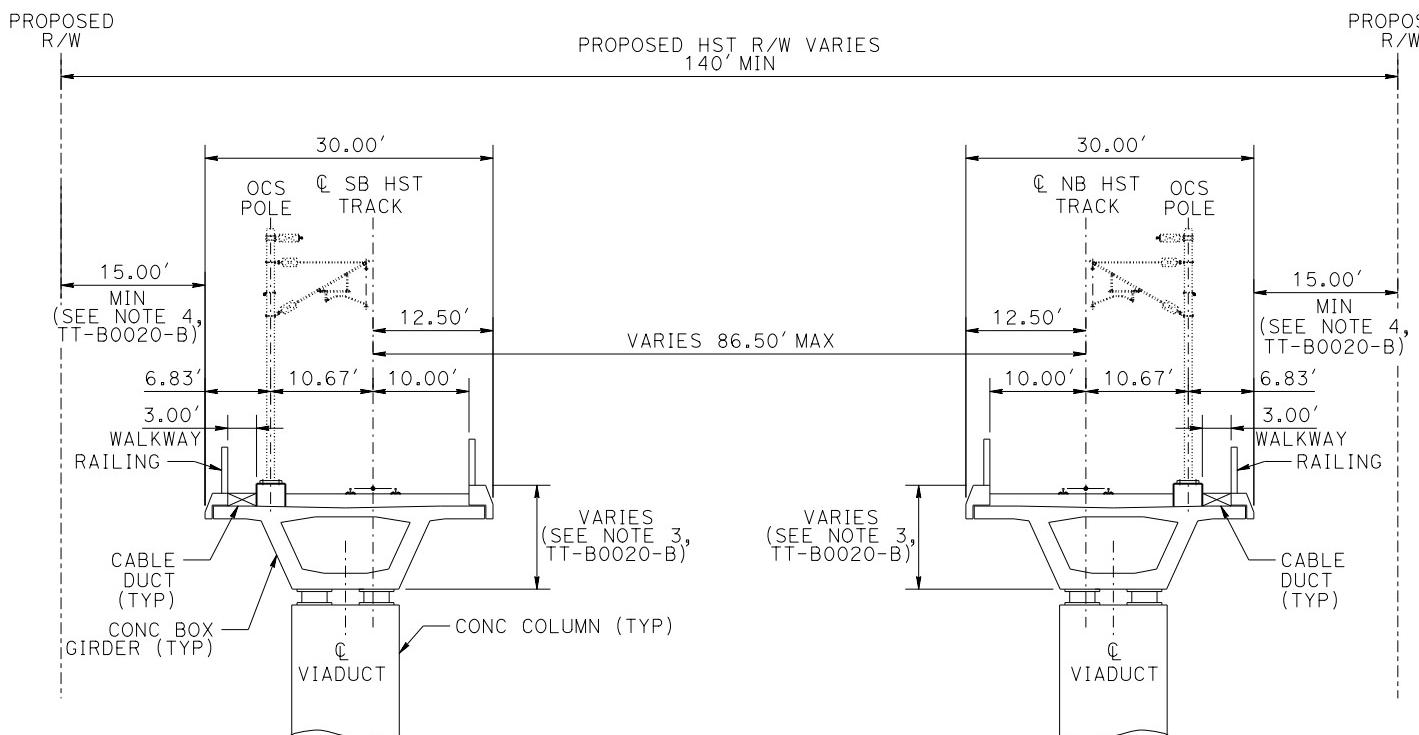

NOTES:

- SEE DRAWING TT-B0020-B FOR GENERAL TYPICAL SECTION NOTES.
- CENTER SWALE REMOVED IF DISTANCE BETWEEN TRACKS IS LESS THAN 34'.

SECTION J-J

TWO TRACKS ON SINGLE TRACK AERIAL STRUCTURE WITH WIDE TRACK CENTERS

REV	DATE	BY	CHK	APP
DESCRIPTION				

DESIGNED BY D. OLIVETI
DRAWN BY D. OLIVETI
CHECKED BY N. OUM
IN CHARGE C. LEMLEY
DATE 10/30/2015

RECORD SET
15% DESIGN
SUBMITTAL
NOT FOR
CONSTRUCTION




CALIFORNIA HIGH-SPEED TRAIN PROJECT
MERCED TO FRESNO SECTION
CENTRAL VALLEY WYE
SR 152 (NORTH) TO ROAD 19 WYE ALTERNATIVE
TYPICAL SECTION
SHEET 7 OF 12

CONTRACT NO.
HSR08-05
DRAWING NO.
TT-B0026-B
SCALE
N.T.S.
SHEET NO.

NOTES:

1. SEE DRAWING TT-B0020-B FOR
GENERAL TYPICAL SECTION NOTES.

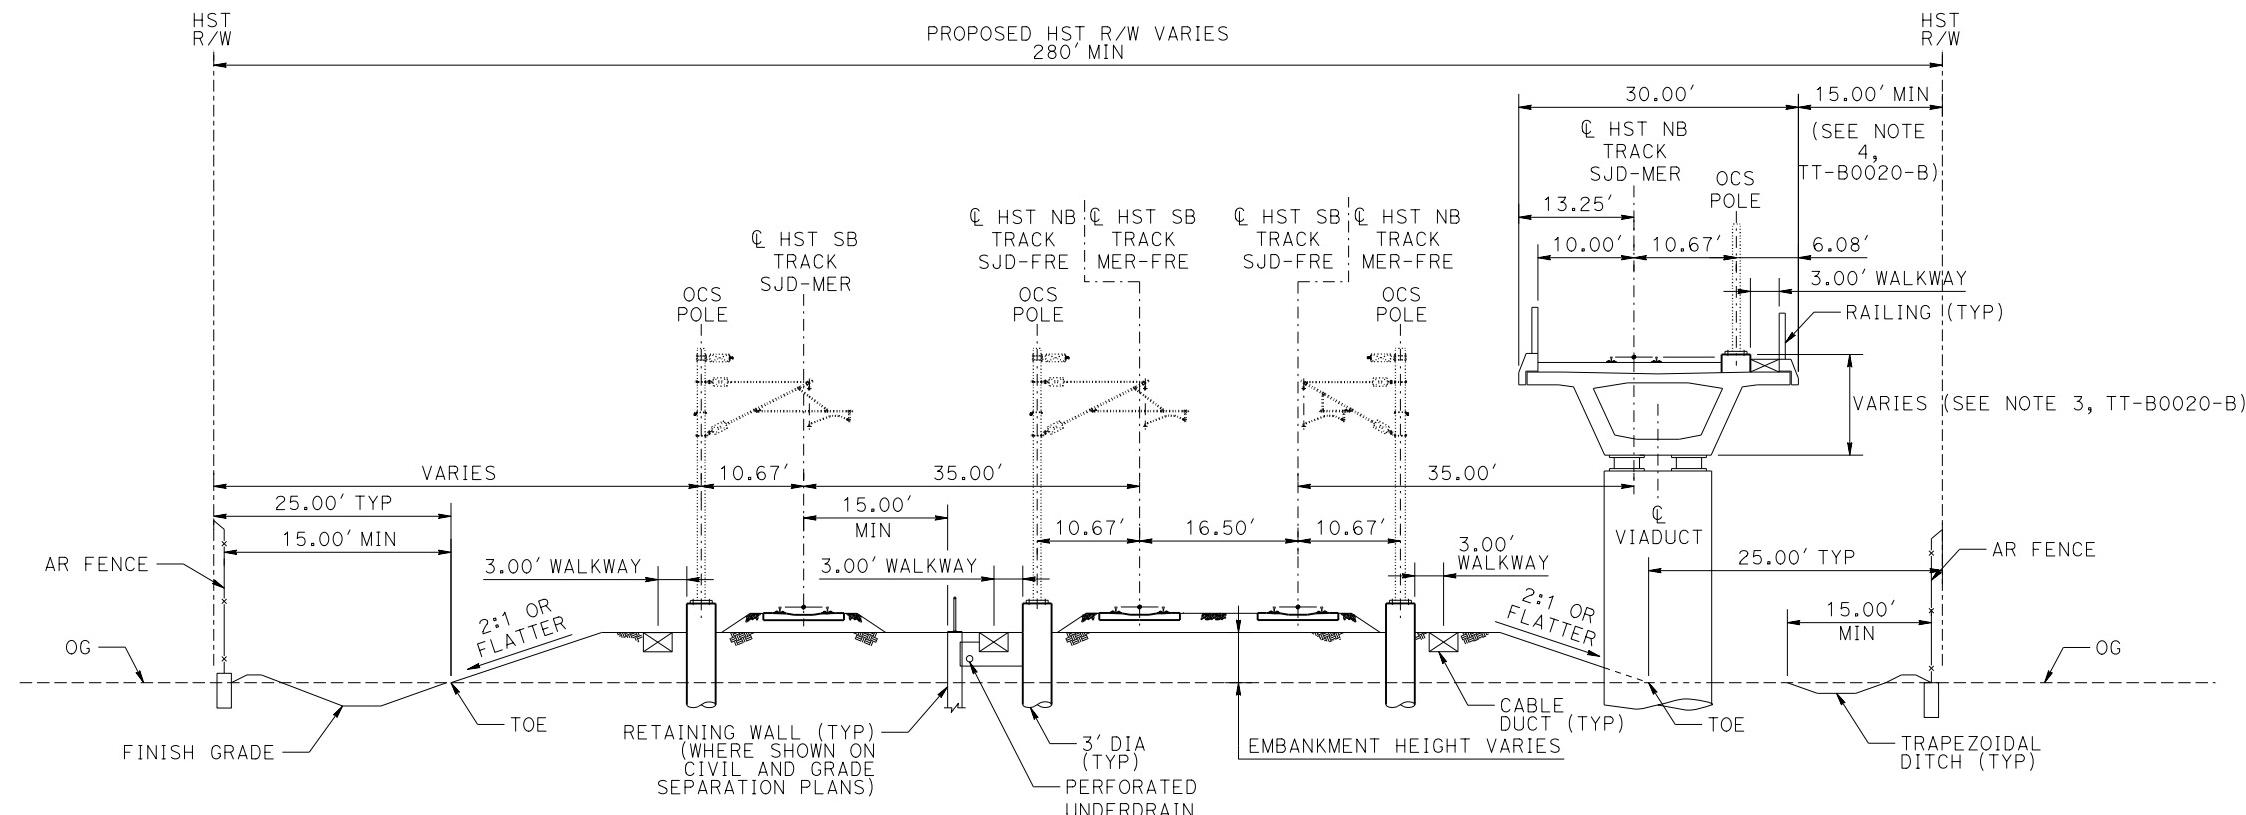**SECTION K-K**TANGENT

STATION SJD-FRE 6625+19.60 TO 6642+20.00
STATION SJD-MER 36625+20.00 TO 36634+19.07
STATION SJD-MER 36804+28.07 TO 36811+40.11

SUPERELEVATED

STATION SJD-MER 36634+19.07 TO 36642+57.54
STATION SJD-MER 36795+77.67 TO 36804+28.07

SECTION K-K
THREE TRACKS AT GRADE
ONE TRACK ON AERIAL STRUCTURE

DESIGNED BY D. OLIVETI	RECORD SET 15% DESIGN SUBMITTAL	CONTRACT NO. HSR08-05
DRAWN BY D. OLIVETI		DRAWING NO. TT-B0027-B
CHECKED BY N. OUM		SCALE N.T.S.
IN CHARGE C. LEMLEY	NOT FOR CONSTRUCTION	SHEET NO.
DATE 10/30/2015		
REV DATE BY CHK APP	DESCRIPTION	CALIFORNIA HIGH-SPEED TRAIN PROJECT MERCED TO FRESNO SECTION
		CENTRAL VALLEY WYE SR 152 (NORTH) TO ROAD 19 WYE ALTERNATIVE TYPICAL SECTION SHEET 8 OF 12




PARSONS



CALIFORNIA
HIGH-SPEED RAIL AUTHORITY

NOTES:
1. SEE DRAWING TT-B0020-B FOR
GENERAL TYPICAL SECTION NOTES.

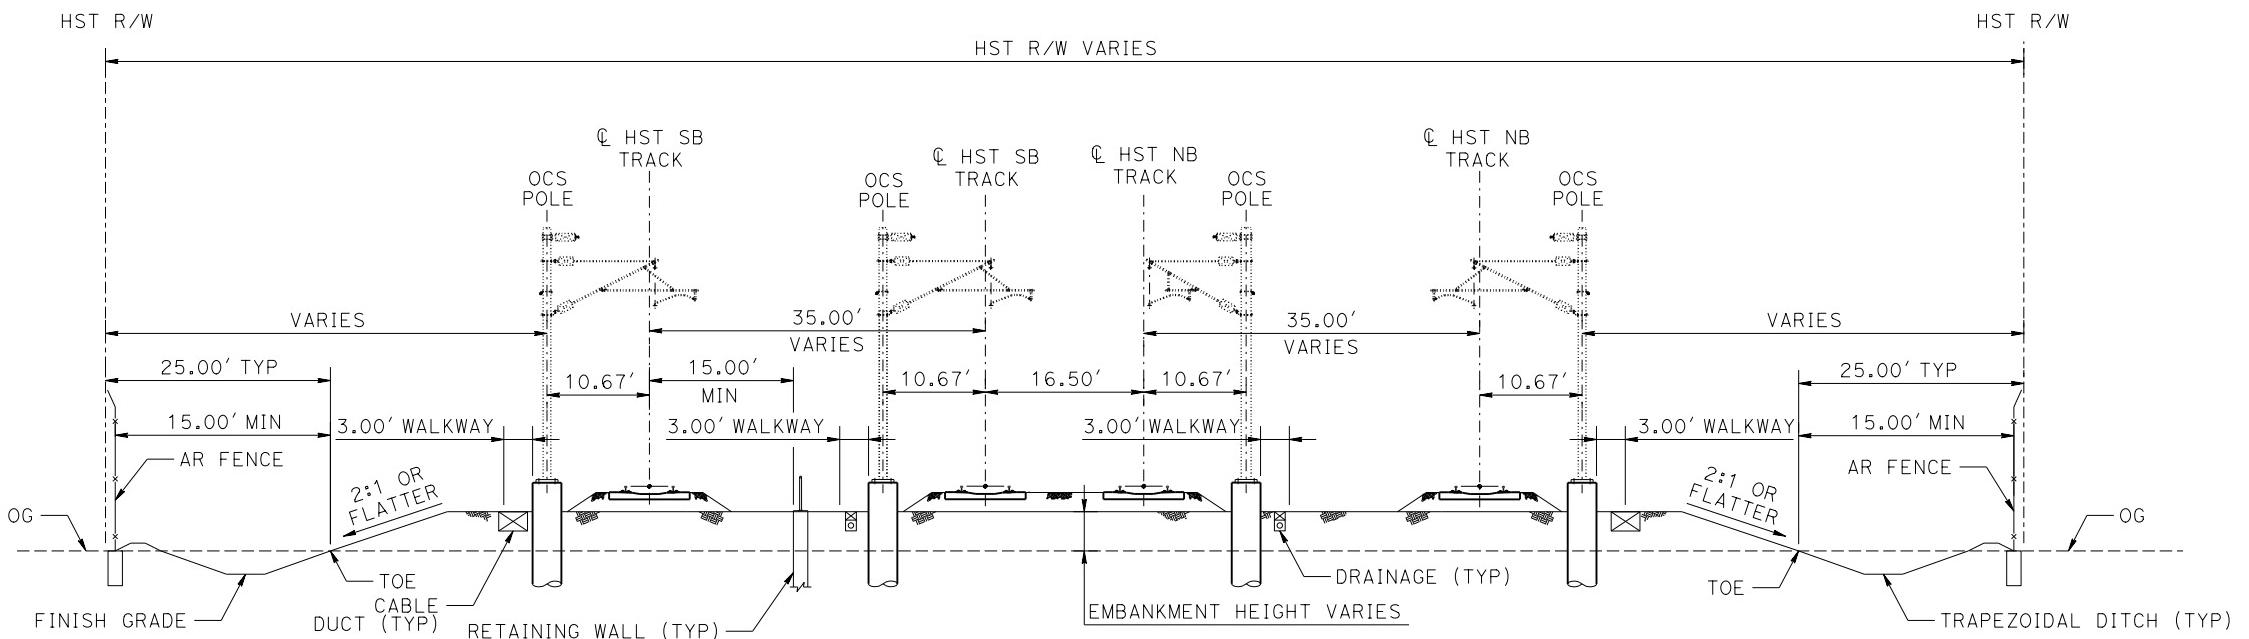

SECTION L-L

TANGENT

STATION MER-FRE 14934+11.90 TO 14947+05.00
STATION MER-FRE 14956+95.00 TO 14969+01.00
STATION MER-FRE 14971+01.00 TO 14980+00.00
STATION SJD-MER 36811+40.14 TO 36824+33.24
STATION SJD-MER 36834+23.24 TO 36846+29.47
STATION SJD-MER 36848+29.55 TO 36857+28.64

SUPERELEVATED
N/A

SECTION L-L FOUR TRACKS AT GRADE

					DESIGNED BY D. OLIVETI	DRAWN BY D. OLIVETI	CHECKED BY N. OUM	IN CHARGE C. LEMLEY	DATE 10/30/2015
REV	DATE	BY	CHK	APP	DESCRIPTION				

RECORD SET
15% DESIGN
SUBMITTAL
**NOT FOR
CONSTRUCTION**



**CALIFORNIA HIGH-SPEED TRAIN PROJECT
MERCED TO FRESNO SECTION**
CENTRAL VALLEY WYE
SR 152 (NORTH) TO ROAD 19 WYE ALTERNATIVE
TYPICAL SECTION
SHEET 9 OF 12

CONTRACT NO.
HSR08-05
DRAWING NO.
TT-B0028-B
SCALE
N.T.S.
SHEET NO.


SECTION M-M

TANGENT

STATION MER-FRE 14947+05.00 TO 14956+95.00
 STATION MER-FRE 14969+01.00 TO 14971+01.00
 STATION SJD-MER 36577+70.36 TO 36579+20.40
 STATION SJD-MER 36824+33.24 TO 36834+23.24
 STATION SJD-MER 36846+29.47 TO 36848+29.55
 STATION SJD-FRE 6577+70.30 TO 6579+20.30

SUPERELEVATED

N/A

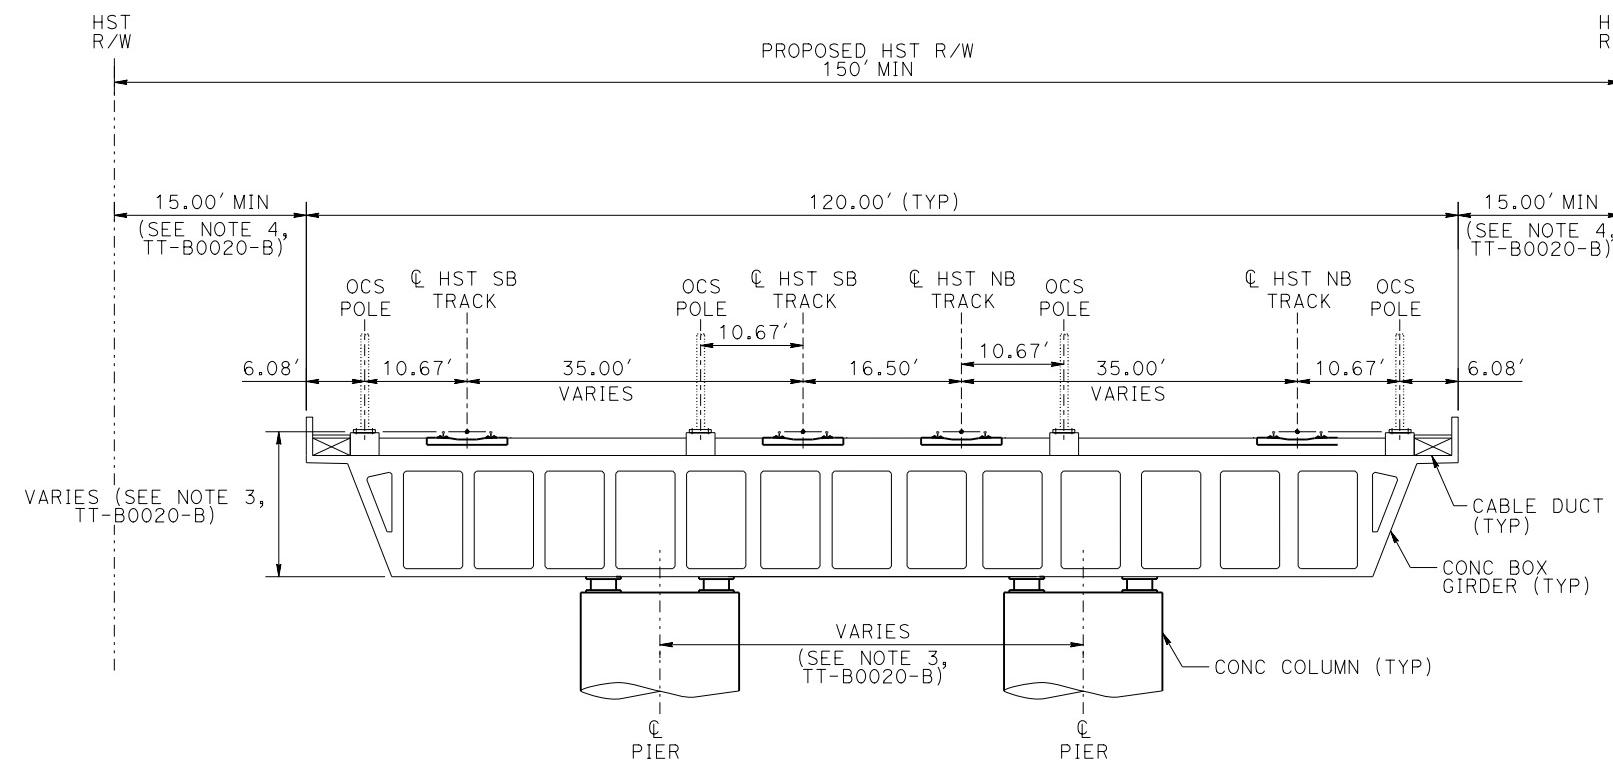

SECTION M-M
FOUR TRACKS ON TWO AERIAL STRUCTURES

SECTION N-N

TANGENT

STATION MER-FRE 15443+50.00 TO 15473+88.00

SUPERELEVATED

STATION MER-FRE 15331+00.00 TO 15374+30.00
 STATION MER-FRE 15396+80.00 TO 15414+40.00
 STATION MER-FRE 15434+50.00 TO 15463+81.44
 STATION MER-FRE 15475+68.00 TO 15499+00.00

*STATION MER-FRE 15435+00 TO 15655+00
 **STATION MER-FRE 15375+00 TO 15435+00

RETAINED CUT
(WHERE SHOWN ON
CIVIL AND GRADE
SEPARATION PLANS)

SECTION N-N
TWO TRACKS IN CUT



CALIFORNIA HIGH-SPEED TRAIN PROJECT MERCED TO FRESNO SECTION

CENTRAL VALLEY WYE
 SR 152 (NORTH) TO ROAD 19 WYE ALTERNATIVE
 TYPICAL SECTION
 SHEET 10 OF 12

CONTRACT NO.
HSR08-05
 DRAWING NO.
TT-B0029-B
 SCALE
N.T.S.
 SHEET NO.

REV	DATE	BY	CHK	APP	DESCRIPTION

DESIGNED BY
D. OLIVETI
DRAWN BY
D. OLIVETI
CHECKED BY
N. OUM
IN CHARGE
C. LEMLEY
DATE
10/30/2015

RECORD SET
15% DESIGN
SUBMITTAL
NOT FOR
CONSTRUCTION

NOTES:


- SEE DRAWING TT-B0020-B FOR GENERAL TYPICAL SECTION NOTES.
- ENGINEERED FLOOD BERMS SHALL HAVE A TOP WITH OF 4' AND 3:1 SIDE SLOPES.

SECTION 0-0

TANGENT
N/A

SUPERELEVATED

STATION MER-FRE 15374+30.02 TO 15396+79.94
STATION MER-FRE 15414+40.00 TO 15443+50.00
STATION MER-FRE 15473+88.00 TO 15475+68.00

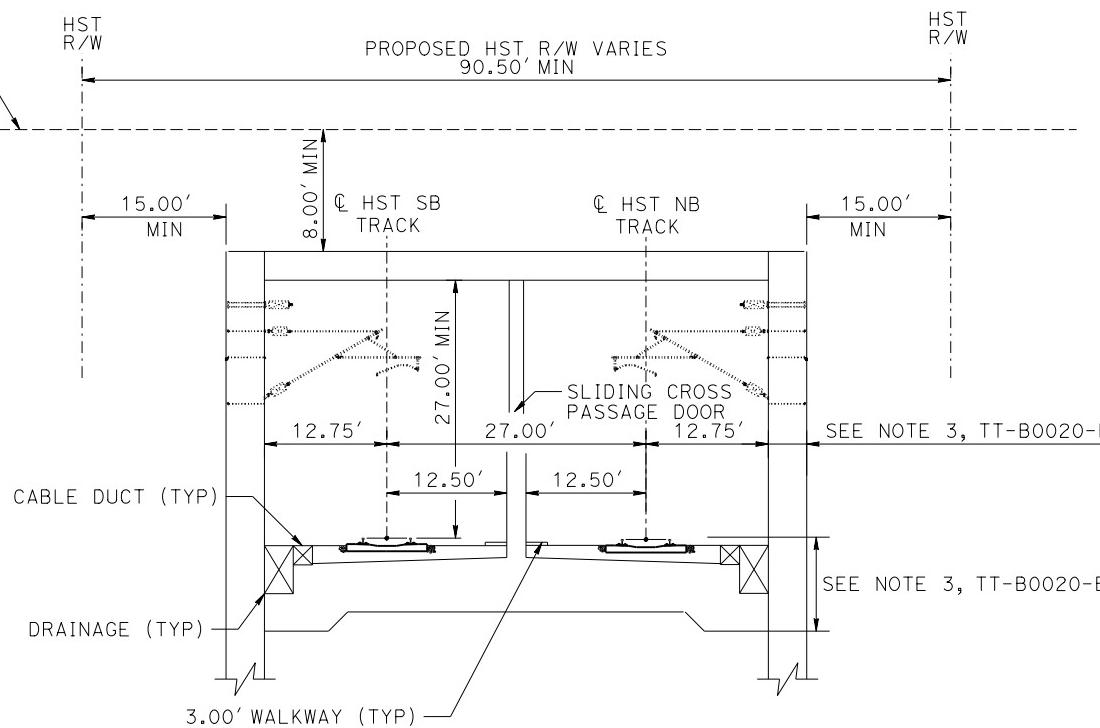

NOTES:

1. SEE DRAWING TT-B0020-B OR GENERAL TYPICAL SECTION NOTES.
2. INTRUSION PROTECTION BARRIER REQUIRED WHEN HORIZONTAL DISTANCE BETWEEN CENTERLINE OF FREIGHT TRACK AND NEAREST CENTERLINE OF HST TRACK IS LESS THAN 102'.

SECTION O-O TWO TRACKS IN CUT AND COVER TUNNEL WITH CENTER WALL


SECTION P-P

TANGENT

STATION MER-FRE 15503+81.98 TO 15519+31.98
STATION MER-FRE 15549+32.51 TO 15655+00.00

SUPERELEVATED

STATION MER-FRE 15499+00.00 TO 15503+81.98
STATION MER-FRE 15519+31.98 TO 15549+32.51

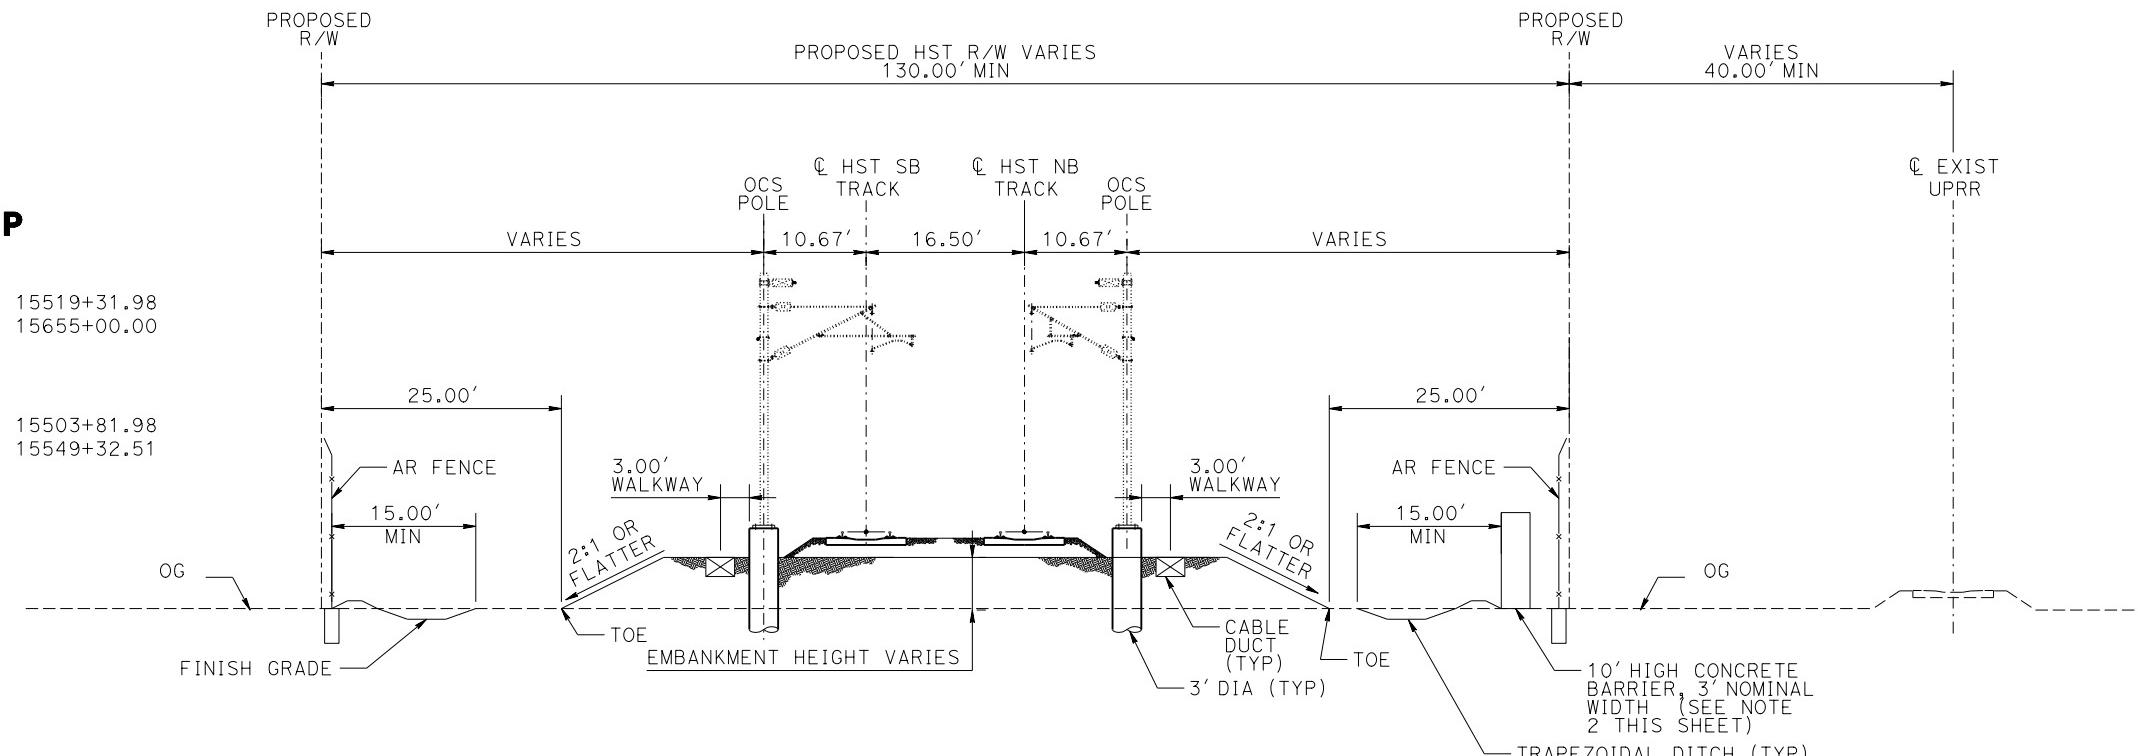

SECTION P-P TWO TRACKS ON EMBANKMENT ADJACENT TO EXISTING UPRR

REV	DATE	BY	CHK	APP	DESCRIPTION

DESIGNED BY
D. OLIVETI
DRAWN BY
D. OLIVETI
CHECKED BY
N. OUM
IN CHARGE
C. LEMLEY
DATE
02/13/2015

RECORD SET
15% DESIGN
SUBMITTAL
**NOT FOR
CONSTRUCTION**



PARSONS



CALIFORNIA
HIGH-SPEED RAIL AUTHORITY

CALIFORNIA HIGH-SPEED TRAIN PROJECT
MERCED TO FRESNO SECTION
CENTRAL VALLEY WYE
SR 152 (NORTH) TO ROAD 19 WYE ALTERNATIVE
TYPICAL SECTION
SHEET 11 OF 12


CONTRACT NO.
HSR08-05
DRAWING NO.
TT-B0030-B
SCALE
N.T.S.
SHEET NO.

SECTION Q-Q

TANGENT
N/A

SUPERELEVATED

STATION MER-FRE 14783+66.00 TO 14807+40.00
STATION SJD-MER 36651+50.49 TO 36657+24.30
STATION SJD-MER 36659+64.30 TO 36668+56.16
STATION SJD-MER 36778+91.42 TO 36785+85.58*

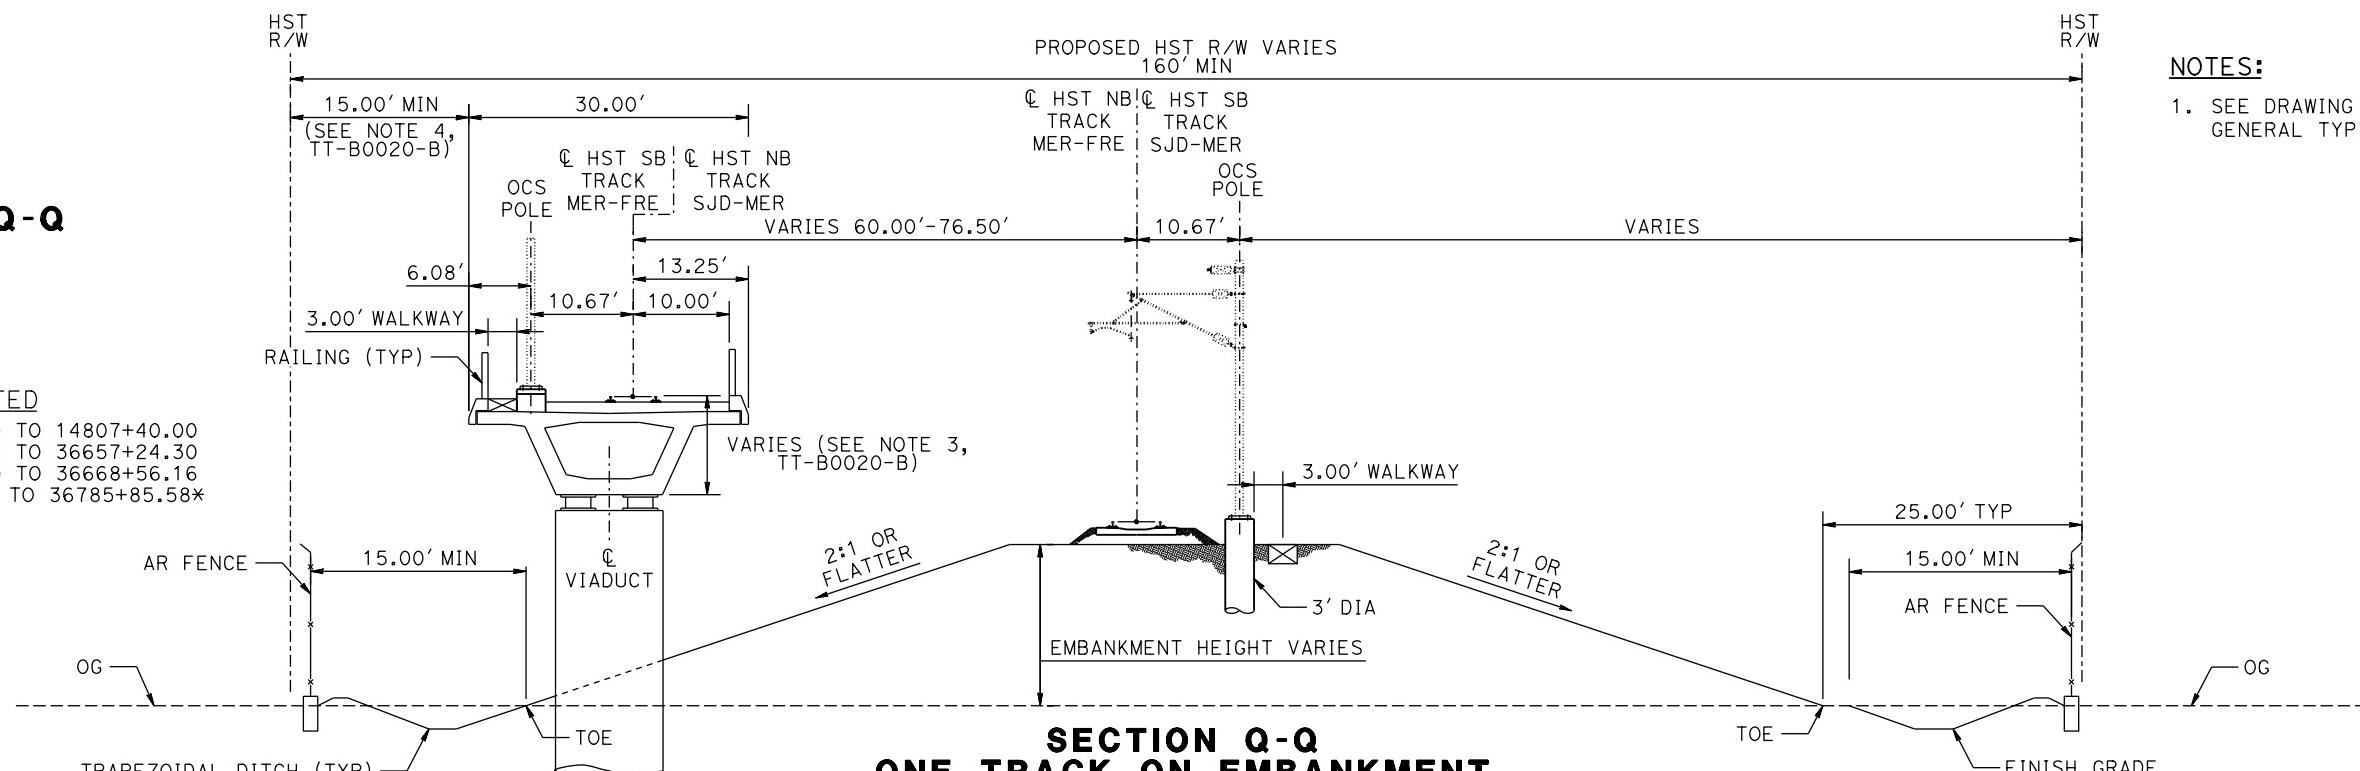

SECTION Q-Q
ONE TRACK ON EMBANKMENT
ONE TRACK ON AERIAL STRUCTURE
WITH WIDE TRACK CENTERS

*TYPICAL SECTION IS VIEWED IN THE DIRECTION OF DECREASING STATIONING

SECTION R-R


TANGENT

STATION SJD-FRE 6819+72.57 TO 6820+90+75
STATION MER-FRE 14763+10.95 TO 14766+00.96*

SUPERELEVATED

STATION SJD-FRE 6818+00.75 TO 6819+72.57

*TYPICAL SECTION IS VIEWED IN THE DIRECTION OF DECREASING STATIONING

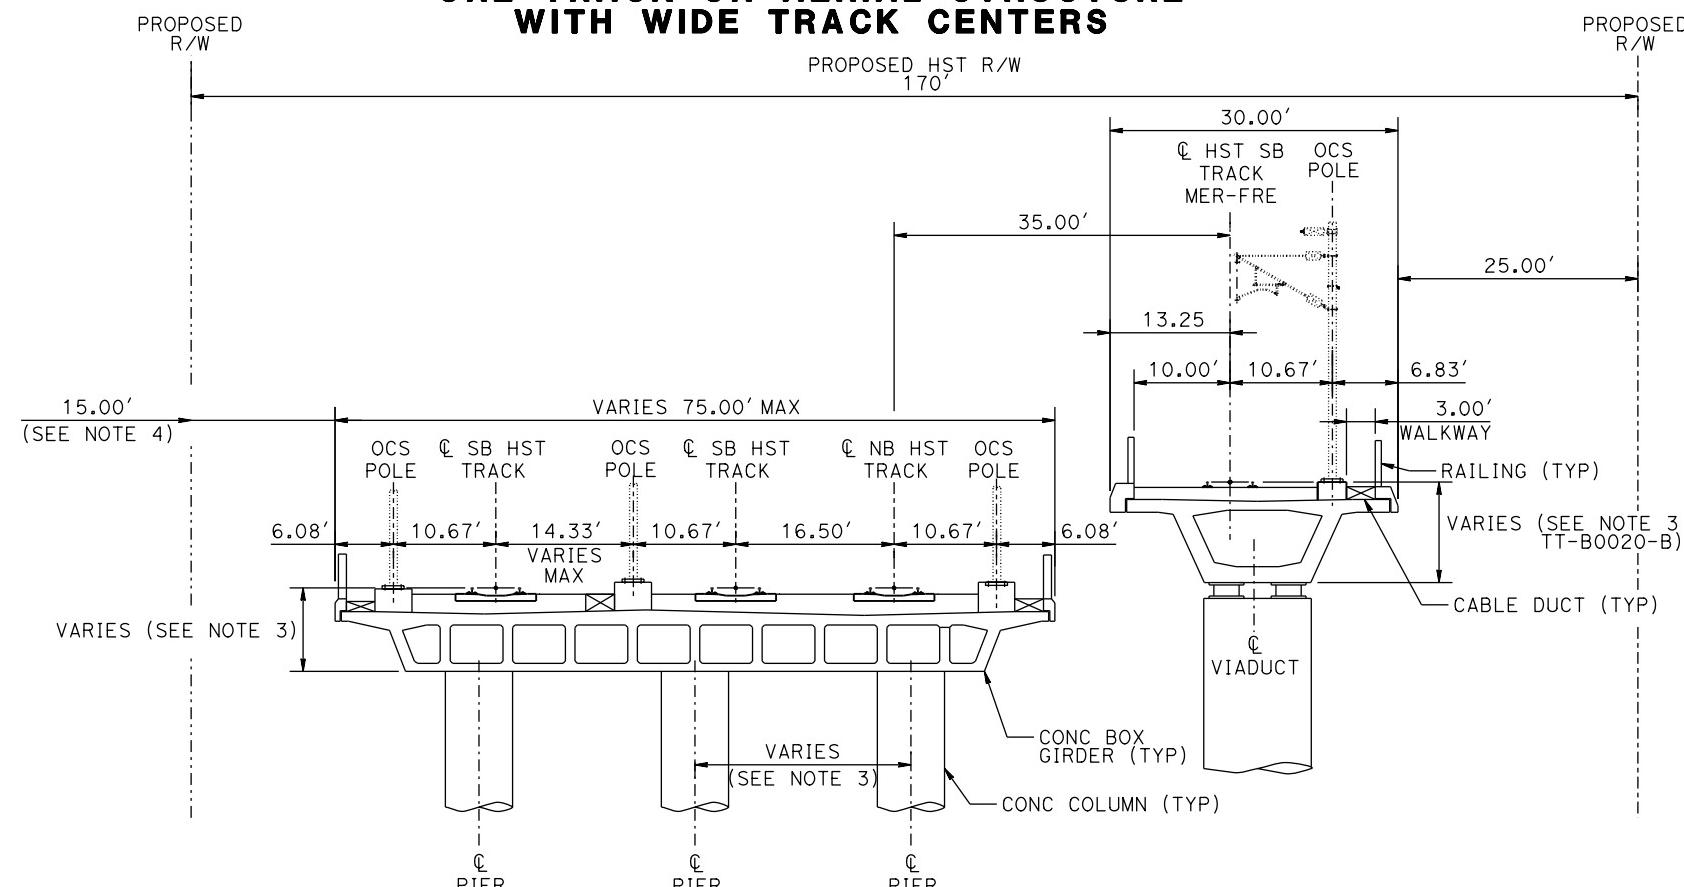

SECTION R-R
FOUR TRACKS ON TWO AERIAL STRUCTURES

REV	DATE	BY	CHK	APP	DESCRIPTION

DESIGNED BY D. OLIVETI	DRAWN BY D. OLIVETI	CHECKED BY N. OUM	IN CHARGE C. LEMLEY	DATE 03/18/2016
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RECORD SET
15% DESIGN
SUBMITTAL
NOT FOR
CONSTRUCTION



PARSONS



CALIFORNIA HIGH-SPEED TRAIN PROJECT MERCED TO FRESNO SECTION

CENTRAL VALLEY WYE
SR 152 (NORTH) TO ROAD 19 WYE ALTERNATIVE
TYPICAL SECTION
SHEET 12 OF 12

CONTRACT NO.
HSR08-05
DRAWING NO.
TT-B0031-B
SCALE
N.T.S.
SHEET NO.

TRACK ALIGNMENT DATA SUMMARY TABLE - SR 152 (NORTH) TO ROAD 19 REFINED WYE - SOUTHBOUND TRACK SAN JOSE TO FRESNO (SJD-FRE)

CURVE NUMBER	ELEMENT	POINT TYPE	STATION	COORDINATES		RADIUS (FT)	LENGTH (FT)	DELTA Δ	K	P	DESIGN SPEED (MPH)	ACTUAL SUPERELEVATION (EA) (IN)	UNBALANCED SUPERELEVATION (EU) (IN)	WCB (0°00'00") (TANGENT)	WCB (0°00'00")	
				NORTHING	EASTING										START ANGLE	END ANGLE
	TANGENT	POB	5338+00.00	1858051.11	6509106.39		13,071.16								S 89°46'01" E	
	TANGENT	TS	5468+71.16	1857997.95	6522177.45											
152 N-19 SJD-FRE 1 SB	CLOTHOID	TS	5468+71.16	1857997.95	6522177.45											
	CLOTHOID	SPI	5479+71.18	1857993.48	6523277.46		1,650.00	1°03'02"	824.99	2.52					S 89°46'01" E	S 88°43'00" E
	CLOTHOID	SC	5485+21.16	1857981.16	6523827.34											
	ARC	SC	5485+21.16	1857981.16	6523827.34											
	ARC	PI	5543+57.71	1857850.43	6529662.42	45,000.00	11,608.30	14°46'49"			250.00	3.75	1.81		S 88°43'00" E	S 73°56'11" E
	ARC	CC		1812992.45	6522819.41											
	ARC	CS	5601+29.46	1856235.43	6535271.09											
	CLOTHOID	CS	5601+29.46	1856235.43	6535271.09											
	CLOTHOID	SPI	5606+79.48	1856083.24	6535799.63		1,650.00	1°03'02"	824.99	2.52					S 73°56'11" E	S 72°53'10" E
	CLOTHOID	ST	5617+79.46	1855759.53	6536850.94											
152 N-19 SJD-FRE 2 SB	TANGENT	ST	5617+79.46	1855759.53	6536850.94		1,471.20								S 72°53'10" E	
	TANGENT	TS	5632+50.67	1855326.60	6538257.00											
	CLOTHOID	TS	5632+50.67	1855326.60	6538257.00											
	CLOTHOID	SPI	5642+84.02	1855022.51	6539244.60		1,550.00	0°59'11"	774.99	2.22					S 72°53'10" E	S 73°52'21" E
	CLOTHOID	SC	5648+00.67	1854878.99	6539740.94											
	ARC	SC	5648+00.67	1854878.99	6539740.94											
	ARC	PI	5706+82.43	1853245.16	6545391.23	45,016.50	11,697.26	14°53'17"			250.00	3.75	1.80		S 73°52'21" E	S 88°45'37" E
	ARC	CC		1898123.88	6552245.52											
	ARC	CS	5764+97.92	1853117.92	6551271.61											
	CLOTHOID	CS	5764+97.92	1853117.92	6551271.61											
152 N-19 SJD-FRE 3 SB	CLOTHOID	SPI	5770+14.60	1853106.74	6551788.17		1,550.00	0°59'11"	774.99	2.22					S 88°45'37" E	S 89°44'48" E
	CLOTHOID	ST	5780+47.92	1853102.17	6552821.51											
	TANGENT	ST	5780+47.92	1853102.17	6552821.51		21,750.44								S 89°44'48" E	
	TANGENT	TS	5997+98.36	1853006.03	6574571.74											
	CLOTHOID	TS	5997+98.36	1853006.03	6574571.74											
	CLOTHOID	SPI	6005+65.03	1853002.64	6575338.40		1,150.00	0°04'56"	575	0.14					S 89°44'48" E	S 89°49'45" E
	CLOTHOID	SC	6009+48.36	1853001.49	6575721.73											
	ARC	SC	6009+48.36	1853001.49	6575721.73											
	ARC	PI	6015+60.56	1852999.67	6576333.93	400,016.50	1,224.40	0°10'31"			250.00	0.50	0.12		S 89°49'45" E	N 89°59'44" E
	ARC	CC		2253016.21	6576914.92											
28-OCT-2015:34 p005133g	ARC	CS	6021+72.76	1852999.72	6576946.13											
	CLOTHOID	CS	6021+72.76	1852999.72	6576946.13											
	CLOTHOID	SPI	6025+56.10	1852999.75	6577329.46		1,150.00	0°04'56"	575	0.14					N 89°59'44" E	N 89°54'47" E
	CLOTHOID	ST	6033+22.76	1853000.91	6578096.13											

MF-IT-B0050-B.dgn

p005133g

REV DATE BY CHK APP

DESCRIPTION

DESIGNED BY
D. OLIVETI
DRAWN BY
S. WILSON
CHECKED BY
N. OUM
IN CHARGE
C. LEMLEY
DATE
10/30/2015RECORD SET
15% DESIGN
SUBMITTAL

NOT FOR
CONSTRUCTION

PARSONS

CALIFORNIA HIGH-SPEED TRAIN PROJECT
MERCED TO FRESNO SECTIONCENTRAL VALLEY WYE
SR 152 (NORTH) TO ROAD 19 WYE ALTERNATIVE
SB TRACK SAN JOSE TO FRESNO GEOMETRY DATA
SHEET 1 OF 9CONTRACT NO.
HSR08-05
DRAWING NO.
TT-B0050-B
SCALE
N.T.S.
SHEET NO.

TRACK ALIGNMENT DATA SUMMARY TABLE - SR 152 (NORTH) TO ROAD 19 REFINED WYE - SOUTHBOUND TRACK SAN JOSE TO FRESNO (SJD-FRE)

CURVE NUMBER	ELEMENT	POINT TYPE	STATION	COORDINATES		RADIUS (FT)	LENGTH (FT)	DELTA Δ	K	P	DESIGN SPEED (MPH)	ACTUAL SUPERELEVATION (EA) (IN)	UNBALANCED SUPERELEVATION (EU) (IN)	WCB (0°00'00") (TANGENT)	WCB (0°00'00")	
				NORTHING	EASTING										START ANGLE	END ANGLE
	TANGENT	ST	6033+22.76	1853000.91	6578096.13		26,147.41								N 89°54'47" E	
	TANGENT	TS	6294+70.18	1853040.53	6604243.51											
152 N-19 SJD-FRE 4 SB	CLOTHOID	TS	6294+70.18	1853040.53	6604243.51											
	CLOTHOID	SPI	6302+36.85	1853041.69	6605010.18		1,150.00	0°04'56"	575	0.14					N 89°54'47" E	N 89°49'51" E
	CLOTHOID	SC	6306+20.18	1853042.83	6605393.51											
	ARC	SC	6306+20.18	1853042.83	6605393.51											
	ARC	PI	6314+61.49	1853045.31	6606234.82	400,016.50	1,682.62	0°14'28"			250.00	0.50	0.12		N 89°49'51" E	N 89°35'23" E
	ARC	CC		2253057.58	6604212.31											
	ARC	CS	6323+02.80	1853051.33	6607076.11											
	CLOTHOID	CS	6323+02.80	1853051.33	6607076.11											
	CLOTHOID	SPI	6326+86.13	1853054.08	6607459.43		1,150.00	0°04'56"	575	0.14					N 89°35'23" E	N 89°30'27" E
	CLOTHOID	ST	6334+52.80	1853060.67	6608226.07											
152 N-19 SJD-FRE 5 SB	TANGENT	ST	6334+52.80	1853060.67	6608226.07		18,992.35								N 89°30'27" E	
	TANGENT	TS	6524+45.15	1853223.94	6627217.72											
	CLOTHOID	TS	6524+45.15	1853223.94	6627217.72											
	CLOTHOID	SPI	6532+45.15	1853230.82	6628017.69		1,200.00	0°26'00"	600	0.76					N 89°30'27" E	N 89°04'26" E
	CLOTHOID	SC	6536+45.15	1853237.28	6628417.64											
	ARC	SC	6536+45.15	1853237.28	6628417.64											
	ARC	PI	6543+60.21	1853248.84	6629132.61	79,310.00	1,430.09	1°01'59"			250.00	2.00	1.15		N 89°04'26" E	N 88°02'27" E
	ARC	CC		1932536.92	6627135.89											
	ARC	CS	6550+75.24	1853273.28	6629847.26											
	CLOTHOID	CS	6550+75.24	1853273.28	6629847.26											
152 N-19 SJD-FRE 6 SB	CLOTHOID	SPI	6554+75.24	1853286.96	6630247.03		1,200.00	0°26'00"	600	0.76					N 88°02'27" E	N 87°36'27" E
	CLOTHOID	ST	6562+75.24	1853320.36	6631046.33											
	TANGENT	ST	6562+75.24	1853320.36	6631046.33		12,979.69								N 87°36'27" E	
	TANGENT	TS	6692+54.93	1853862.22	6644014.71											
	CLOTHOID	TS	6692+54.93	1853862.22	6644014.71											
	CLOTHOID	SPI	6705+88.35	1853917.88	6645346.96		2,000.00	2°00'12"	999.96	5.83					N 87°36'27" E	N 89°36'39" E
	CLOTHOID	SC	6712+54.93	1853922.41	6646013.69											
	ARC	SC	6712+54.93	1853922.41	6646013.69											
	ARC	PI	6756+47.81	1853952.26	6650406.48	28,600.00	8,717.64	17°27'52"			250.00	6.00	2.74		N 89°36'39" E	S 72°55'29" E
	ARC	CC		1825323.07	6646208.00											
152 N-19 SJD-FRE 6 SB	ARC	CS	6799+72.57	1852662.39	6654605.72											
	CLOTHOID	CS	6799+72.57	1852662.39	6654605.72											
	CLOTHOID	SPI	6806+39.31	1852466.61	6655243.08		2,000.00	2°00'12"	999.96	5.83					S 72°55'29" E	S 70°55'17" E
	CLOTHOID	ST	6819+72.57	1852030.77	6656503.25											

MF-IT-B0051-B.dgn

p005133q 28-OCT-2015:34

REV	DATE	BY	CHK	APP	DESCRIPTION
					10/30/2015

DESIGNED BY
D. OLIVETI
DRAWN BY
S. WILSON
CHECKED BY
N. OUM
IN CHARGE
C. LEMLEY
DATE
10/30/2015

RECORD SET
15% DESIGN
SUBMITTAL
**NOT FOR
CONSTRUCTION**



PARSONS



CALIFORNIA
HIGH-SPEED RAIL AUTHORITY

CALIFORNIA HIGH-SPEED TRAIN PROJECT
MERCED TO FRESNO SECTION
CENTRAL VALLEY WYE
SR 152 (NORTH) TO ROAD 19 WYE ALTERNATIVE
SB TRACK SAN JOSE TO FRESNO GEOMETRY DATA
SHEET 2 OF 9

CONTRACT NO.
HSR08-05
DRAWING NO.
TT-B0051-B
SCALE
N.T.S.
SHEET NO.

TRACK ALIGNMENT DATA SUMMARY TABLE - SR 152 (NORTH) TO ROAD 19 REFINED WYE - SOUTHBOUND TRACK SAN JOSE TO FRESNO (SJD-FRE)

CURVE NUMBER	ELEMENT	POINT TYPE	STATION	COORDINATES		RADIUS (FT)	LENGTH (FT)	DELTA Δ	K	P	DESIGN SPEED (MPH)	ACTUAL SUPERELEVATION (EA) (IN)	UNBALANCED SUPERELEVATION (EU) (IN)	WCB (0° 00' 00") (TANGENT)	WCB (0° 00' 00")	
				NORTHING	EASTING										START ANGLE	END ANGLE
	TANGENT	ST	6819+72.57	1852030.77	6656503.25		5,574.15								S 70° 55' 17" E	
	TANGENT	TS	6875+46.72	1850208.77	6661771.22											
152 N-19 SJD-FRE 7 SB	CLOTHOID	TS	6875+46.72	1850208.77	6661771.22											
	CLOTHOID	SPI	6888+80.14	1849772.93	6663031.40		2,000.00	2° 00' 12"	999.96	5.83					S 70° 55' 17" E	S 68° 55' 05" E
	CLOTHOID	SC	6895+46.72	1849533.10	6663653.52											
	ARC	SC	6895+46.72	1849533.10	6663653.52											
	ARC	PI	6952+07.97	1847496.73	6668935.84	28,600.00	11,178.00	22° 23' 36"			250.00	6.00	2.74		S 68° 55' 05" E	S 46° 31' 29" E
	ARC	CC		1822847.38	6653366.03											
	ARC	CS	7007+24.72	1843601.55	6673044.05											
	CLOTHOID	CS	7007+24.72	1843601.55	6673044.05											
	CLOTHOID	SPI	7013+91.47	1843142.80	6673527.88		2,000.00	2° 00' 12"	999.96	5.83					S 46° 31' 29" E	S 44° 31' 17" E
	CLOTHOID	ST	7027+24.72	1842192.09	6674462.84											
	TANGENT	ST	7027+24.72	1842192.09	6674462.84		14,234.45								S 44° 31' 17" E	
	TANGENT	POE	7169+59.17	1832043.07	6684443.67											

TRACK ALIGNMENT DATA SUMMARY TABLE - SR 152 (NORTH) TO ROAD 19 REFINED WYE - NORTHBOUND TRACK SAN JOSE TO FRESNO (SJD-FRE)

CURVE NUMBER	ELEMENT	POINT TYPE	STATION	COORDINATES		RADIUS (FT)	LENGTH (FT)	DELTA Δ	K	P	DESIGN SPEED (MPH)	ACTUAL SUPERELEVATION (EA) (IN)	UNBALANCED SUPERELEVATION (EU) (IN)	WCB (0° 00' 00") (TANGENT)	WCB (0° 00' 00")	
				NORTHING	EASTING										START ANGLE	END ANGLE
	TANGENT	POB	5338+00.00	1858067.61	6509106.46		13,071.16								S 89° 46' 01" E	
	TANGENT	TS	5468+71.16	1858014.45	6522177.51											
152 N-19 SJD-FRE 1 NB	CLOTHOID	TS	5468+71.16	1858014.45	6522177.51											
	CLOTHOID	SPI	5479+71.18	1858009.98	6523277.52		1,650.00	1° 03' 00"	824.99	2.52					S 89° 46' 01" E	S 88° 43' 01" E
	CLOTHOID	SC	5485+21.16	1857997.66	6523827.40											
	ARC	SC	5485+21.16	1857997.66	6523827.40											
	ARC	PI	5543+60.16	1857866.92	6529664.94	45,016.50	11,613.16	14° 46' 51"			250.00	3.75	1.80		S 88° 43' 01" E	S 73° 56' 10" E
	ARC	CC		1812992.45	6522819.41											
	ARC	CS	5601+34.33	1856251.21	6535275.95											
	CLOTHOID	CS	5601+34.33	1856251.21	6535275.95											
	CLOTHOID	SPI	5606+84.34	1856099.01	6535804.49		1,650.00	1° 03' 00"	824.99	2.52					S 73° 56' 10" E	S 72° 53' 10" E
	CLOTHOID	ST	5617+84.33	1855775.30	6536855.80											
	TANGENT	ST	5617+84.33	1855775.30	6536855.80		1,471.20								S 72° 53' 10" E	
	TANGENT	TS	5632+55.53	1855342.37	6538261.86											

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28-OCT-2015 1:13

p005133g

REV DATE BY CHK APP DESCRIPTION

10/30/2015

DESIGNED BY
D. OLIVETIDRAWN BY
S. WILSONCHECKED BY
N. OUMIN CHARGE
C. LEMLEY

DATE

10/30/2015

RECORD SET
15% DESIGN
SUBMITTAL

NOT FOR
CONSTRUCTION

PARSONS



CALIFORNIA HIGH-SPEED TRAIN PROJECT
MERCED TO FRESNO SECTION
 CENTRAL VALLEY WYE
 SR 152 (NORTH) TO ROAD 19 WYE ALTERNATIVE
 SB & NB TRACK SAN JOSE TO FRESNO GEOMETRY DATA
 SHEET 3 OF 9

CONTRACT NO.
HSR08-05DRAWING NO.
TT-B0052-BSCALE
N.T.S.

SHEET NO.

TRACK ALIGNMENT DATA SUMMARY TABLE - SR 152 (NORTH) TO ROAD 19 REFINED WYE - NORTHBOUND TRACK SAN JOSE TO FRESNO (SJD-FRE)

CURVE NUMBER	ELEMENT	POINT TYPE	STATION	COORDINATES		RADIUS (FT)	LENGTH (FT)	DELTA Δ	K	P	DESIGN SPEED (MPH)	ACTUAL SUPERELEVATION (EA) (IN)	UNBALANCED SUPERELEVATION (EU) (IN)	WCB (0° 00' 00") (TANGENT)	WCB (0° 00' 00")	
				NORTHING	EASTING										START ANGLE	END ANGLE
152 N-19 SJD-FRE 2 NB	CLOTHOID	TS	5632+55.53	1855342.37	6538261.86											
	CLOTHOID	SPI	5642+88.88	1855038.28	6539249.45		1,550.00	0° 59'12"	774.99	2.22					S 72° 53'10" E	S 73° 52'22" E
	CLOTHOID	SC	5648+05.53	1854894.76	6539745.80											
	ARC	SC	5648+05.53	1854894.76	6539745.80											
	ARC	PI	5706+84.84	1853261.65	6545393.75	45,000.00	11,692.40	14° 53'14"			250.00	3.75	1.81		S 73° 52'22" E	S 88° 45'36" E
	ARC	CC		1898123.88	6552245.52											
	ARC	CS	5764+97.93	1853134.42	6551271.69											
	CLOTHOID	CS	5764+97.93	1853134.42	6551271.69											
	CLOTHOID	SPI	5770+14.61	1853123.24	6551788.25		1,550.00	0° 59'12"	774.99	2.22					S 88° 45'36" E	S 89° 44'48" E
	CLOTHOID	ST	5780+47.93	1853118.67	6552821.59											
152 N-19 SJD-FRE 3 NB	TANGENT	ST	5780+47.93	1853118.67	6552821.59		21,750.39								S 89° 44'48" E	
	TANGENT	TS	5997+98.32	1853022.53	6574571.76											
	CLOTHOID	TS	5997+98.32	1853022.53	6574571.76											
	CLOTHOID	SPI	6005+64.98	1853019.14	6575338.42		1,150.00	0° 04'57"	575	0.14					S 89° 44'48" E	S 89° 49'45" E
	CLOTHOID	SC	6009+48.32	1853017.99	6575721.75											
	ARC	SC	6009+48.32	1853017.99	6575721.75											
	ARC	PI	6015+60.47	1853016.17	6576333.90	400,000.00	1,224.31	0° 10'31"			250.00	0.50	0.13		S 89° 49'45" E	N 89° 59'44" E
	ARC	CC		2253016.21	6576914.88											
	ARC	CS	6021+72.63	1853016.22	6576946.06											
	CLOTHOID	CS	6021+72.63	1853016.22	6576946.06											
152 N-19 SJD-FRE 4 NB	CLOTHOID	SPI	6025+55.96	1853016.25	6577329.39		1,150.00	0° 04'57"	575	0.14					N 89° 59'44" E	N 89° 54'47" E
	CLOTHOID	ST	6033+22.63	1853017.41	6578096.06											
	TANGENT	ST	6033+22.63	1853017.41	6578096.06		26,147.46								N 89° 54'47" E	
	TANGENT	TS	6294+70.09	1853057.03	6604243.49											
	CLOTHOID	TS	6294+70.09	1853057.03	6604243.49											
	CLOTHOID	SPI	6302+36.75	1853058.19	6605010.16		1,150.00	0° 04'57"	575	0.14					N 89° 54'47" E	N 89° 49'51" E
	CLOTHOID	SC	6306+20.09	1853059.33	6605393.49											
	ARC	SC	6306+20.09	1853059.33	6605393.49											
	ARC	PI	6314+61.34	1853061.81	6606234.74	400,000.00	1,682.50	0° 14'28"			250.00	0.50	0.13		N 89° 49'51" E	N 89° 35'23" E
	ARC	CC		2253057.58	6604212.31											
28-OCT-2015:09:35 p005133g	ARC	CS	6323+02.59	1853067.83	6607075.97											
	CLOTHOID	CS	6323+02.59	1853067.83	6607075.97											
	CLOTHOID	SPI	6326+85.92	1853070.58	6607459.29		1,150.00	0° 04'57"	575	0.14					N 89° 35'23" E	N 89° 30'27" E
	CLOTHOID	ST	6334+52.59	1853077.17	6608225.93											
	TANGENT	ST	6334+52.59	1853077.17	6608225.93		18,992.35								N 89° 30'27" E	
	TANGENT	TS	6524+44.94	1853240.44	6627217.57											

MF-1T-B0053-B.dgn

28-OCT-2015:09:35

p005133g

DESIGNED BY
D. OLIVETI
DRAWN BY
S. WILSON
CHECKED BY
N. OUM
IN CHARGE
C. LEMLEY
DATE
10/30/2015

RECORD SET
15% DESIGN
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CONSTRUCTION**



PARSONS



**CALIFORNIA HIGH-SPEED TRAIN PROJECT
MERCED TO FRESNO SECTION**
CENTRAL VALLEY WYE
SR 152 (NORTH) TO ROAD 19 WYE ALTERNATIVE
NB TRACK SAN JOSE TO FRESNO GEOMETRY DATA
SHEET 4 OF 9

CONTRACT NO.
HSR08-05
DRAWING NO.
TT-B0053-B
SCALE
N.T.S.
SHEET NO.

TRACK ALIGNMENT DATA SUMMARY TABLE - SR 152 (NORTH) TO ROAD 19 REFINED WYE - NORTHBOUND TRACK SAN JOSE TO FRESNO (SJD-FRE)

CURVE NUMBER	ELEMENT	POINT TYPE	STATION	COORDINATES		RADIUS (FT)	LENGTH (FT)	DELTA Δ	K	P	DESIGN SPEED (MPH)	ACTUAL SUPERELEVATION (EA) (IN)	UNBALANCED SUPERELEVATION (EU) (IN)	WCB (0° 00' 00") (TANGENT)	WCB (0° 00' 00")	
				NORTHING	EASTING										START ANGLE	END ANGLE
152 N-19 SJD-FRE 5 NB	CLOTHOID	TS	6524+44.94	1853240.44	6627217.57											
	CLOTHOID	SPI	6532+44.94	1853247.32	6628017.55		1,200.00	0° 26' 01"	600	0.76					N 89° 30' 27" E	N 89° 04' 26" E
	CLOTHOID	SC	6536+44.94	1853253.78	6628417.50											
	ARC	SC	6536+44.94	1853253.78	6628417.50											
	ARC	PI	6543+59.73	1853265.33	6629132.20	79,293.50	1,429.55	1° 01' 59"			250.00	2.00	1.15		N 89° 04' 26" E	N 88° 02' 27" E
	ARC	CC		1932536.92	6627135.89											
	ARC	CS	6550+74.48	1853289.77	6629846.57											
	CLOTHOID	CS	6550+74.48	1853289.77	6629846.57											
	CLOTHOID	SPI	6554+74.48	1853303.44	6630246.34		1,200.00	0° 26' 01"	600	0.76					N 88° 02' 27" E	N 87° 36' 27" E
	CLOTHOID	ST	6562+74.48	1853336.84	6631045.64											
152 N-19 SJD-FRE 6 NB	TANGENT	ST	6562+74.48	1853336.84	6631045.64		12,979.69								N 87° 36' 27" E	
	TANGENT	TS	6692+54.17	1853878.70	6644014.02											
	CLOTHOID	TS	6692+54.17	1853878.70	6644014.02											
	CLOTHOID	SPI	6705+87.59	1853934.37	6645346.28		2,000.00	2° 00' 08"	999.96	5.82					N 87° 36' 27" E	N 89° 36' 35" E
	CLOTHOID	SC	6712+54.17	1853938.91	6646013.00											
	ARC	SC	6712+54.17	1853938.91	6646013.00											
	ARC	PI	6756+50.18	1853968.86	6650408.91	28,616.50	8,723.82	17° 28' 00"			250.00	6.00	2.74		N 89° 36' 35" E	S 72° 55' 25" E
	ARC	CC		1825323.07	6646208.00											
	ARC	CS	6799+78.00	1852677.99	6654611.12											
	CLOTHOID	CS	6799+78.00	1852677.99	6654611.12											
152 N-19 SJD-FRE 7 SB	CLOTHOID	SPI	6806+44.74	1852482.21	6655248.47		2,000.00	2° 00' 08"	999.96	5.82					S 72° 55' 25" E	S 70° 55' 17" E
	CLOTHOID	ST	6819+78.00	1852046.36	6656508.65											
	TANGENT	ST	6819+78.00	1852046.36	6656508.65		5,574.15								S 70° 55' 17" E	
	TANGENT	TS	6875+52.15	1850224.37	6661776.62											
	CLOTHOID	TS	6875+52.15	1850224.37	6661776.62											
	CLOTHOID	SPI	6888+85.57	1849788.52	6663036.79		2,000.00	2° 00' 08"	999.96	5.82					S 70° 55' 17" E	S 68° 55' 09" E
	CLOTHOID	SC	6895+52.15	1849548.70	6663658.92											
	ARC	SC	6895+52.15	1849548.70	6663658.92											
	ARC	PI	6952+17.27	1847511.05	6668944.89	28,616.50	11,185.60	22° 23' 45"			250.00	6.00	2.74		S 68° 55' 09" E	S 46° 31' 25" E
	ARC	CC		1822847.38	6653366.03											
28-OCT-2015 1:13 p005133g	ARC	CS	7007+37.75	1843613.13	6673055.82											
	CLOTHOID	CS	7007+37.75	1843613.13	6673055.82											
	CLOTHOID	SPI	7014+04.50	1843154.37	6673539.65		2,000.00	2° 00' 08"	999.96	5.82					S 46° 31' 25" E	S 44° 31' 17" E
	CLOTHOID	ST	7027+37.75	1842203.66	6674474.61											
	TANGENT	ST	7027+37.75	1842203.66	6674474.61		14,234.45								S 44° 31' 17" E	
	TANGENT	POE	7169+59.17	1832054.64	6684455.44											

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28-OCT-2015 1:13
p005133g

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DESIGNED BY
D. OLIVETI
DRAWN BY
S. WILSON
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N. OUM
IN CHARGE
C. LEMLEY
DATE
10/30/2015RECORD SET
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CALIFORNIA
HIGH-SPEED RAIL AUTHORITY

**CALIFORNIA HIGH-SPEED TRAIN PROJECT
MERCED TO FRESNO SECTION**
 CENTRAL VALLEY WYE
 SR 152 (NORTH) TO ROAD 19 WYE ALTERNATIVE
 NB TRACK SAN JOSE TO FRESNO GEOMETRY DATA
 SHEET 5 OF 9

CONTRACT NO.
HSR08-05
DRAWING NO.
TT-B0054-B
SCALE
N.T.S.
SHEET NO.

TRACK ALIGNMENT DATA SUMMARY TABLE - SR 152 (NORTH) TO ROAD 19 REFINED WYE - SOUTHBOUND TRACK MERCED TO FRESNO (MER-FRE)

CURVE NUMBER	ELEMENT	POINT TYPE	STATION	COORDINATES		RADIUS (FT)	LENGTH (FT)	DELTA Δ	K	P	DESIGN SPEED (MPH)	ACTUAL SUPERELEVATION (EA) (IN)	UNBALANCED SUPERELEVATION (EU) (IN)	WCB (0°00'00") (TANGENT)	WCB (0°00'00")	
				NORTHING	EASTING										START ANGLE	END ANGLE
	TANGENT	ST	14737+18.92	1851111.82	6659053.15		3,011.22								N 70°55'17" W	
	TANGENT	TS	14767+30.14	1852096.08	6656207.33											
152 N-19 MER-FRE 1 SB	CLOTHOID	TS	14767+30.14	1852096.08	6656207.33											
	CLOTHOID	SPI	14775+30.29	1852357.62	6655451.14		1,200.00	3°20'15"	599.93	5.82					N 70°55'17" W	N 67°35'02" W
	CLOTHOID	SC	14779+30.14	1852510.20	6655081.25											
	ARC	SC	14779+30.14	1852510.20	6655081.25											
	ARC	PI	14843+55.42	1854960.36	6649141.47	10,300.00	11,489.56	63°54'47"			150.00	6.00	2.74		N 67°35'02" W	N 3°40'15" W
	ARC	CC		1862031.91	6659008.96											
	ARC	CS	14894+19.71	1861372.46	6648730.10											
	CLOTHOID	CS	14894+19.71	1861372.46	6648730.10											
	CLOTHOID	SPI	14898+19.83	1861771.76	6648704.48		1,200.00	3°20'15"	599.93	5.82					N 3°40'15" W	N 0°20'00" W
	CLOTHOID	ST	14906+19.71	1862571.89	6648699.82											
152 N-19 MER-FRE 2 SB	TANGENT	ST	14906+19.71	1862571.89	6648699.82		9,282.06								N 0°20'00" W	
	TANGENT	TS	14999+01.77	1871853.80	6648645.84											
	CLOTHOID	TS	14999+01.77	1871853.80	6648645.84											
	CLOTHOID	SPI	15007+01.91	1872653.93	6648641.18		1,200.00	3°20'15"	599.93	5.82					N 0°20'00" W	N 3°40'15" W
	CLOTHOID	SC	15011+01.77	1873053.24	6648615.56											
	ARC	SC	15011+01.77	1873053.24	6648615.56											
	ARC	PI	15102+13.08	1882145.85	6648032.21	10,300.00	14,919.30	82°59'29"			150.00	6.00	2.74		N 3°40'15" W	N 86°39'45" W
	ARC	CC		1872393.78	6638336.70											
	ARC	CS	15160+21.06	1882676.31	6638936.36											
	CLOTHOID	CS	15160+21.06	1882676.31	6638936.36											
152 N-19 MER-FRE 3 SB	CLOTHOID	SPI	15164+21.19	1882699.60	6638536.90		1,200.00	3°20'15"	599.93	5.82					N 86°39'45" W	S 90°00'00" W
	CLOTHOID	ST	15172+21.06	1882699.60	6637736.76											
	TANGENT	ST	15172+21.06	1882699.60	6637736.76		9,855.25								S 90°00'00" W	
	TANGENT	TS	15270+76.31	1882699.60	6627881.52											
	CLOTHOID	TS	15270+76.31	1882699.60	6627881.52											
	CLOTHOID	SPI	15282+23.07	1882699.60	6626734.76		1,720.00	2°13'19"	859.96	5.56					S 90°00'00" W	N 87°46'41" W
	CLOTHOID	SC	15287+96.31	1882721.83	6626161.77											
	ARC	SC	15287+96.31	1882721.83	6626161.77											
	ARC	PI	15370+85.45	1883043.20	6617878.87	22,177.00	15,865.13	40°59'19"			220.00	6.00	2.73		N 87°46'41" W	N 46°47'22" W
	ARC	CC		1904882.16	6627021.56											
28-OCT-2015:35 p005133g MF-IT-B0055-B.dgn	ARC	CS	15446+61.44	1888718.61	6611837.39											
	CLOTHOID	CS	15446+61.44	1888718.61	6611837.39											
	CLOTHOID	SPI	15452+34.86	1889111.21	6611419.46		1,720.00	2°13'19"	859.96	5.56					N 46°47'22" W	N 44°34'03" W
	CLOTHOID	ST	15463+81.44	1889928.19	6610614.72											

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CALIFORNIA HIGH-SPEED TRAIN PROJECT
MERCED TO FRESNO SECTION

CENTRAL VALLEY WYE

SR 152 (NORTH) TO ROAD 19 WYE ALTERNATIVE

SB TRACK MERCED TO FRESNO GEOMETRY DATA

SHEET 6 OF 9

REV

DATE

BY

CHK

APP

DESCRIPTION

DESIGNED BY
D. OLIVETI
DRAWN BY
S. WILSON
CHECKED BY
N. OUM
IN CHARGE
C. LEMLEY
DATE
10/30/2015RECORD SET
15% DESIGN
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CALIFORNIA HIGH-SPEED TRAIN PROJECT
MERCED TO FRESNO SECTION
CENTRAL VALLEY WYE
SR 152 (NORTH) TO ROAD 19 WYE ALTERNATIVE
SB TRACK MERCED TO FRESNO GEOMETRY DATA
SHEET 6 OF 9CONTRACT NO.
HSR08-05
DRAWING NO.
TT-B0055-B
SCALE
N.T.S.
SHEET NO.

TRACK ALIGNMENT DATA SUMMARY TABLE - SR 152 (NORTH) TO ROAD 19 REFINED WYE - SOUTHBOUND TRACK MERCED TO FRESNO (MER-FRE)

CURVE NUMBER	ELEMENT	POINT TYPE	STATION	COORDINATES		RADIUS (FT)	LENGTH (FT)	DELTA Δ	K	P	DESIGN SPEED (MPH)	ACTUAL SUPERELEVATION (EA) (IN)	UNBALANCED SUPERELEVATION (EU) (IN)	WCB (0° 00' 00") (TANGENT)	WCB (0° 00' 00")	
				NORTHING	EASTING										START ANGLE	END ANGLE
	TANGENT	ST	15463+81.44	1889928.19	6610614.72		1,000.00								N 44° 34'03" W	
	TANGENT	TS	15473+81.44	1890640.61	6609912.97											
152 N-19 MER-FRE 4 SB	CLOTHOID	TS	15473+81.44	1890640.61	6609912.97										N 44° 34'03" W	N 44° 32'05" W
	CLOTHOID	SPI	15480+48.11	1891115.56	6609445.14		1,000.00	0° 01'59"	500	0.05						
	CLOTHOID	SC	15483+81.44	1891353.17	6609211.36											
	ARC	SC	15483+81.44	1891353.17	6609211.36											
	ARC	PI	15488+81.71	1891709.77	6608860.50	867,000.00	1,000.54	0° 03'58"			220.00	0.25	0.00		N 44° 32'05" W	N 44° 28'06" W
	ARC	CC		2499414.67	7227232.57											
	ARC	CS	15493+81.98	1892066.78	6608510.06											
	CLOTHOID	CS	15493+81.98	1892066.78	6608510.06											
	CLOTHOID	SPI	15497+15.31	1892304.66	6608276.55		1,000.00	0° 01'59"	500	0.05					N 44° 28'06" W	N 44° 26'08" W
	CLOTHOID	ST	15503+81.98	1892780.69	6607809.81											
152 N-19 MER-FRE 5 SB	TANGENT	ST	15503+81.98	1892780.69	6607809.81		1,550.00								N 44° 26'08" W	
	TANGENT	TS	15519+31.98	1893887.45	6606724.65											
	CLOTHOID	TS	15519+31.98	1893887.45	6606724.65											
	CLOTHOID	SPI	15525+98.65	1894363.48	6606257.91		1,000.00	0° 01'59"	500	0.05					N 44° 26'08" W	N 44° 28'06" W
	CLOTHOID	SC	15529+31.98	1894601.36	6606024.41											
	ARC	SC	15529+31.98	1894601.36	6606024.41											
	ARC	PI	15534+32.25	1894958.36	6605673.96	867,000.00	1,000.54	0° 03'58"			220.00	0.25	0.00		N 44° 28'06" W	N 44° 32'05" W
	ARC	CC		1287253.47	5987301.89											
	ARC	CS	15539+32.51	1895314.97	6605323.11											
	CLOTHOID	CS	15539+32.51	1895314.97	6605323.11											
152 N-19 MER-FRE 5 SB	CLOTHOID	SPI	15542+65.85	1895552.58	6605089.33		1,000.00	0° 01'59"	500	0.05					N 44° 32'05" W	N 44° 34'03" W
	CLOTHOID	ST	15549+32.51	1896027.53	6604621.49											
	TANGENT	ST	15549+32.51	1896027.53	6604621.49		10,567.48								N 44° 34'03" W	
	TANGENT	POE	15655+00.00	1903556.04	6597205.75											

TRACK ALIGNMENT DATA SUMMARY TABLE - SR 152 (NORTH) TO ROAD 19 REFINED WYE - NORTHBOUND TRACK MERCED TO FRESNO (MER-FRE)

CURVE NUMBER	ELEMENT	POINT TYPE	STATION	COORDINATES		RADIUS (FT)	LENGTH (FT)	DELTA Δ	K	P	DESIGN SPEED (MPH)	ACTUAL SUPERELEVATION (EA) (IN)	UNBALANCED SUPERELEVATION (EU) (IN)	WCB (0° 00' 00") (TANGENT)	WCB (0° 00' 00")	
				NORTHING	EASTING										START ANGLE	END ANGLE
	TANGENT	ST	24734+58.58	1851084.63	6659365.80		3,325.05								N 70° 55'17" W	
	TANGENT	TS	24767+83.63	1852171.47	6656223.40											

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p0042226

DESCRIPTION

REV DATE BY CHK APP

DESIGNED BY
D. OLIVETI
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S. WILSON
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IN CHARGE
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DATE
03/18/2016RECORD SET
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CALIFORNIA
HIGH-SPEED RAIL AUTHORITYCALIFORNIA HIGH-SPEED TRAIN PROJECT
MERCED TO FRESNO SECTION
CENTRAL VALLEY WYE
SR 152 (NORTH) TO ROAD 19 WYE ALTERNATIVE
SB & NB TRACK MERCED TO FRESNO GEOMETRY DATA
SHEET 7 OF 9CONTRACT NO.
HSR08-05
DRAWING NO.
TT-B0056-B
SCALE
N.T.S.
SHEET NO.

TRACK ALIGNMENT DATA SUMMARY TABLE - SR 152 (NORTH) TO ROAD 19 REFINED WYE - NORTHBOUND TRACK MERCED TO FRESNO (MER-FRE)

CURVE NUMBER	ELEMENT	POINT TYPE	STATION	COORDINATES		RADIUS (FT)	LENGTH (FT)	DELTA △	K	P	DESIGN SPEED (MPH)	ACTUAL SUPERELEVATION (EA) (IN)	UNBALANCED SUPERELEVATION (EU) (IN)	WCB (0° 00' 00") (TANGENT)	WCB (0° 00' 00")	
				NORTHING	EASTING										START ANGLE	END ANGLE
152 N-19 MER-FRE 1 NB	CLOTHOID	TS	24767+83.63	1852171.47	6656223.40											
	CLOTHOID	SPI	24775+83.77	1852433.01	6655467.20		1,200.00	3° 20'15"	599.93	5.82					N 70° 55'17" W	N 67° 35'02" W
	CLOTHOID	SC	24779+83.63	1852585.59	6655097.31											
	ARC	SC	24779+83.63	1852585.59	6655097.31											
	ARC	PI	24844+08.91	1855035.75	6649157.54	10,300.00	11,489.56	63° 54'47"			150.00	6.00	2.74		N 67° 35'02" W	N 3° 40'15" W
	ARC	CC		1862107.30	6659025.02											
	ARC	CS	24894+73.19	1861447.85	6648746.16											
	CLOTHOID	CS	24894+73.19	1861447.85	6648746.16											
	CLOTHOID	SPI	24898+73.32	1861847.16	6648720.54		1,200.00	3° 20'15"	599.93	5.82					N 3° 40'15" W	N 0° 20'00" W
	CLOTHOID	ST	24906+73.19	1862647.28	6648715.88											
152 N-19 MER-FRE 2 NB	TANGENT	ST	24906+73.19	1862647.28	6648715.88		9,233.67								N 0° 20'00" W	
	TANGENT	TS	24999+06.86	1871880.80	6648662.18											
	CLOTHOID	TS	24999+06.86	1871880.80	6648662.18											
	CLOTHOID	SPI	25007+07.00	1872680.93	6648657.52		1,200.00	3° 20'15"	599.93	5.82					N 0° 20'00" W	N 3° 40'15" W
	CLOTHOID	SC	25011+06.86	1873080.24	6648631.91											
	ARC	SC	25011+06.86	1873080.24	6648631.91											
	ARC	PI	25102+18.17	1882172.85	6648048.56	10,300.00	14,919.30	82° 59'29"			150.00	6.00	2.74		N 3° 40'15" W	N 86° 39'45" W
	ARC	CC		1872420.78	6638353.04											
	ARC	CS	25160+26.15	1882703.31	6638952.70											
	CLOTHOID	CS	25160+26.15	1882703.31	6638952.70											
152 N-19 MER-FRE 3 NB	CLOTHOID	SPI	25164+26.28	1882726.60	6638553.25		1,200.00	3° 20'15"	599.93	5.82					N 86° 39'45" W	S 90° 00'00" W
	CLOTHOID	ST	25172+26.15	1882726.60	6637753.11											
	TANGENT	ST	25172+26.15	1882726.60	6637753.11		9,871.59								S 90° 00'00" W	
	TANGENT	TS	25270+97.74	1882726.60	6627881.52											
	CLOTHOID	TS	25270+97.74	1882726.60	6627881.52											
	CLOTHOID	SPI	25282+44.50	1882726.60	6626734.76		1,720.00	2° 13'28"	859.96	5.56					S 90° 00'00" W	N 87° 46'32" W
	CLOTHOID	SC	25288+17.74	1882748.86	6626161.78											
	ARC	SC	25288+17.74	1882748.86	6626161.78											
	ARC	PI	25370+95.59	1883070.18	6617890.17	22,150.00	15,843.72	40° 59'00"			220.00	6.00	2.74		N 87° 46'32" W	N 46° 47'32" W
	ARC	CC		1904882.17	6627021.56											
28-OCT-2015:36 p005133g	ARC	CS	25446+61.46	1888737.58	6611856.64											
	CLOTHOID	CS	25446+61.46	1888737.58	6611856.64										N 46° 47'32" W	N 44° 34'03" W
	CLOTHOID	SPI	25452+34.88	1889130.16	6611438.69		1,720.00	2° 13'28"	859.96	5.56						
	CLOTHOID	ST	25463+81.46	1889947.14	6610633.96											
	TANGENT	ST	25463+81.46	1889947.14	6610633.96		19,118.54								N 44° 34'03" W	
	TANGENT	POE	25655+00.00	1903567.62	6597217.51											

MF-IT-B0057-B.dgn

p005133g

28-OCT-2015:36

MF-IT-B0057-B.dgn

TRACK ALIGNMENT DATA SUMMARY TABLE - SR 152 (NORTH) TO ROAD 19 REFINED WYE - NORTHBOUND TRACK MERCED TO FRESNO (MER-FRE)

REV DATE BY CHK APP DESCRIPTION

DESIGNED BY
D. OLIVETI
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15% DESIGN
SUBMITTALNOT FOR
CONSTRUCTION

PARSONS

CALIFORNIA
HIGH-SPEED RAIL AUTHORITYCALIFORNIA HIGH-SPEED TRAIN PROJECT
MERCED TO FRESNO SECTION
CENTRAL VALLEY WYE
SR 152 (NORTH) TO ROAD 19 WYE ALTERNATIVE
NB TRACK MERCED TO FRESNO GEOMETRY DATA
SHEET 8 OF 9CONTRACT NO.
HSR08-05DRAWING NO.
TT-B0057-BSCALE
N.T.S.

SHEET NO.

TRACK ALIGNMENT DATA SUMMARY TABLE - SR 152 (NORTH) TO ROAD 19 REFINED WYE - SOUTHBOUND TRACK SAN JOSE TO MERCED (SJD-MER)

CURVE NUMBER	ELEMENT	POINT TYPE	STATION	COORDINATES		RADIUS (FT)	LENGTH (FT)	DELTA Δ	K	P	DESIGN SPEED (MPH)	ACTUAL SUPERELEVATION (EA) (IN)	UNBALANCED SUPERELEVATION (EU) (IN)	WCB (0°00'00") (TANGENT)	WCB (0°00'00")	
				NORTHING	EASTING										START ANGLE	END ANGLE
	TANGENT	ST	36591+67.62	1853492.54	6633933.64		4251.45								N 87°36'27" E	
	TANGENT	TS	36634+19.07	1853670.03	6638181.39											
152 N-19 SJD-MER 1 SB	CLOTHOID	TS	36634+19.07	1853670.03	6638181.39											
	CLOTHOID	SPI	36642+19.22	1853703.43	6638980.83		1,200.00	3°20'15"	599.93	5.82					N 87°36'27" E	N 84°16'11" E
	CLOTHOID	SC	36646+19.07	1853743.38	6639378.96											
	ARC	SC	36646+19.07	1853743.38	6639378.96											
	ARC	PI	36734+57.45	1854625.84	6648173.17	10,300.00	14,608.99	81°15'55"			150.00	6.00	2.74		N 84°16'11" E	N 3°00'16" E
	ARC	CC		1863991.91	6638350.56											
	ARC	CS	36792+28.07	1863452.07	6648636.41											
	CLOTHOID	CS	36792+28.07	1863452.07	6648636.41											
	CLOTHOID	SPI	36796+28.20	1863851.65	6648657.38		1,200.00	3°20'15"	599.93	5.82					N 3°00'16" E	N 0°20'00" W
	CLOTHOID	ST	36804+28.07	1864651.78	6648652.73											
	TANGENT	ST	36804+28.07	1864651.78	6648652.73		3132.95								N 0°20'00" W	
	TANGENT	TS	36835+61.02	1867784.67	6648634.50											

TRACK ALIGNMENT DATA SUMMARY TABLE - SR 152 (NORTH) TO ROAD 19 REFINED WYE - NORTHBOUND TRACK SAN JOSE TO MERCED (SJD-MER)

CURVE NUMBER	ELEMENT	POINT TYPE	STATION	COORDINATES		RADIUS (FT)	LENGTH (FT)	DELTA Δ	K	P	DESIGN SPEED (MPH)	ACTUAL SUPERELEVATION (EA) (IN)	UNBALANCED SUPERELEVATION (EU) (IN)	WCB (0°00'00") (TANGENT)	WCB (0°00'00")	
				NORTHING	EASTING										START ANGLE	END ANGLE
	TANGENT	ST	46591+67.62	1853406.12	6633937.25		4251.50								N 87°36'27" E	
	TANGENT	TS	46634+19.12	1853583.60	6638185.05											
152 N-19 SJD-MER 1 NB	CLOTHOID	TS	46634+19.12	1853583.60	6638185.05											
	CLOTHOID	SPI	46642+19.26	1853617.01	6638984.49		1,200.00	3°18'35"	599.93	5.78					N 87°36'27" E	N 84°17'51" E
	CLOTHOID	SC	46646+19.12	1853656.76	6639382.64											
	ARC	SC	46646+19.12	1853656.76	6639382.64											
	ARC	PI	46735+40.47	1854543.21	6648259.84	10,386.50	14,741.76	81°19'16"			150.00	6.00	2.67		N 84°17'51" E	N 2°58'36" E
	ARC	CC		1863991.86	6638350.61											
	ARC	CS	46793+60.88	1863452.52	6648723.10											
	CLOTHOID	CS	46793+60.88	1863452.52	6648723.10											
	CLOTHOID	SPI	46797+61.01	1863852.11	6648743.88		1,200.00	3°18'35"	599.93	5.78					N 2°58'36" E	N 0°20'00" W
	CLOTHOID	ST	46805+60.88	1864652.24	6648739.22											
	TANGENT	ST	46805+60.88	1864652.24	6648739.22		3133.01								N 0°20'00" W	
	TANGENT	TS	46836+93.89	1867785.19	6648721.00											

MF-IT-B0058-B.dgn

p005133g 28-OCT-2015:36

REV

DATE

BY

CHK

APP

DESCRIPTION

DESIGNED BY
D. OLIVETI
DRAWN BY
S. WILSON
CHECKED BY
N. OUM
IN CHARGE
C. LEMLEY
DATE
10/30/2015

RECORD SET
15% DESIGN
SUBMITTAL

NOT FOR
CONSTRUCTION




PARSONS




**CALIFORNIA HIGH-SPEED TRAIN PROJECT
MERCED TO FRESNO SECTION**
CENTRAL VALLEY WYE
SR 152 (NORTH) TO ROAD 19 WYE ALTERNATIVE
SB & NB TRACK SAN JOSE TO MERCED GEOMETRY DATA
SHEET 9 OF 9

CONTRACT NO.
HSR08-05
DRAWING NO.
TT-B0058-B
SCALE
N.T.S.
SHEET NO.

MERCED COUNTY

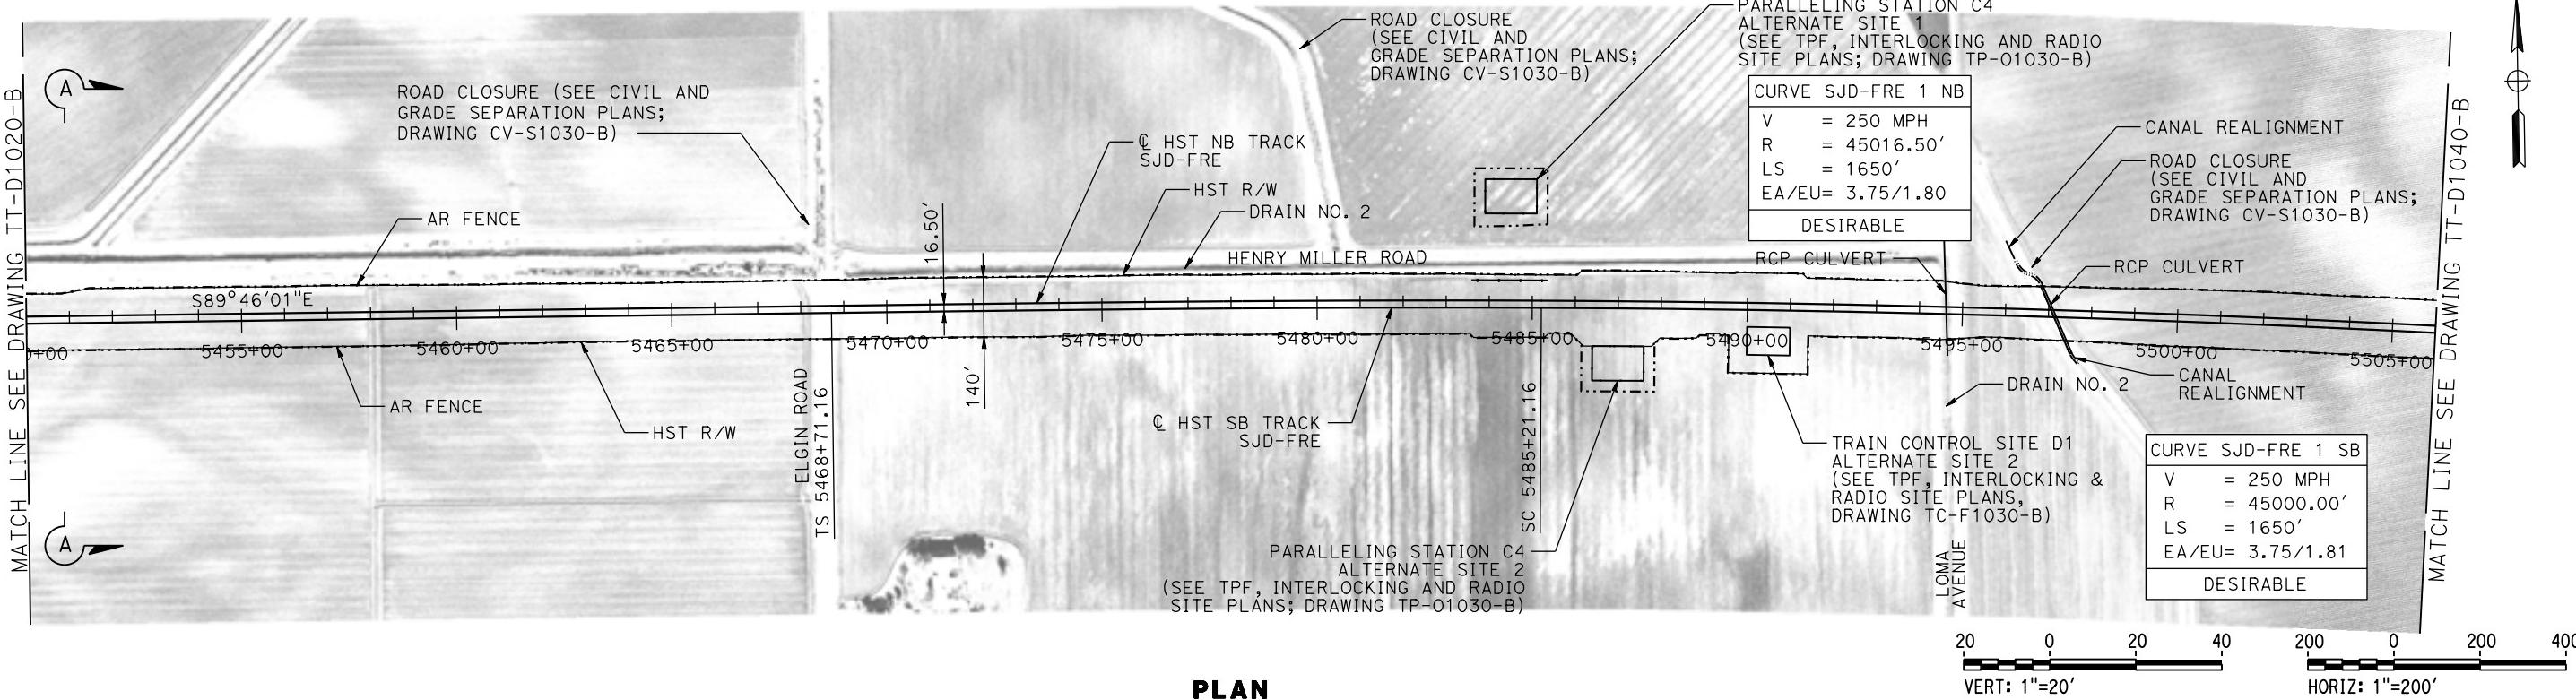


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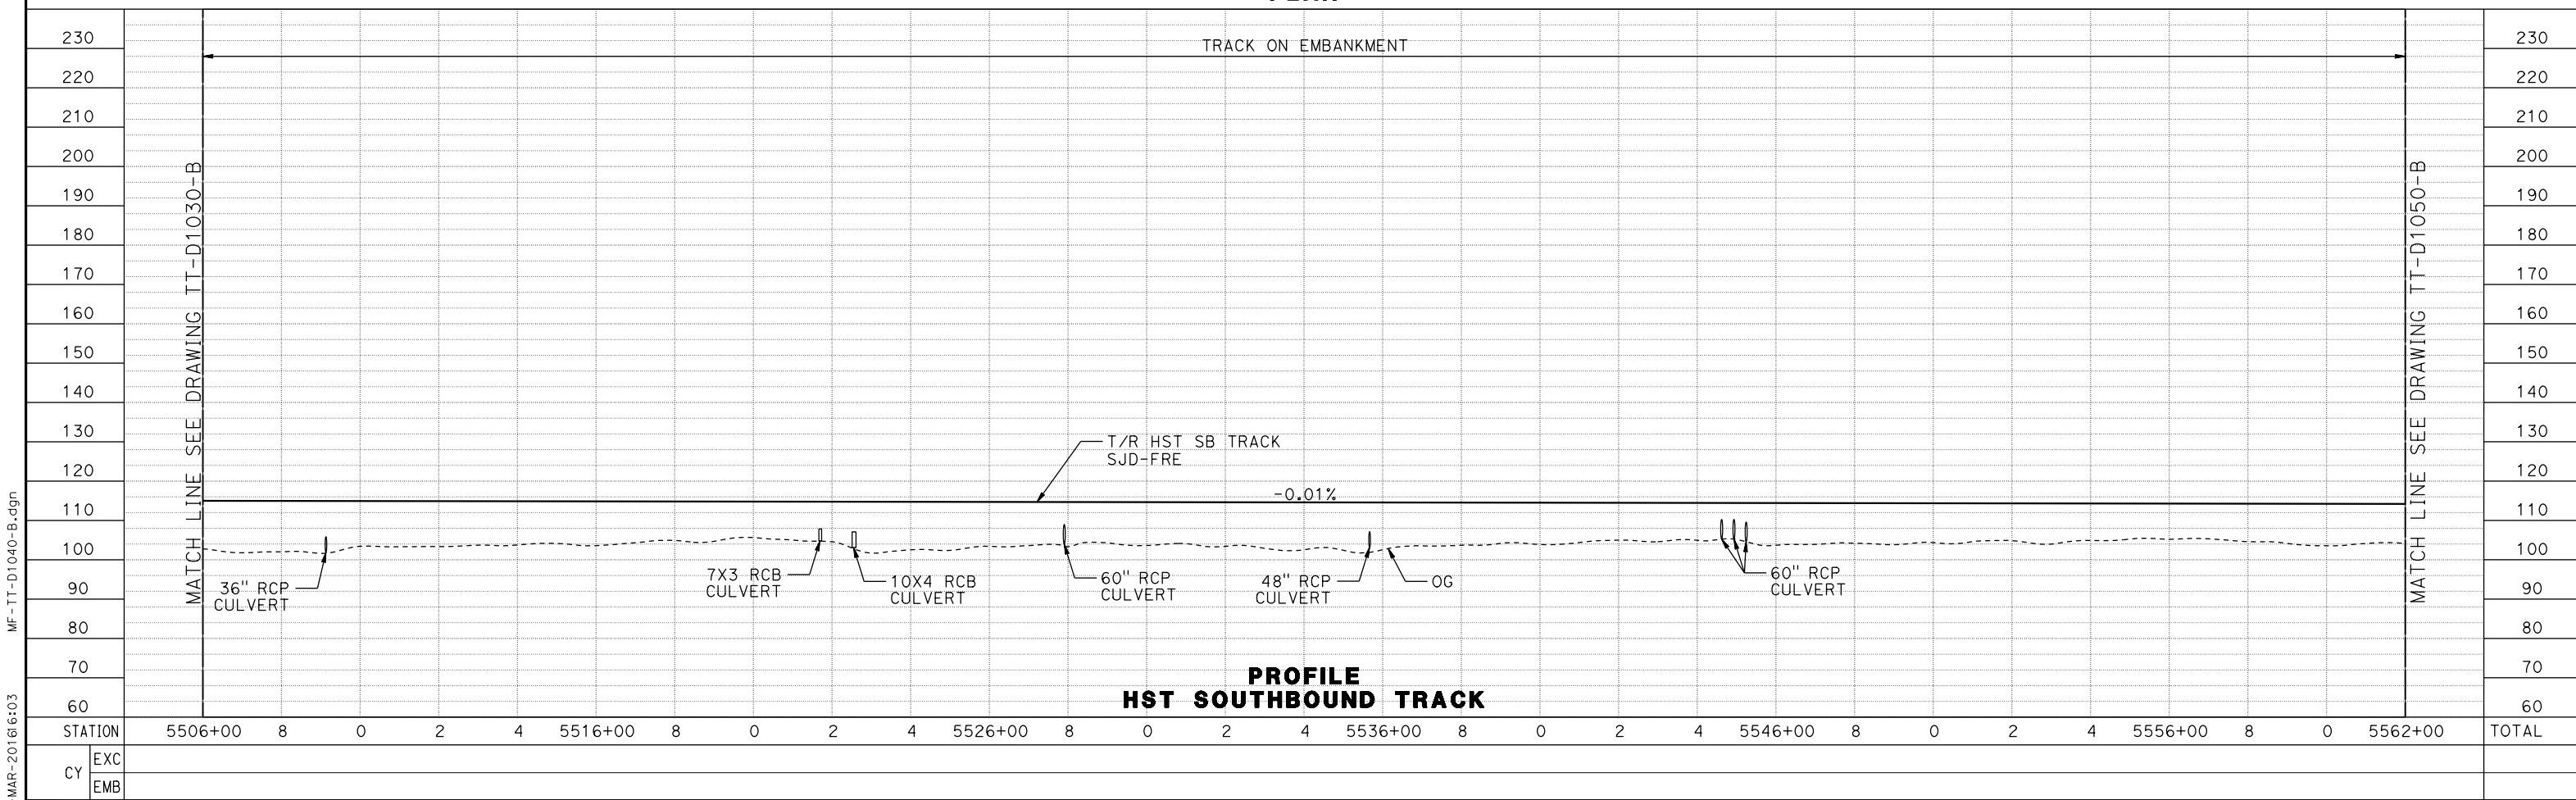

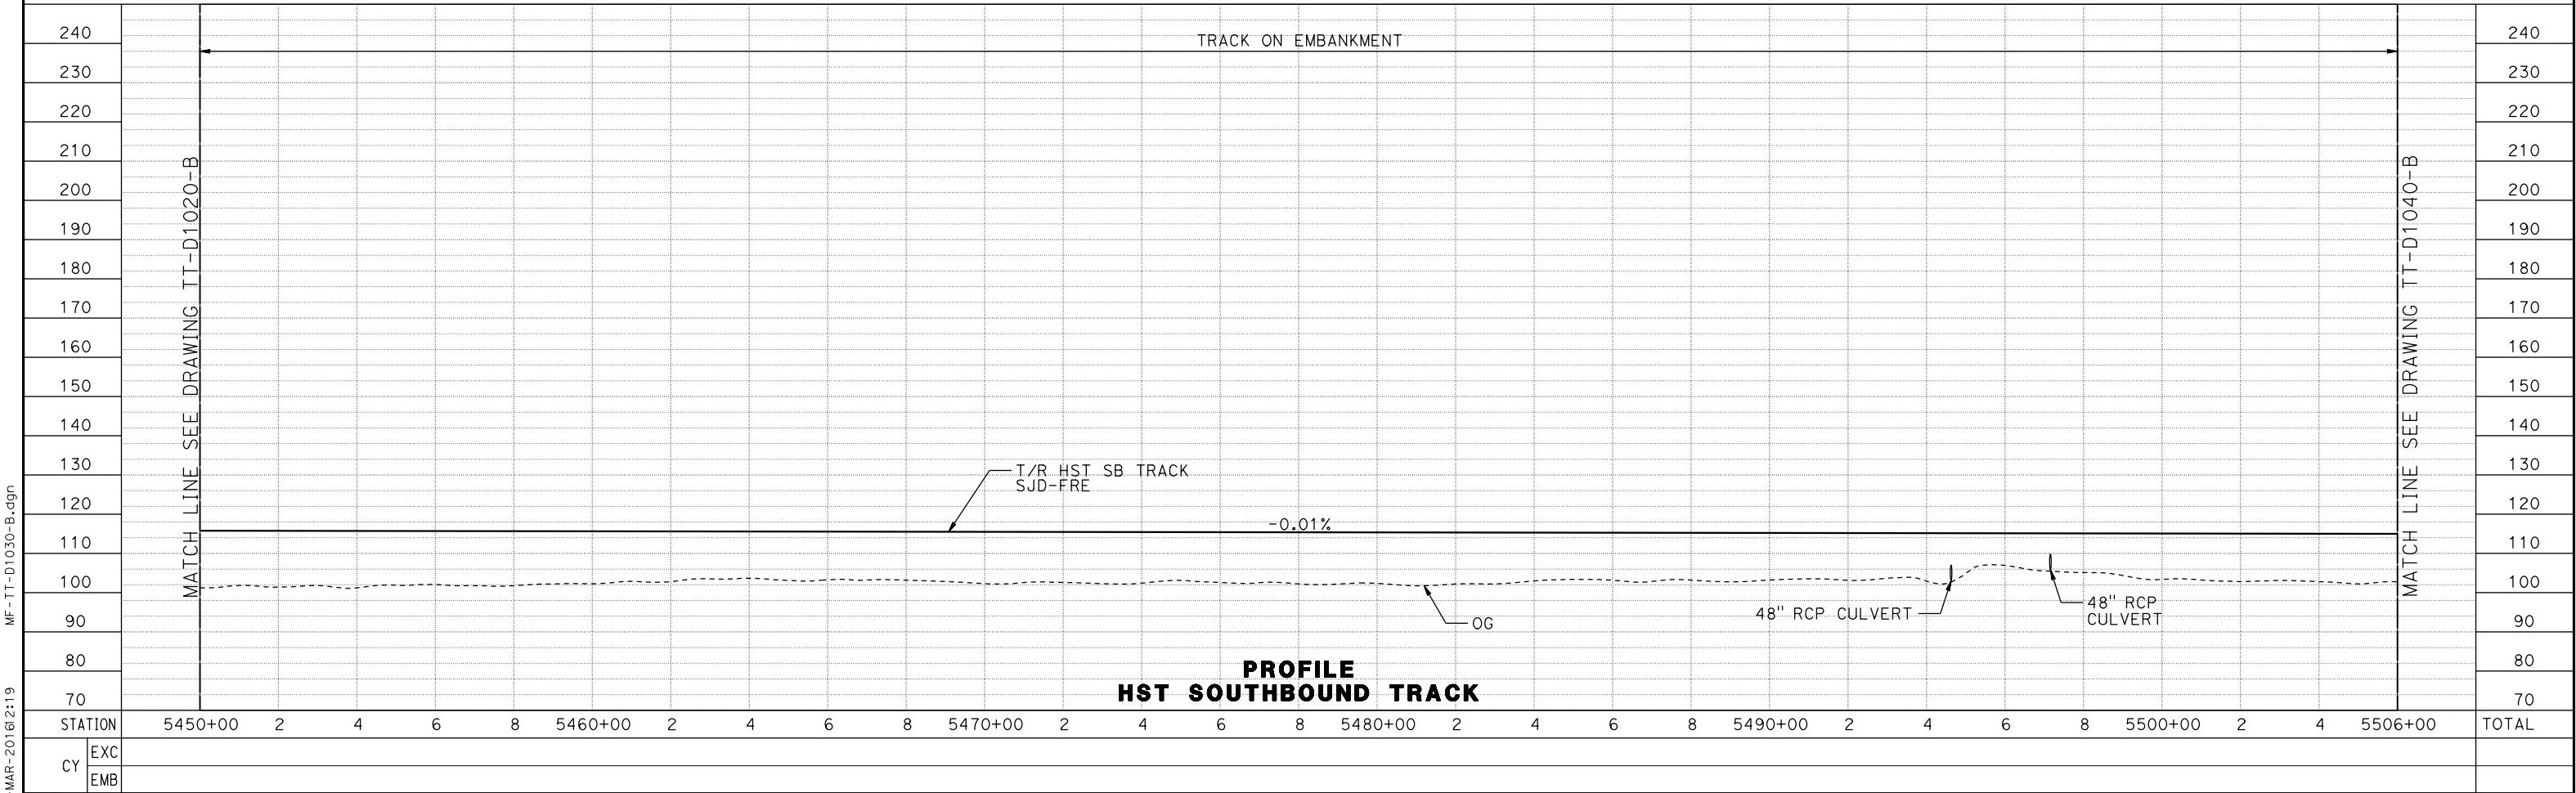
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0004226					DRAWN BY S. WILSON				CENTRAL VALLEY WYE SR 152 (NORTH) TO ROAD 19 WYE ALTERNATIVE TRACK PLAN AND PROFILE SJD-FRE STA 5450+00 TO 5506+00	DRAWING NO. TT-D1030-B	
					CHECKED BY N. OUM					SCALE AS SHOWN	
					IN CHARGE C. LEMLEY					SHEET NO. _____	
					DATE 03/18/2016	NOT FOR CONSTRUCTION					
REV	DATE	BY	CHK	APP	DESCRIPTION						

MERCED COUNTY


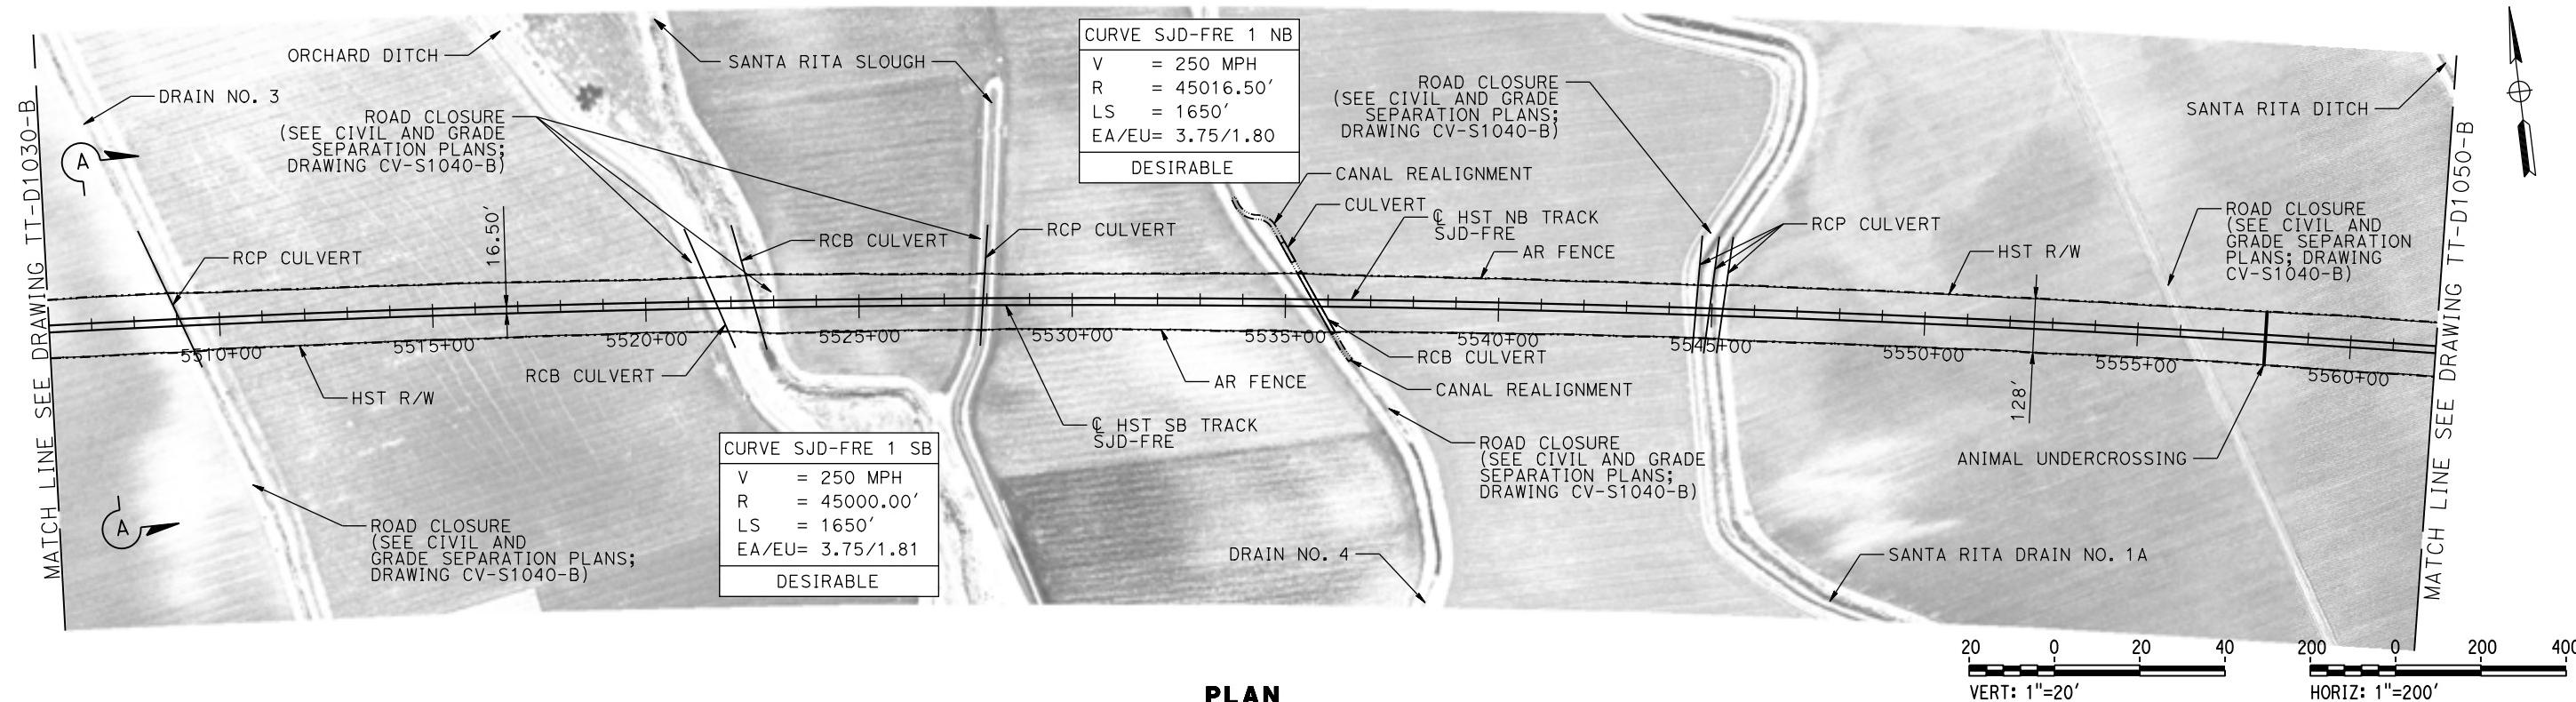


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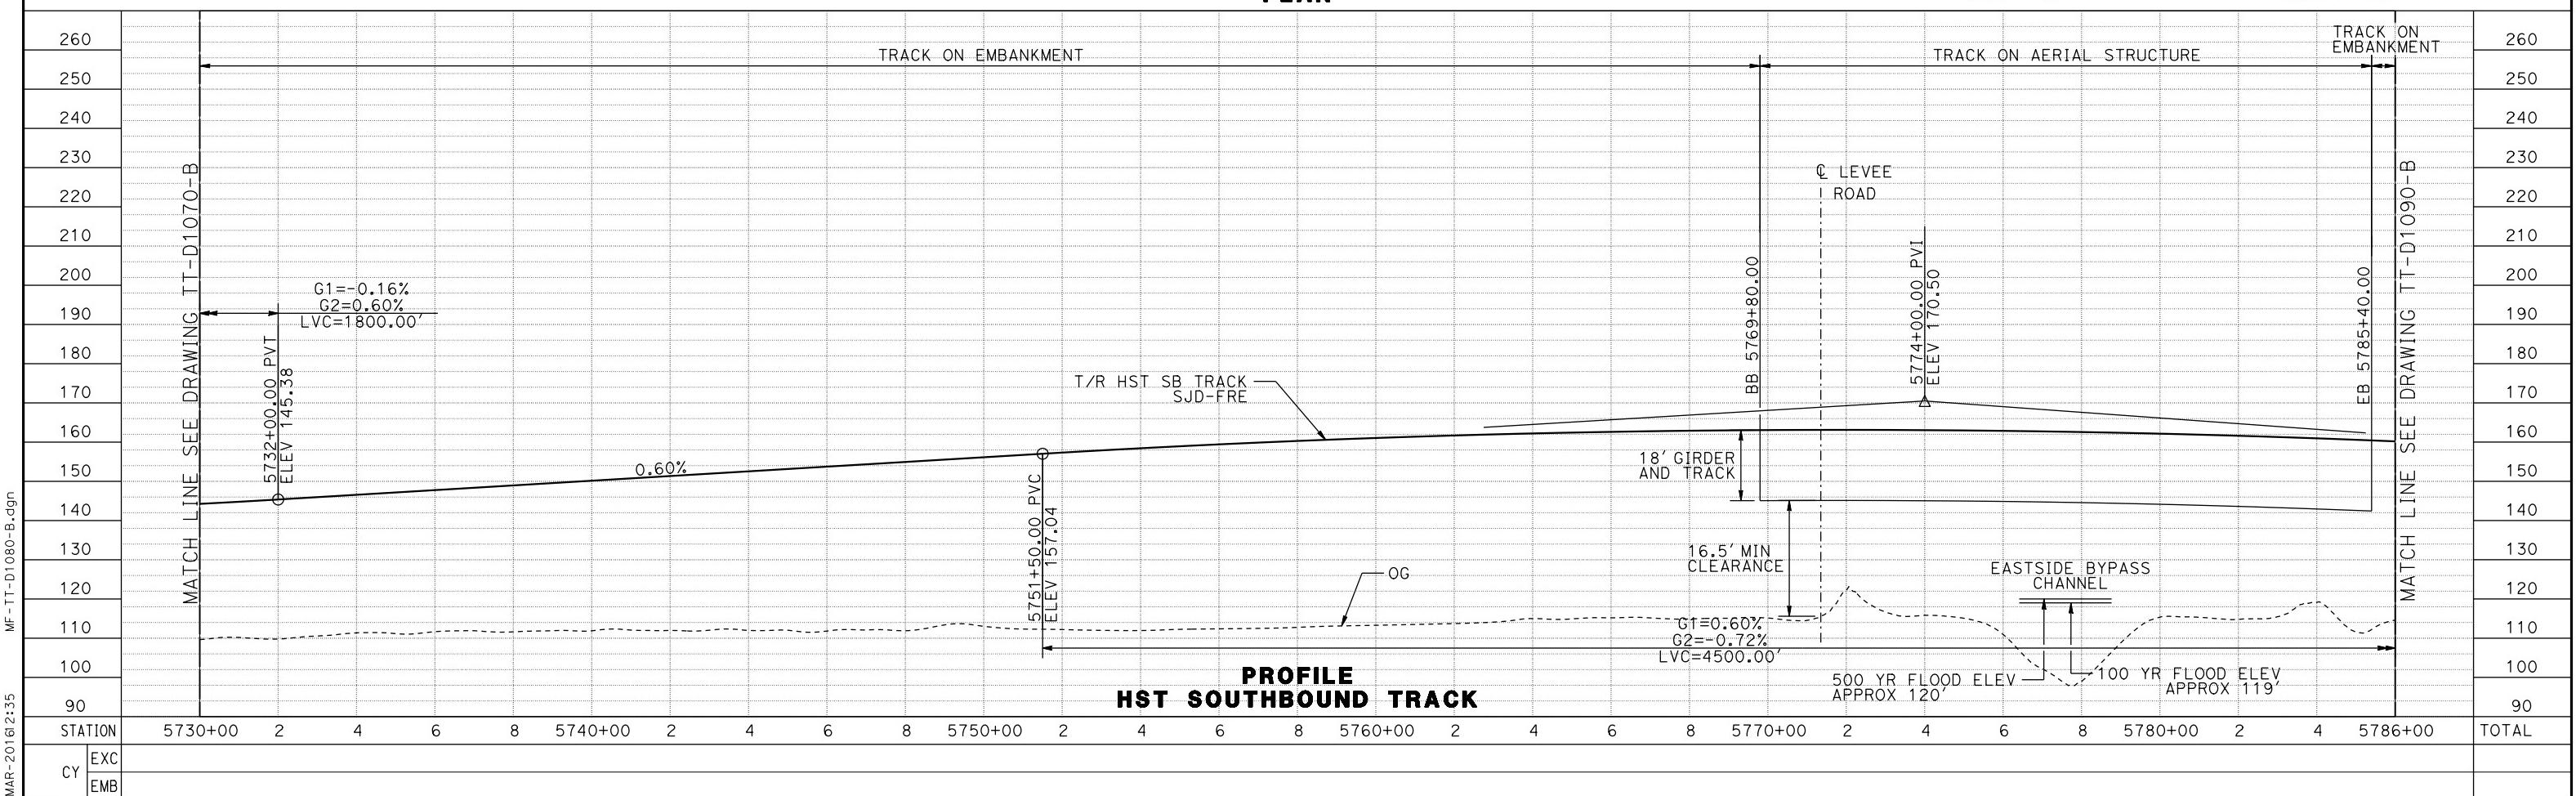
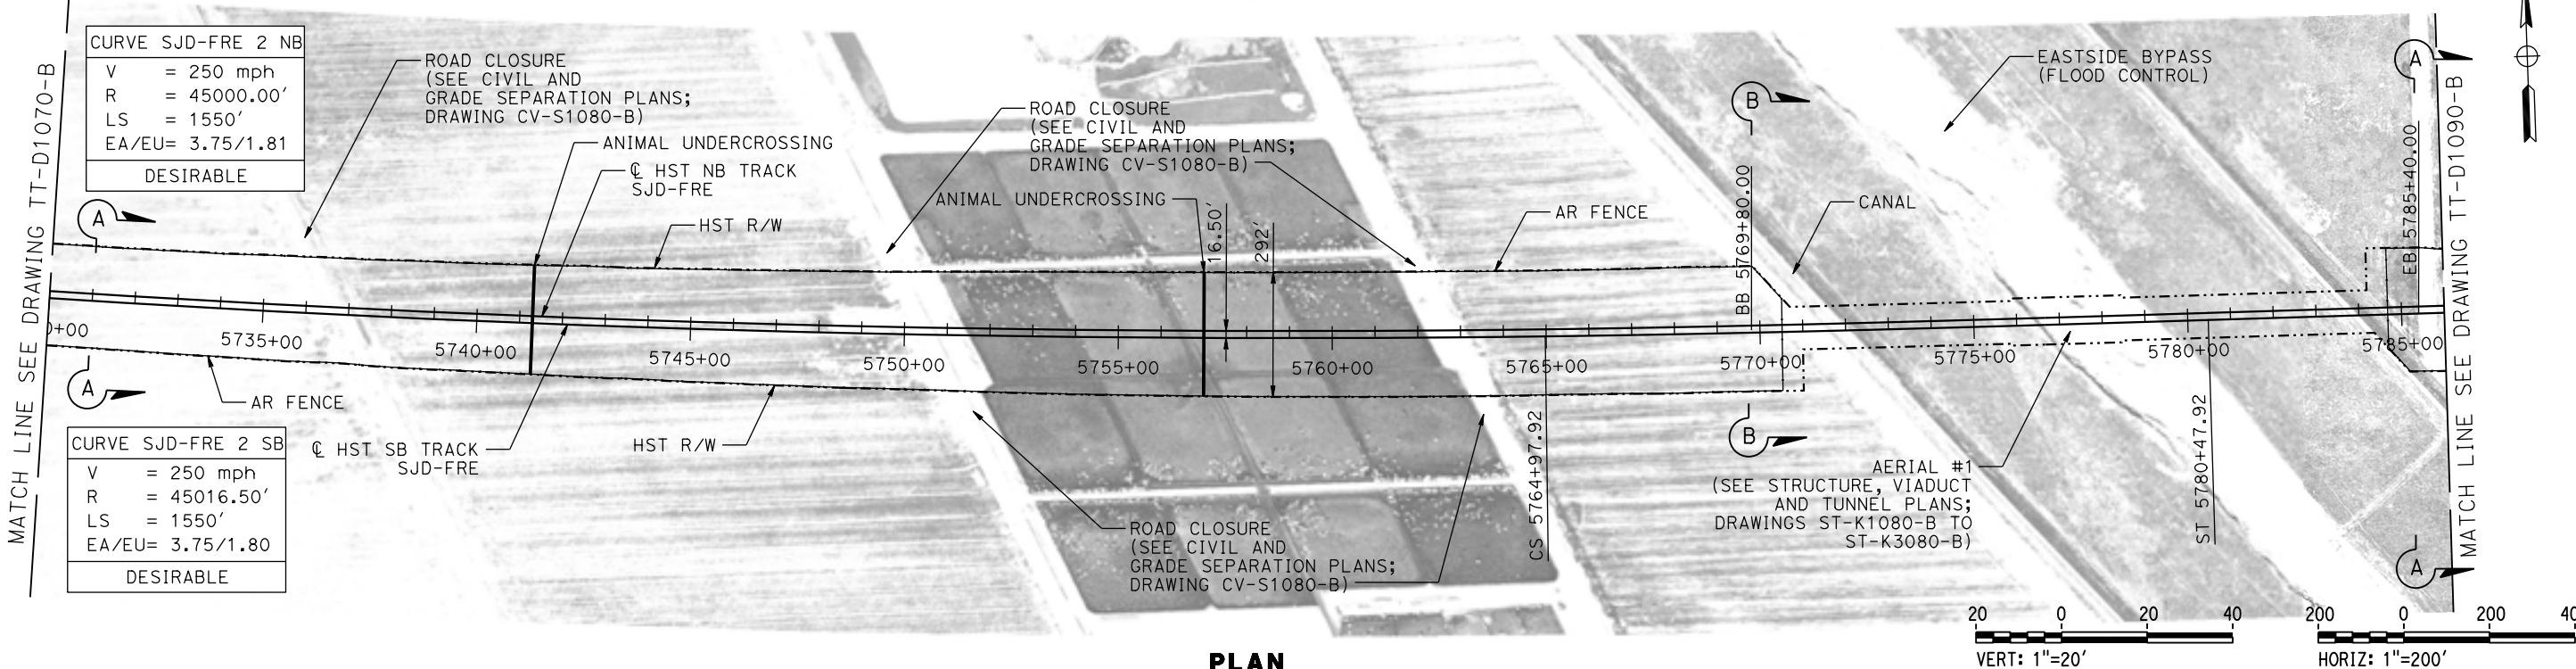
DESIGNED BY D. OLIVETI	RECORD SET 15% DESIGN SUBMITTAL	 PARSONS	 CALIFORNIA HIGH-SPEED RAIL AUTHORITY	CALIFORNIA HIGH-SPEED TRAIN PROJECT MERCED TO FRESNO SECTION CENTRAL VALLEY WYE SR 152 (NORTH) TO ROAD 19 WYE ALTERNATIVE TRACK PLAN AND PROFILE SJD-FRE STA 5506+00 TO 5562+00	CONTRACT NO. HSR08-05
DRAWN BY S. WILSON					DRAWING NO. TT-D1040-B
CHECKED BY N. OUM					SCALE AS SHOWN
IN CHARGE C. LEMLEY					SHEET NO. 0004226
DATE 03/18/2016					
REV DATE BY CHK APP	DESCRIPTION				

MERCED COUNTY





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p0042226					DRAWN BY S. WILSON				CENTRAL VALLEY WYE SR 152 (NORTH) TO ROAD 19 WYE ALTERNATIVE TRACK PLAN AND PROFILE	DRAWING NO. TT-D1060-B	
					CHECKED BY N. OUM				SJD-FRE STA 5618+00 TO 5674+00	SCALE AS SHOWN	
					IN CHARGE C. LEMLEY					SHEET NO. 000	
					DATE 03/18/2016	NOT FOR CONSTRUCTION					
REV	DATE	BY	CHK	APP	DESCRIPTION						

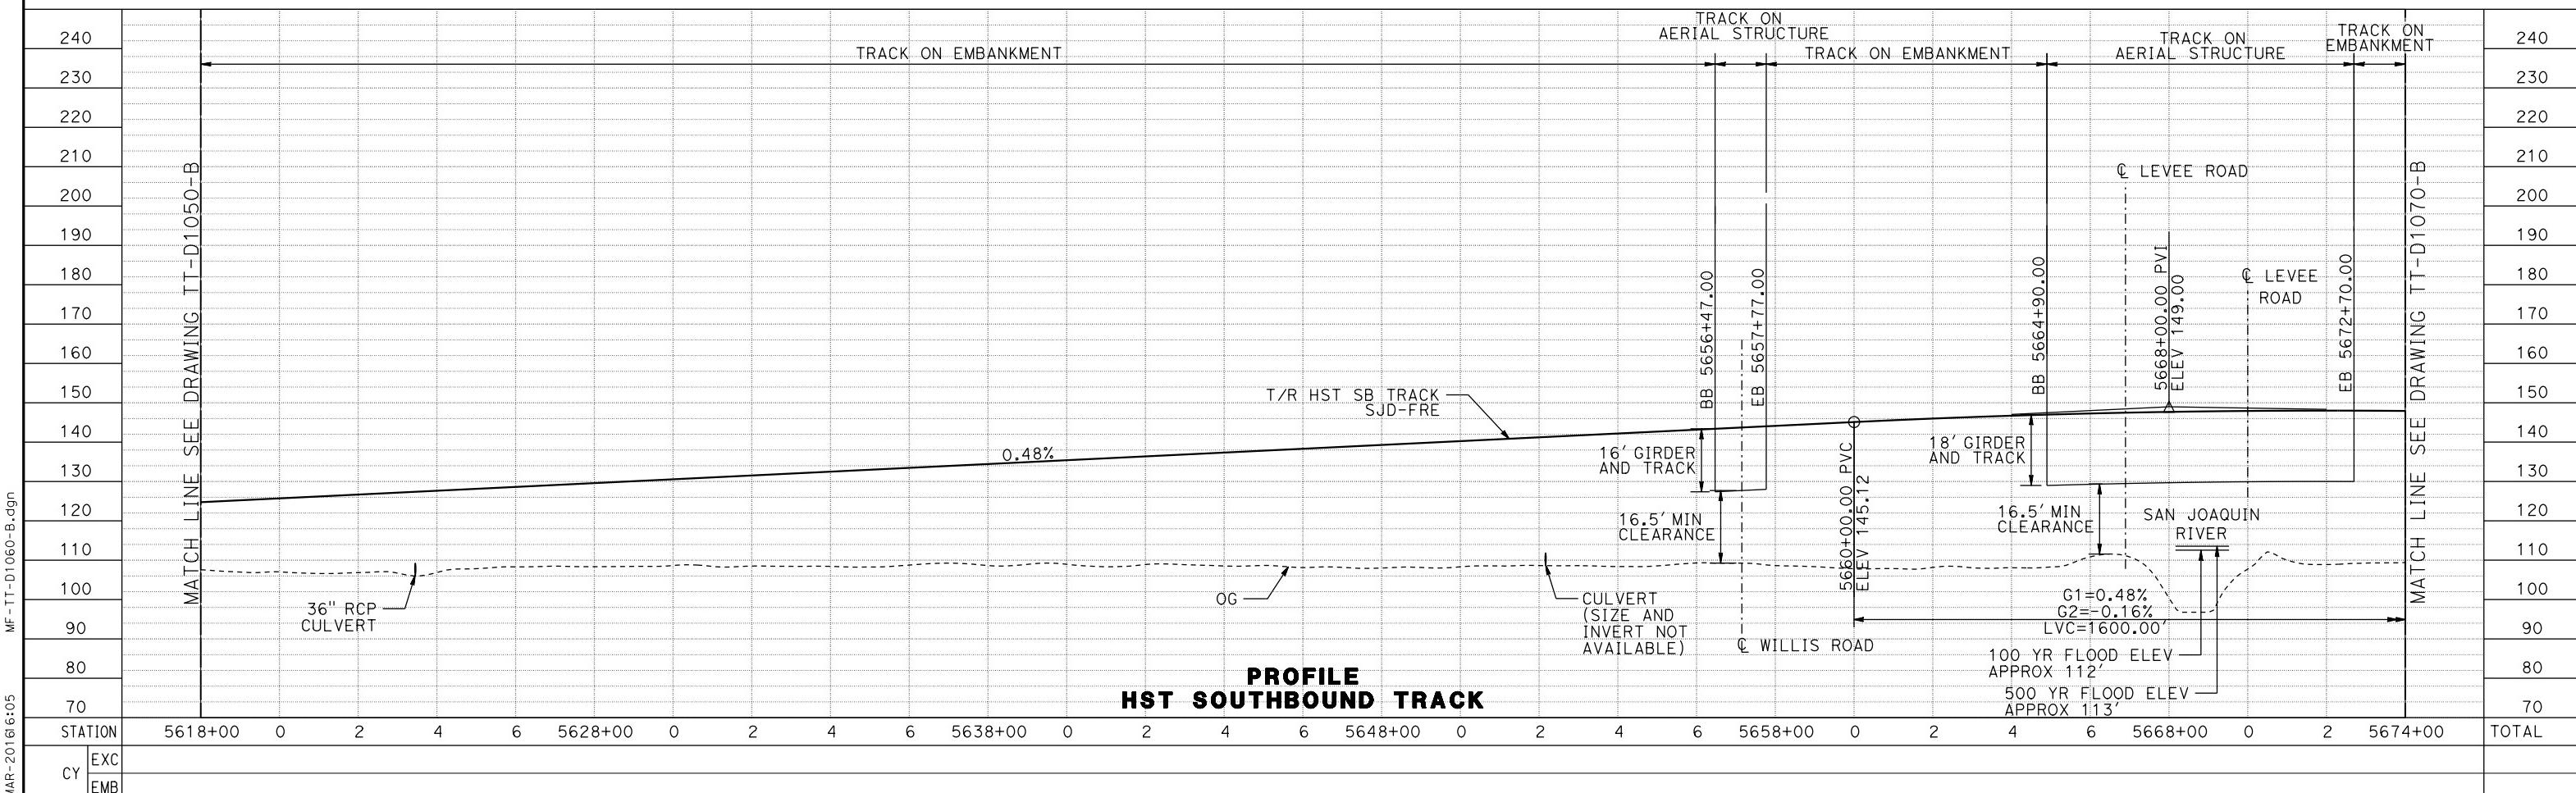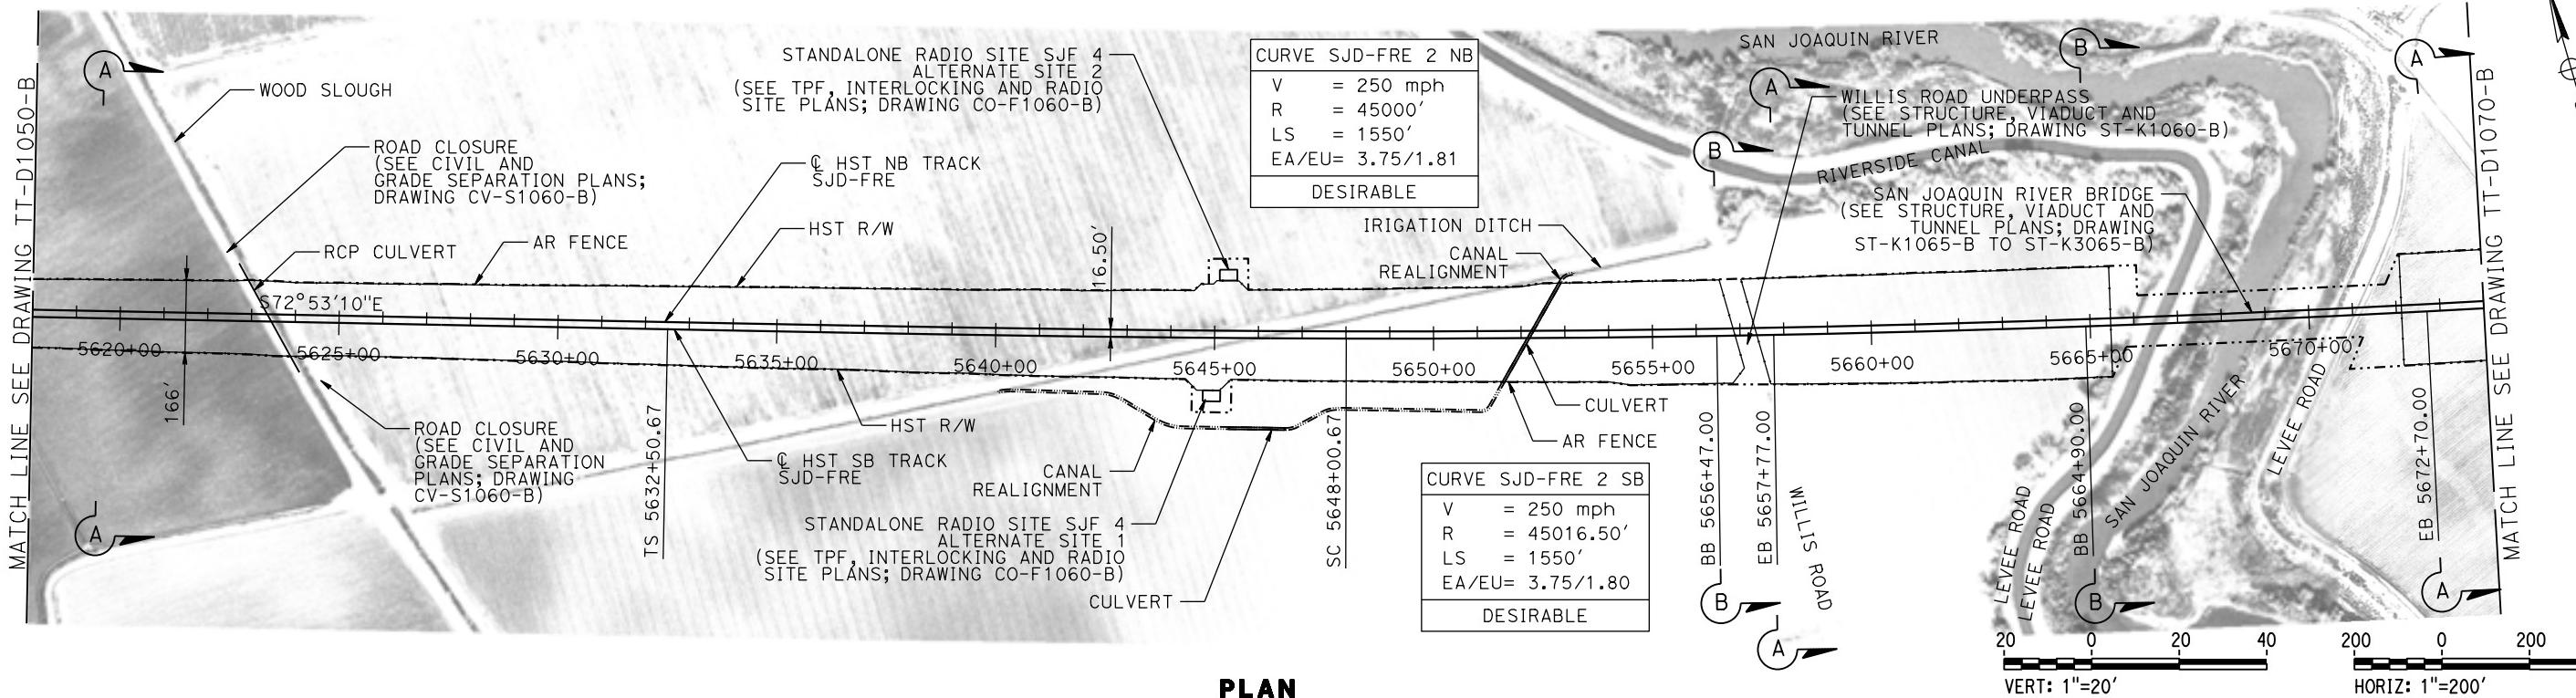MERCED COUNTY




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					DRAWN BY S. WILSON				CENTRAL VALLEY WYE SR 152 (NORTH) TO ROAD 19 WYE ALTERNATIVE TRACK PLAN AND PROFILE	DRAWING NO. TT-D1080-B	
					CHECKED BY N. OUM				SJD-FRE STA 5730+00 TO 5786+00	SCALE AS SHOWN	
					IN CHARGE C. LEMLEY	NOT FOR CONSTRUCTION				SHEET NO. 0004226	
					DATE 03/18/2016						
REV	DATE	BY	CHK	APP	DESCRIPTION						

MERCED COUNTY

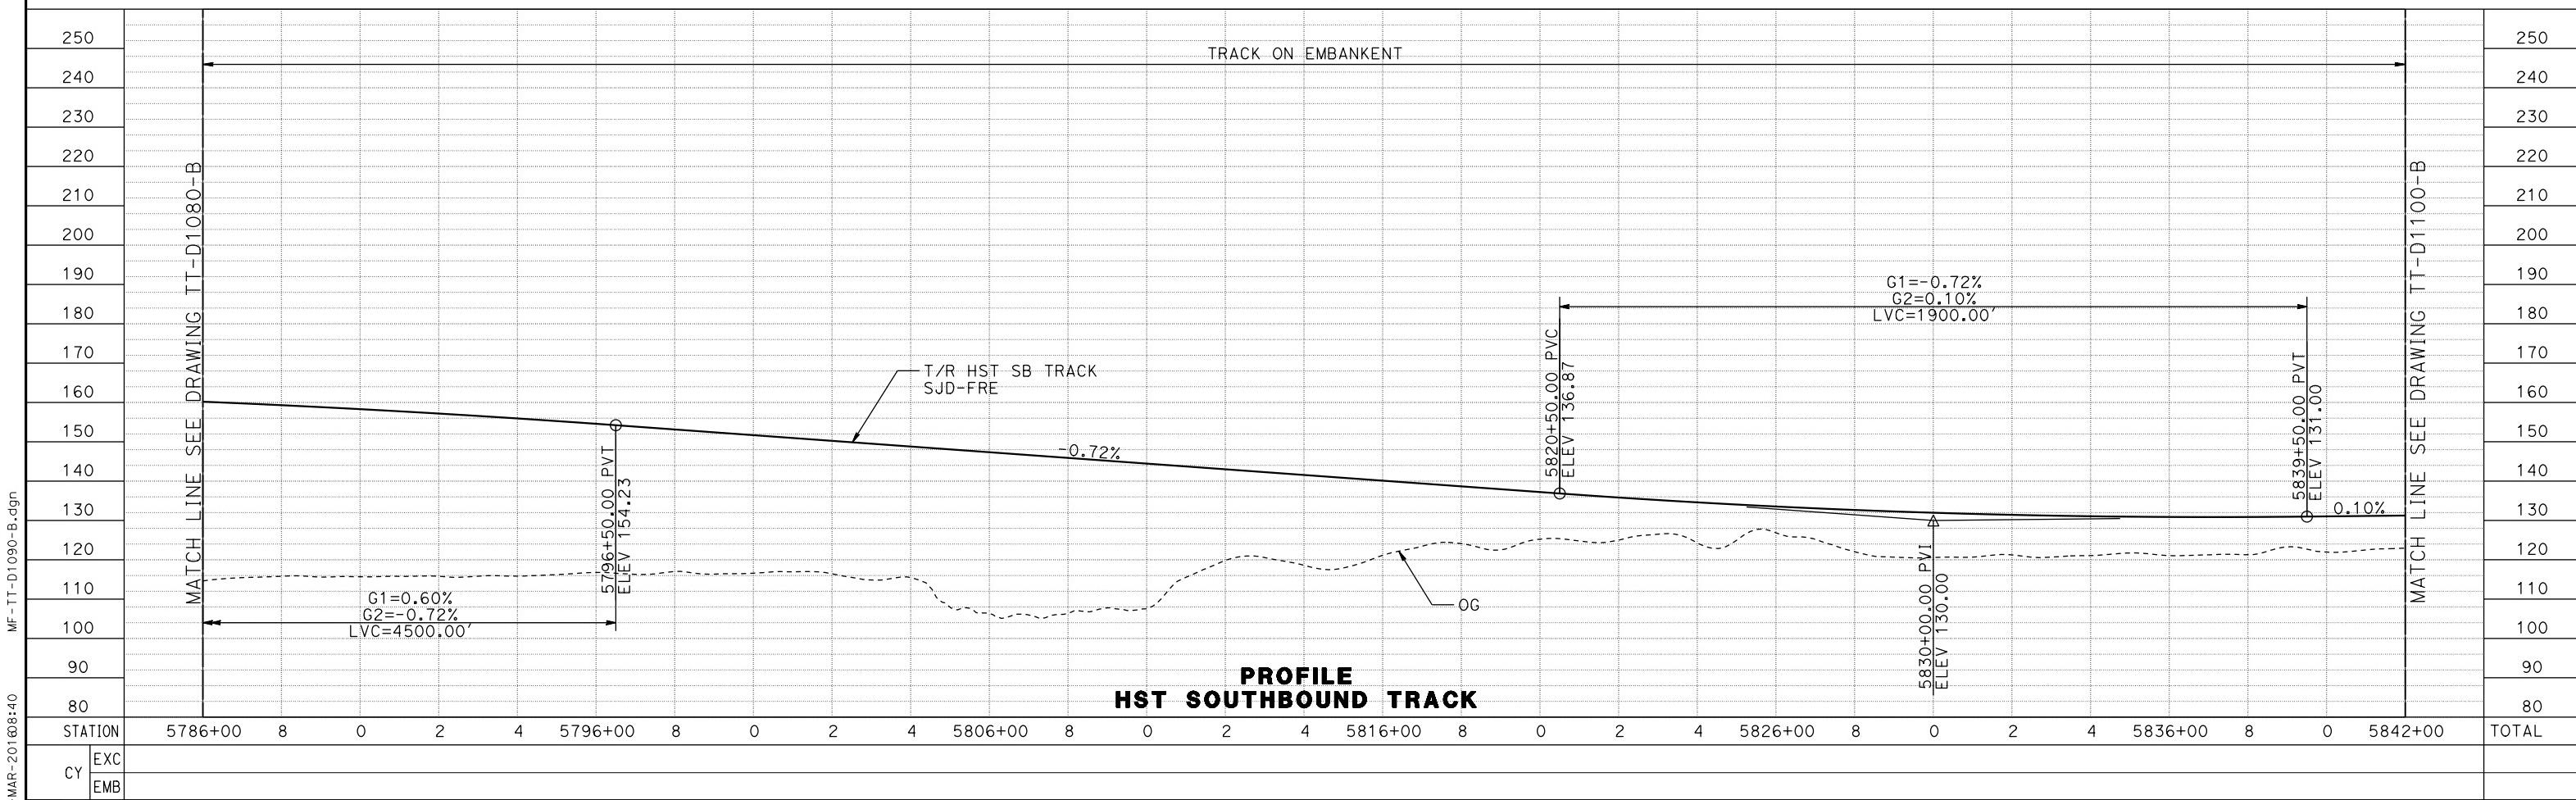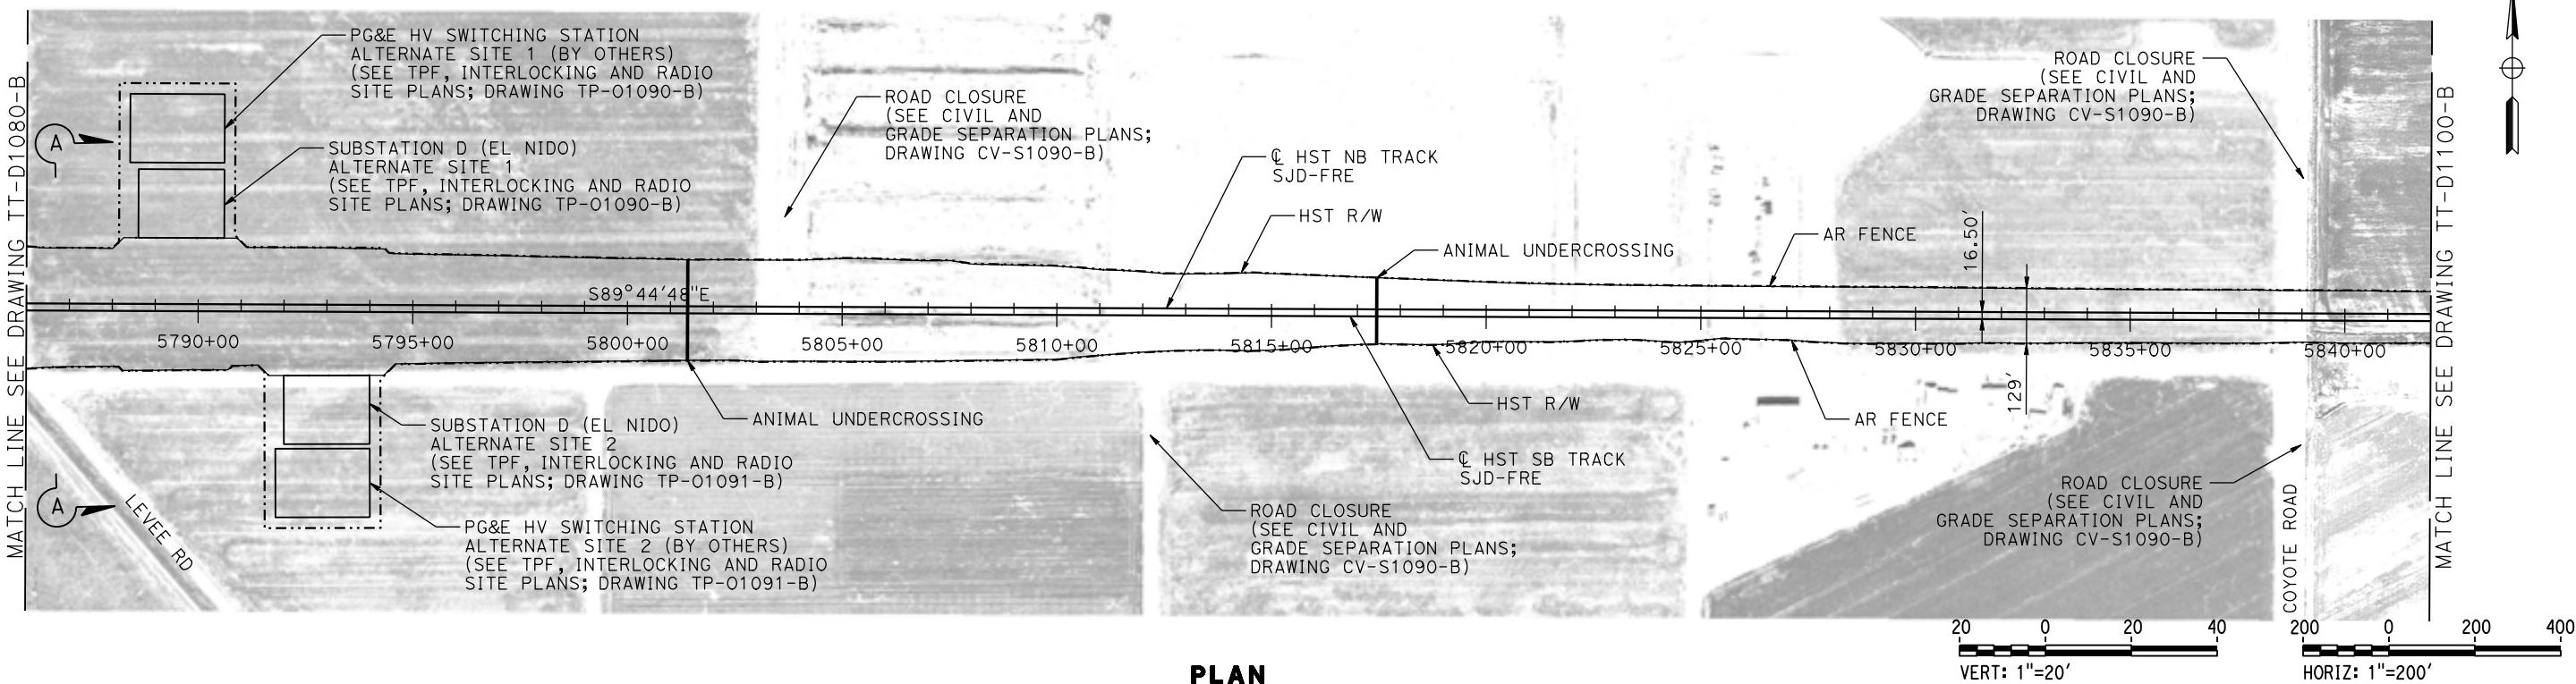


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					DRAWN BY S. WILSON				CENTRAL VALLEY WYE	DRAWING NO. TT-D1090-B
					CHECKED BY N. OUM				SR 152 (NORTH) TO ROAD 19 WYE ALTERNATIVE	SCALE AS SHOWN
					IN CHARGE C. LEMLEY	NOT FOR CONSTRUCTION			TRACK PLAN AND PROFILE	SHEET NO. 0001
p004226	REV	DATE	BY	CHK	APP	DESCRIPTION	DATE 03/18/2016		SJD-FRE STA 5786+00 TO 5842+00	

MADERA COUNTY


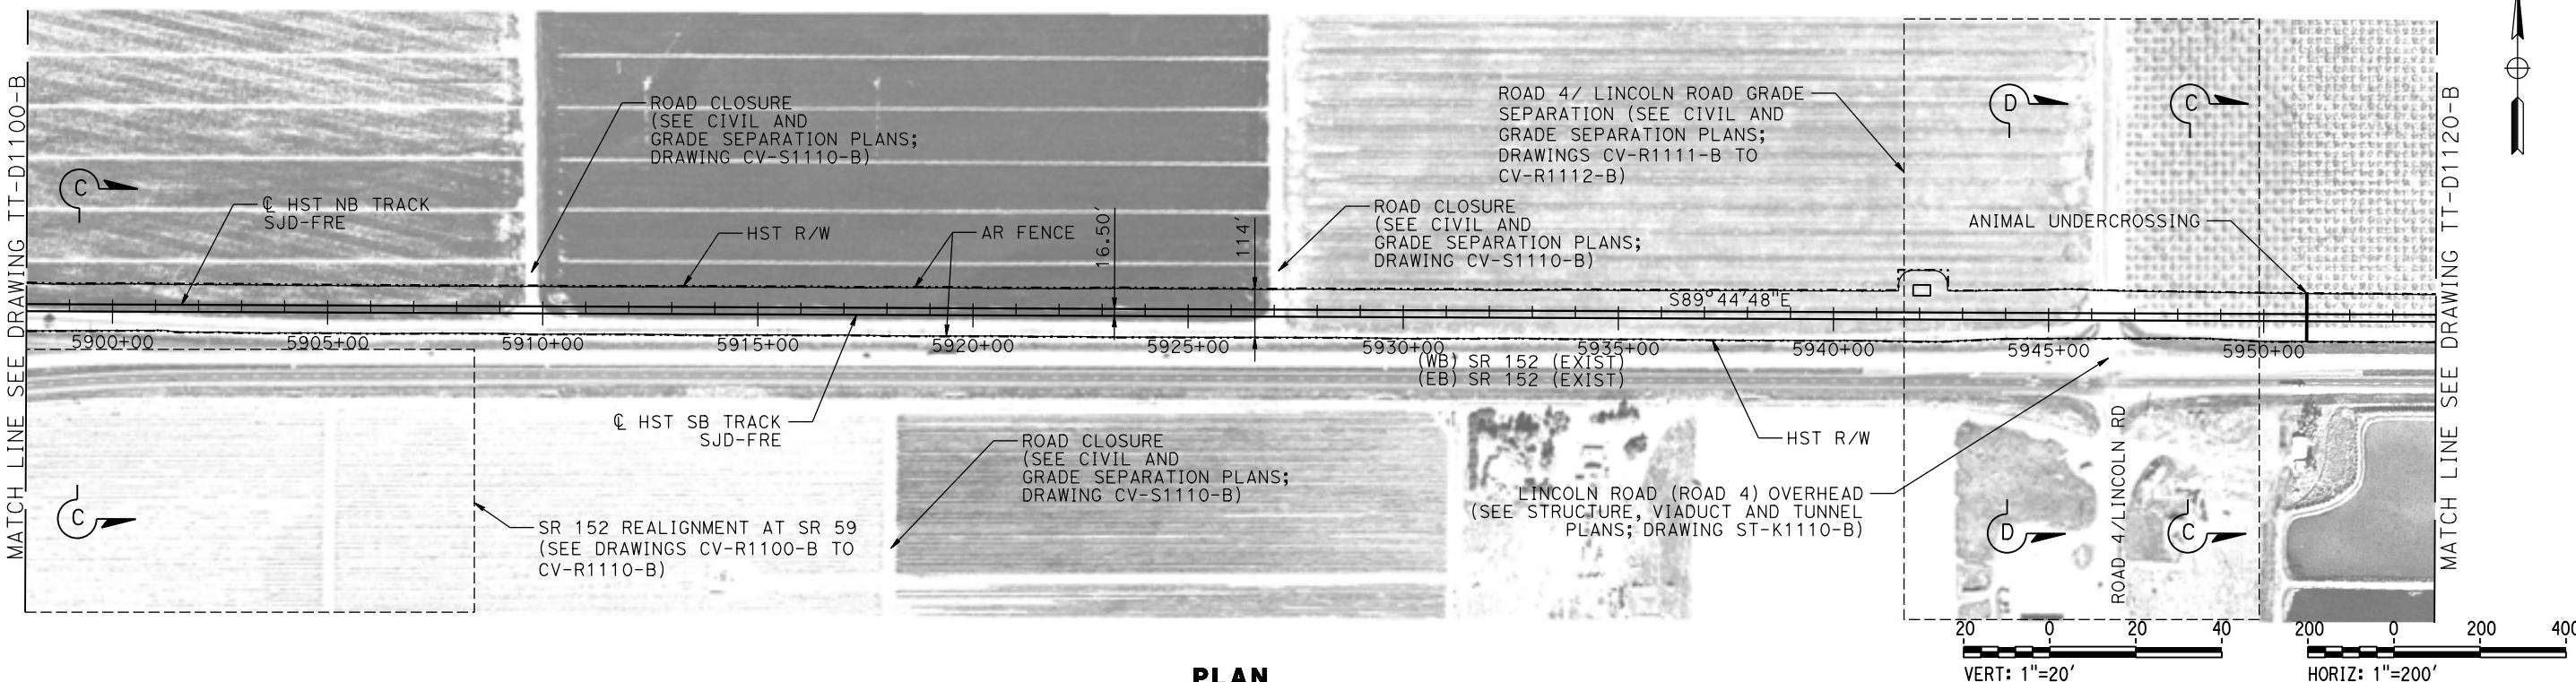


PLAN

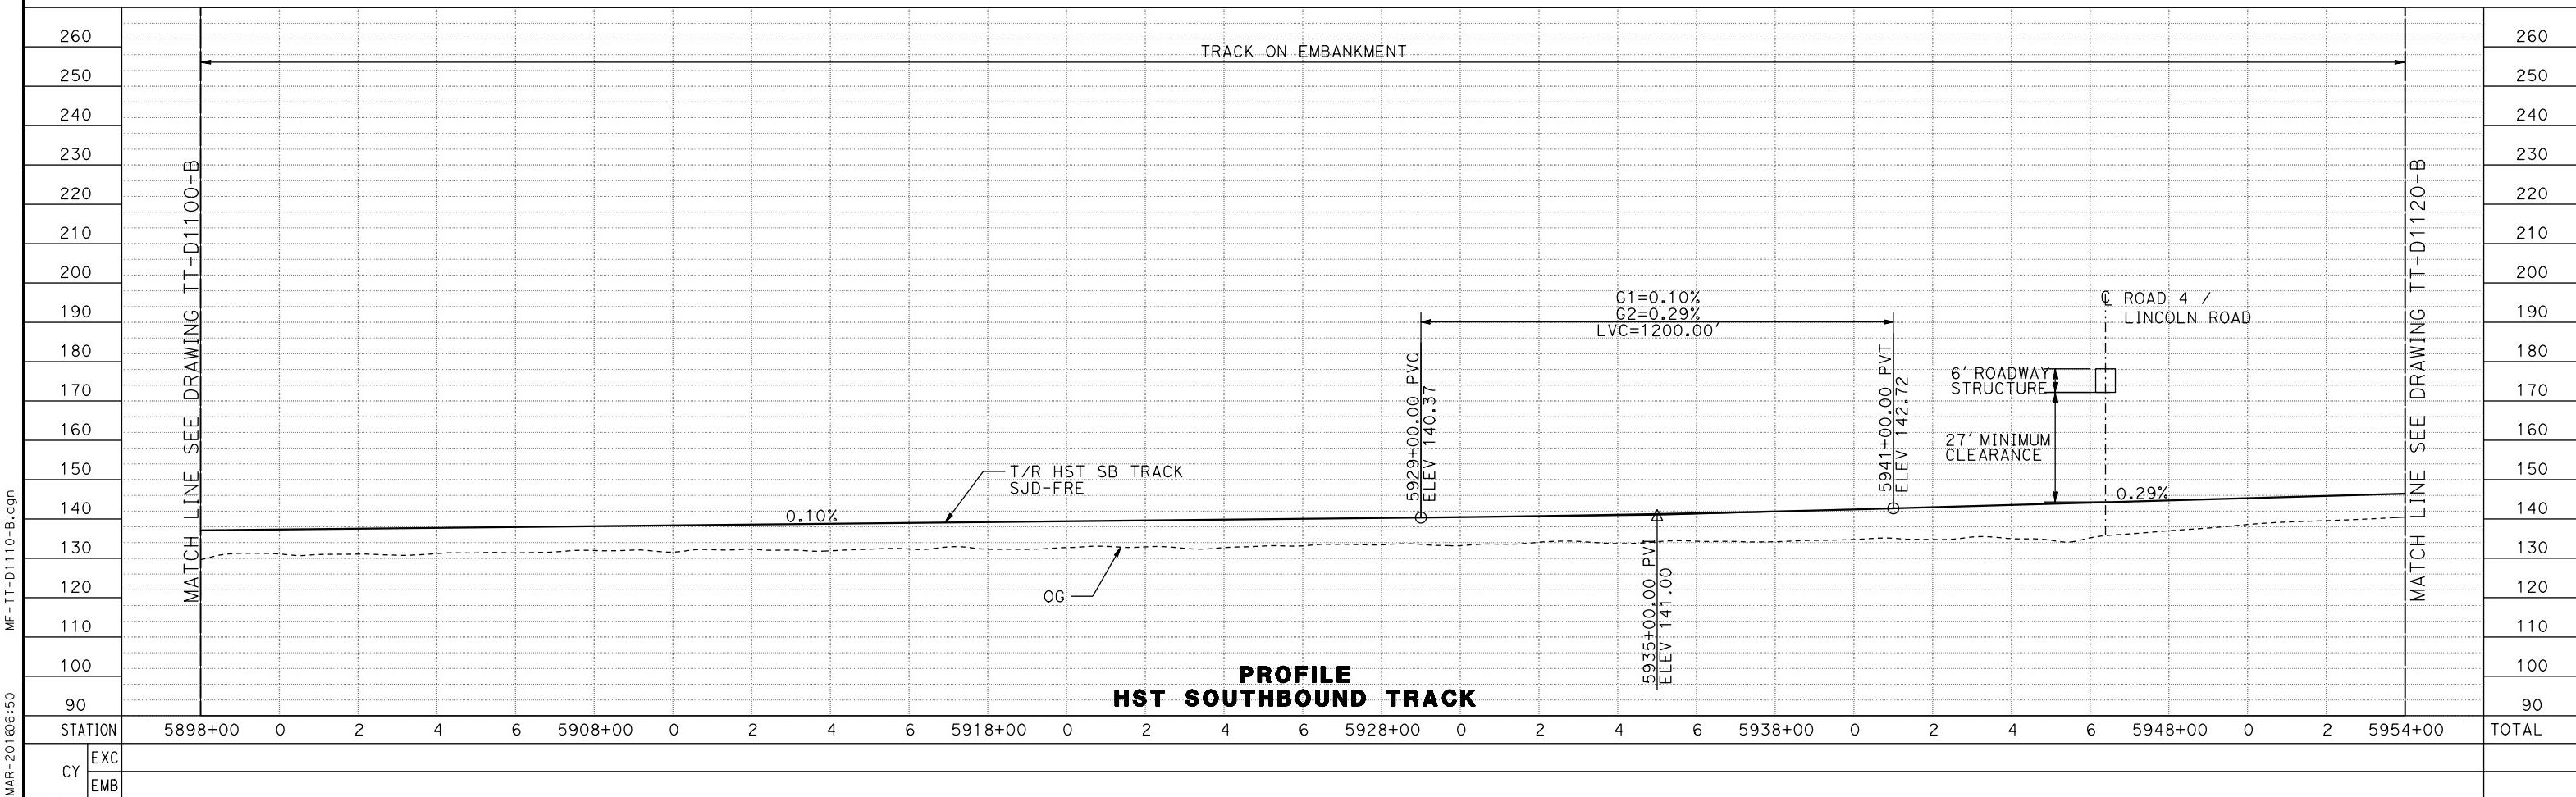



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p0042226					DRAWN BY S. WILSON				CENTRAL VALLEY WYE	DRAWING NO. TT-D1110-B	
					CHECKED BY N. OUM				SR 152 (NORTH) TO ROAD 19 WYE ALTERNATIVE	SCALE AS SHOWN	
					IN CHARGE C. LEMLEY				TRACK PLAN AND PROFILE	SHEET NO. 00	
					DATE 03/18/2016	NOT FOR CONSTRUCTION			SJD-FRE STA 5898+00 TO 5954+00		
REV	DATE	BY	CHK	APP	DESCRIPTION						

MADERA COUNTY

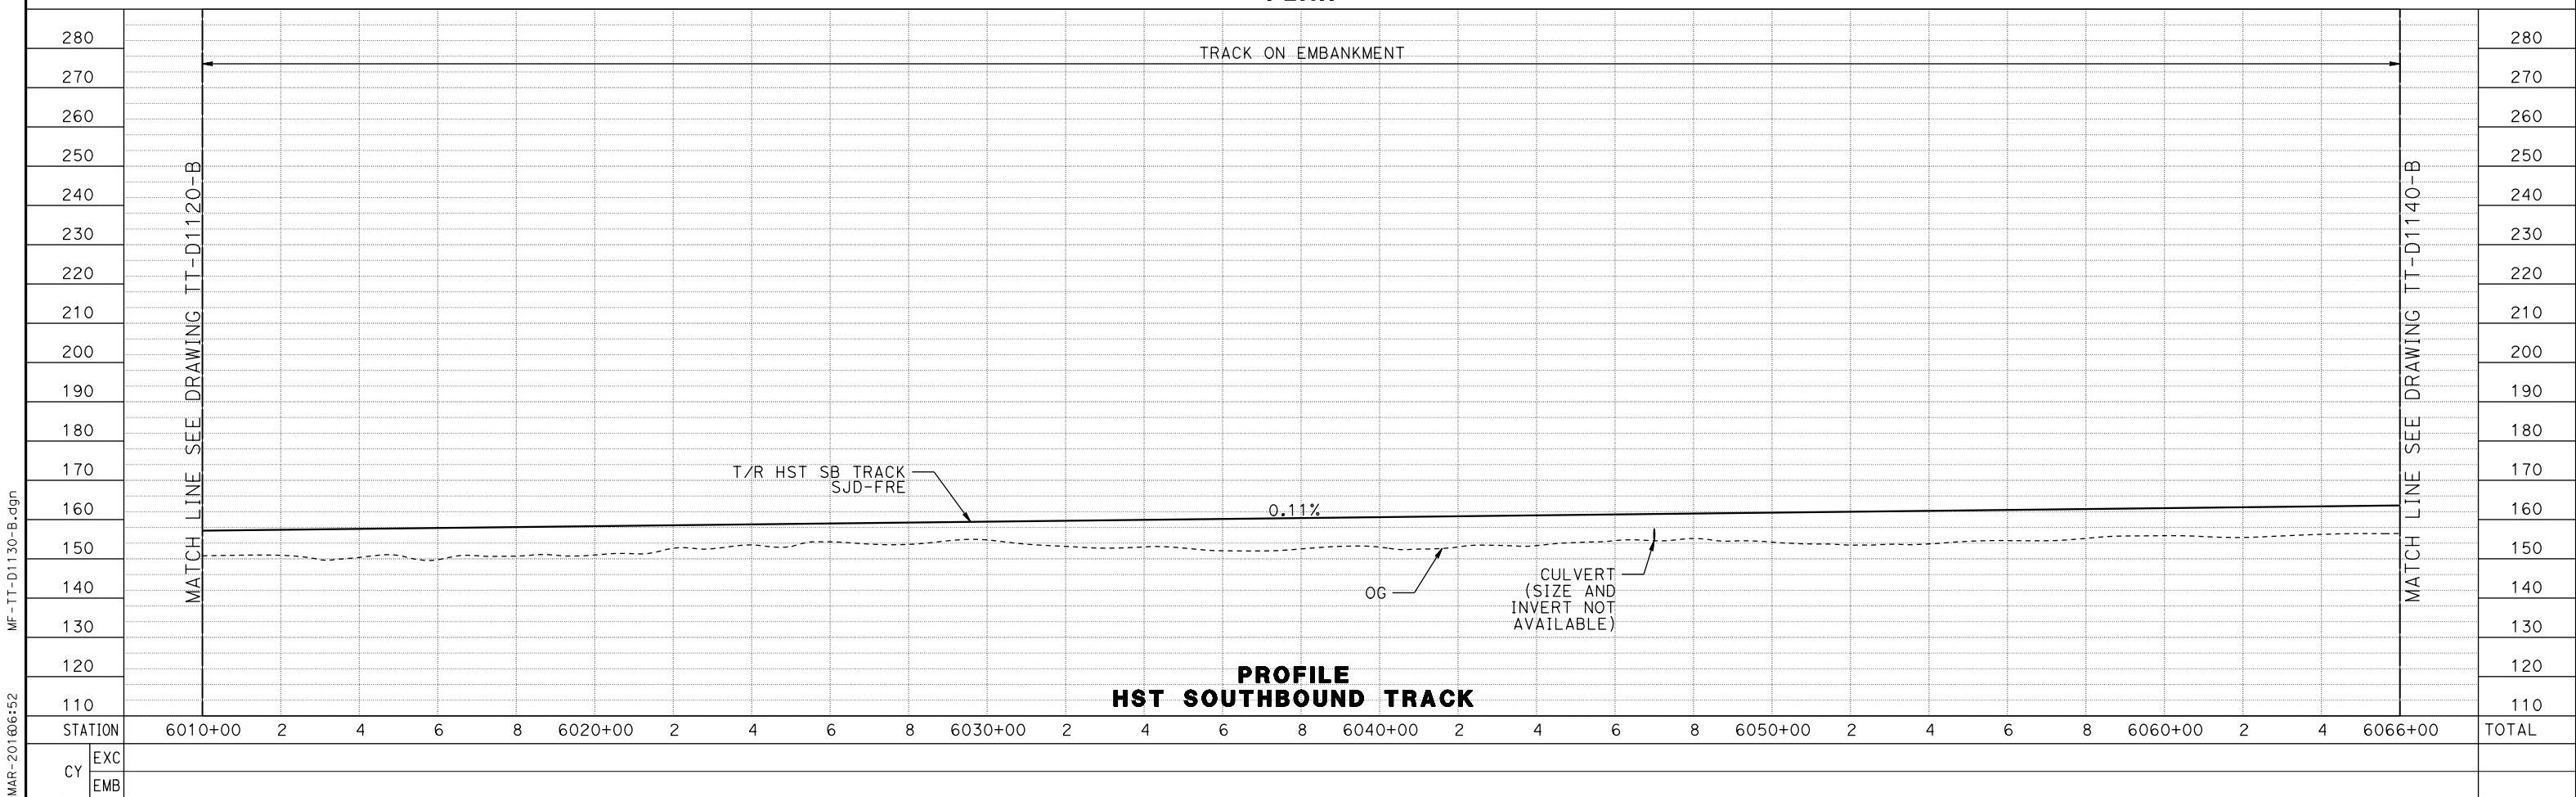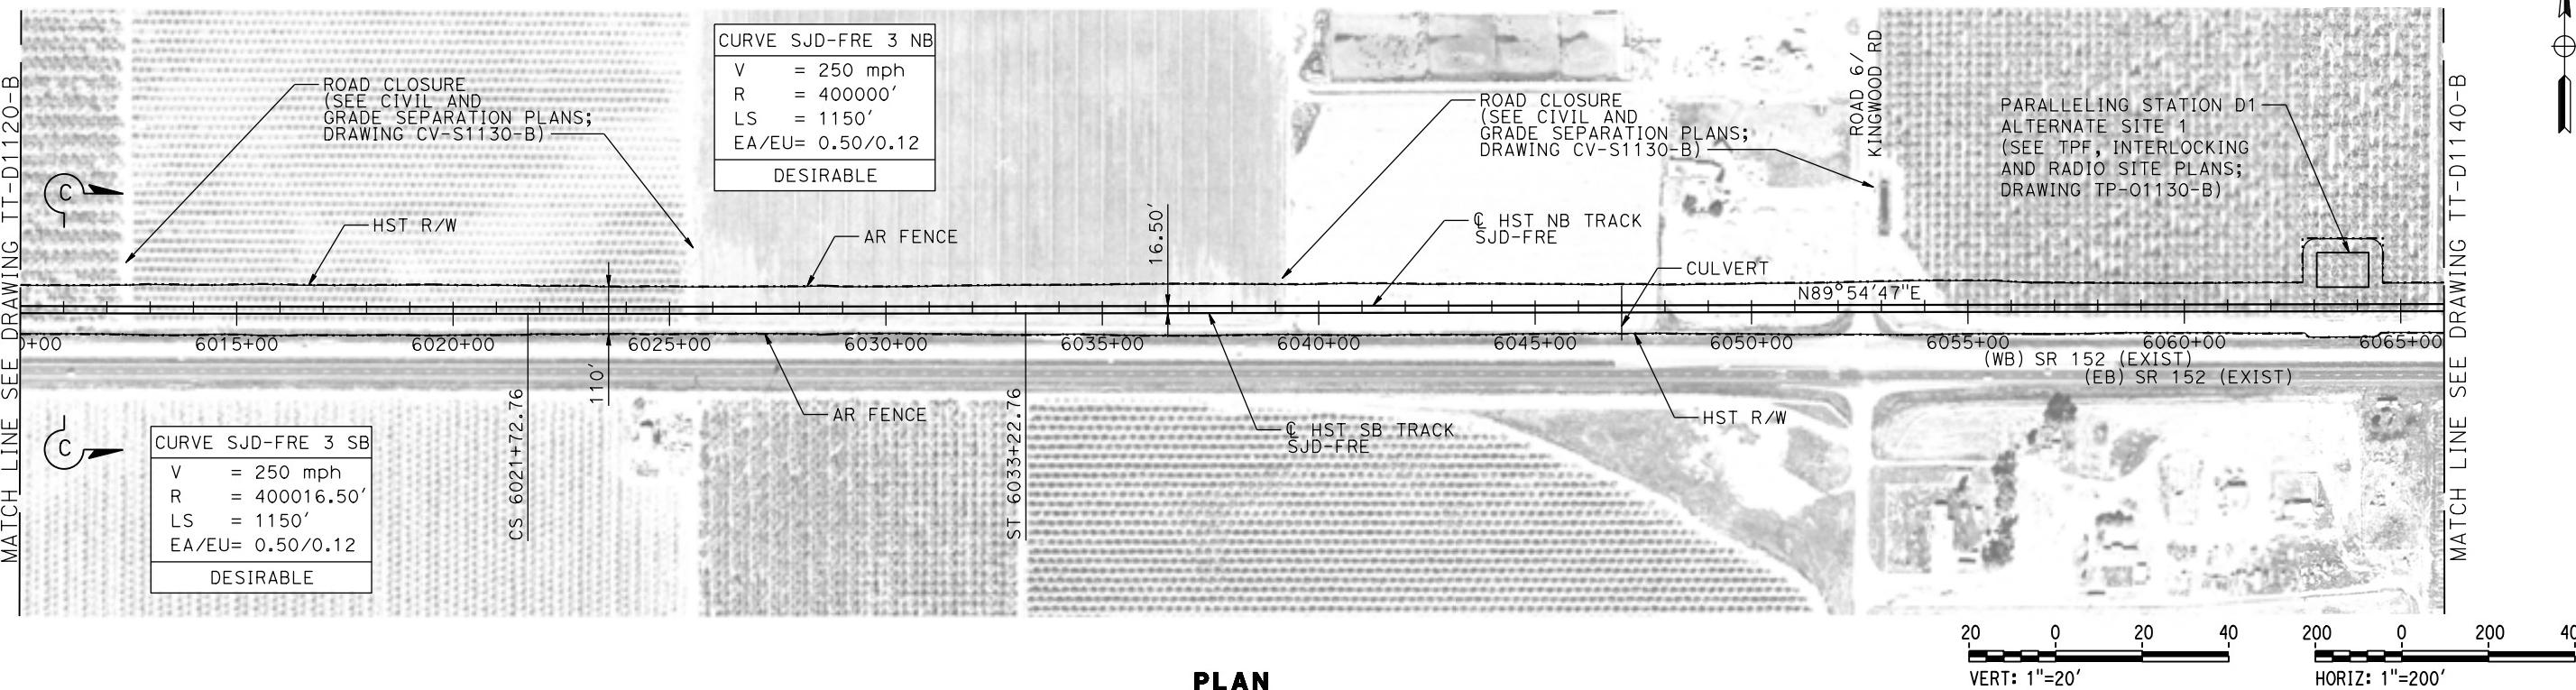



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p0042226					DRAWN BY S. WILSON				CENTRAL VALLEY WYE SR 152 (NORTH) TO ROAD 19 WYE ALTERNATIVE TRACK PLAN AND PROFILE SJD-FRE STA 6010+00 TO 6066+00	DRAWING NO. TT-D1130-B
					CHECKED BY N. OUM					SCALE AS SHOWN
					IN CHARGE C. LEMLEY	NOT FOR CONSTRUCTION				SHEET NO. _____
					DATE 03/18/2016					
REV	DATE	BY	CHK	APP	DESCRIPTION					

MADERA COUNTY

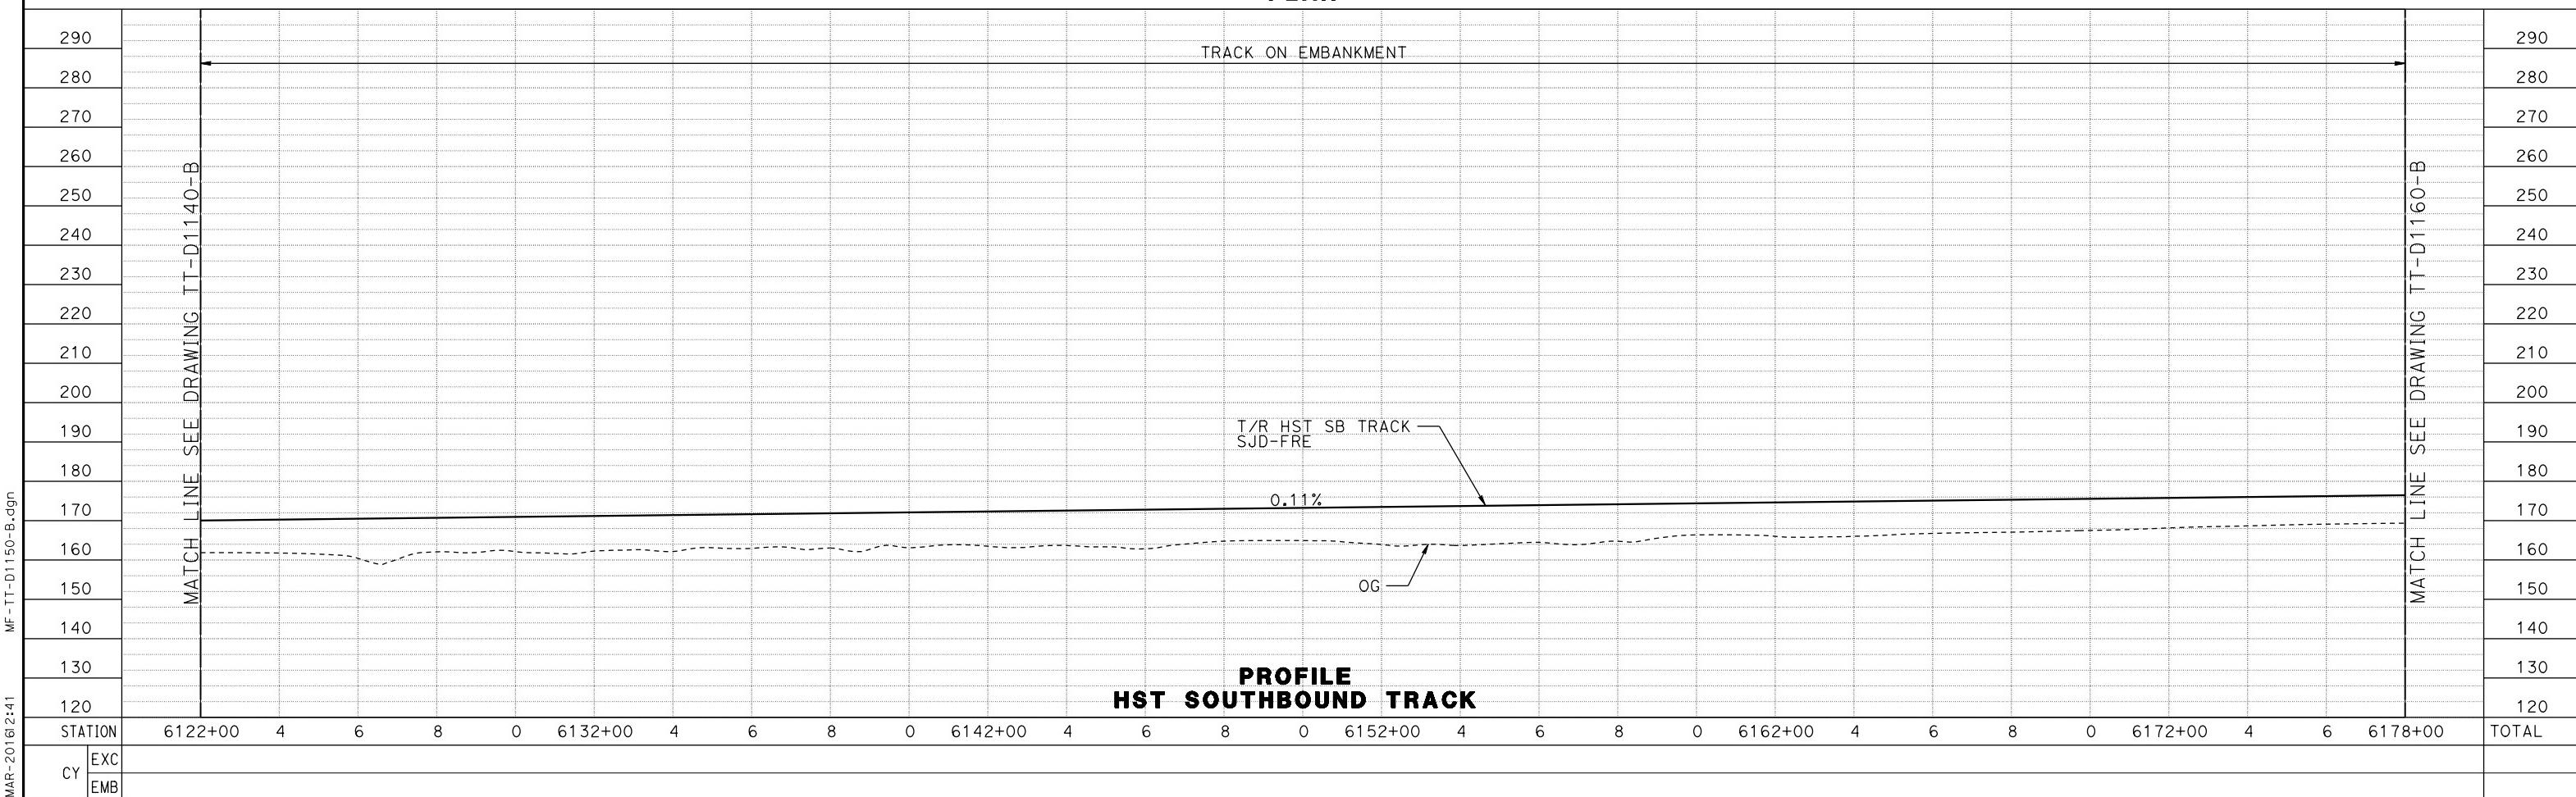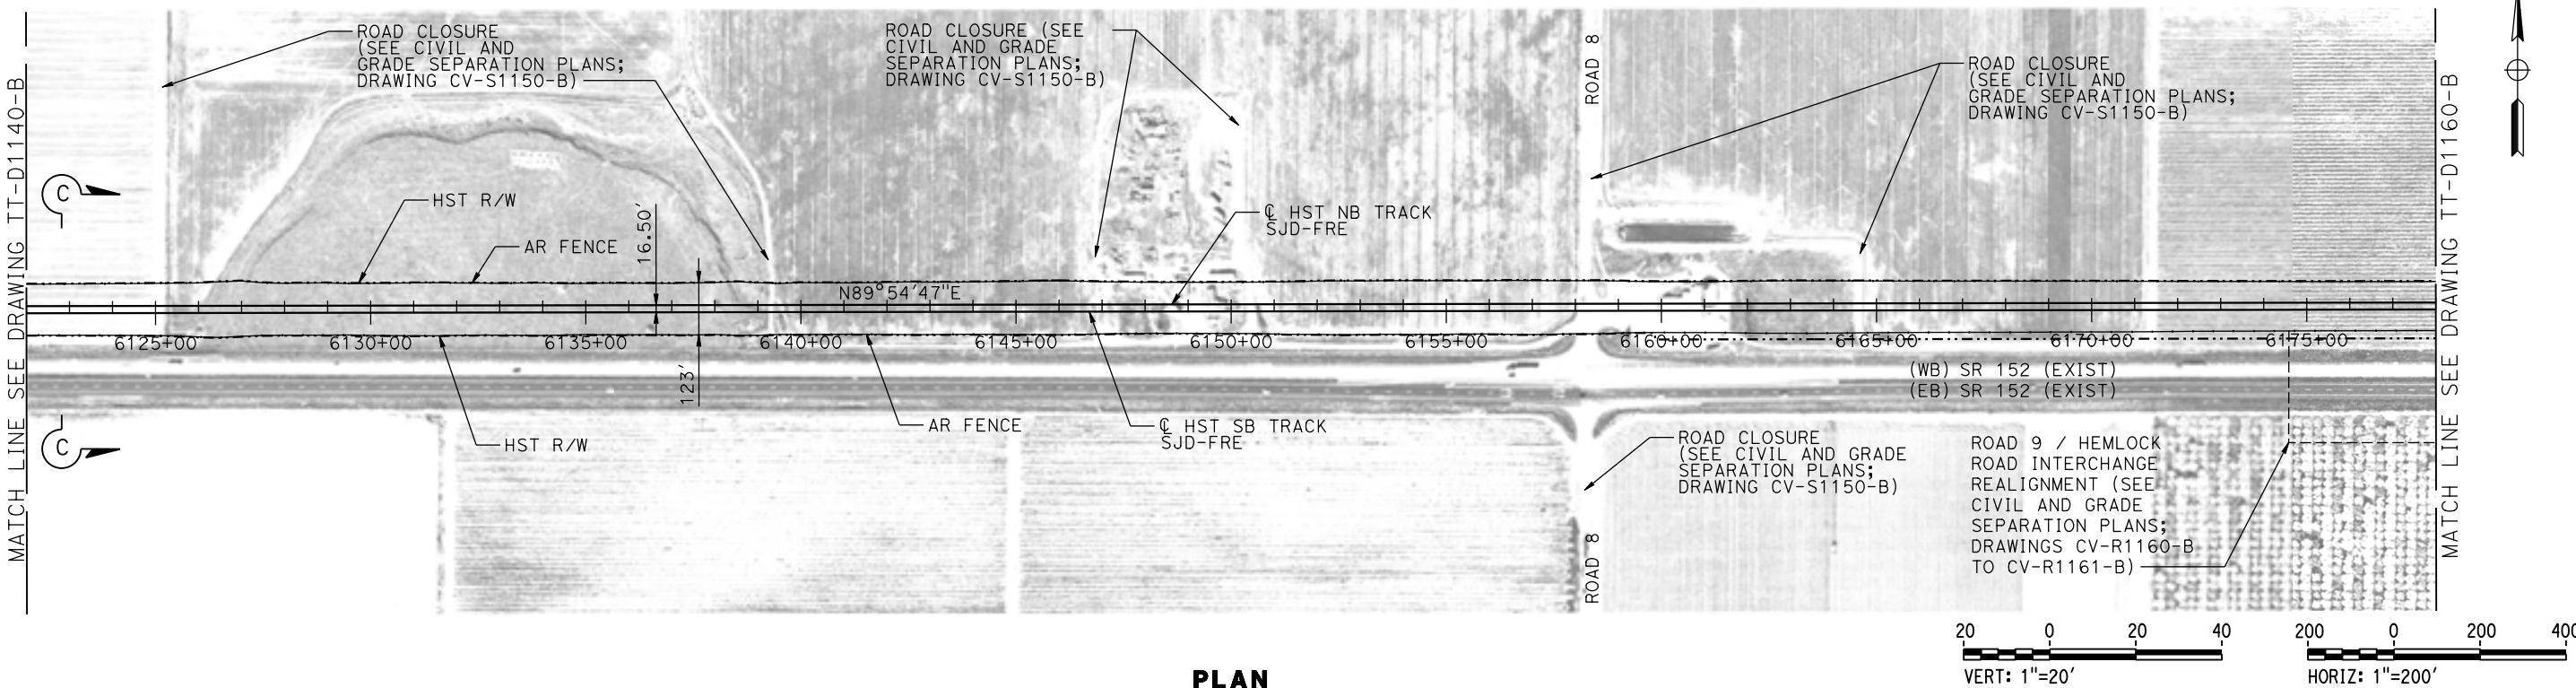


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					DRAWN BY S. WILSON				CENTRAL VALLEY WYE SR 152 (NORTH) TO ROAD 19 WYE ALTERNATIVE TRACK PLAN AND PROFILE SJD-FRE STA 6122+00 TO 6178+00	DRAWING NO. TT-D1150-B
					CHECKED BY N. OUM	NOT FOR CONSTRUCTION				SCALE AS SHOWN
					IN CHARGE C. LEMLEY					SHEET NO. _____
					DATE 03/18/2016					
REV	DATE	BY	CHK	APP	DESCRIPTION					

MADERA COUNTY

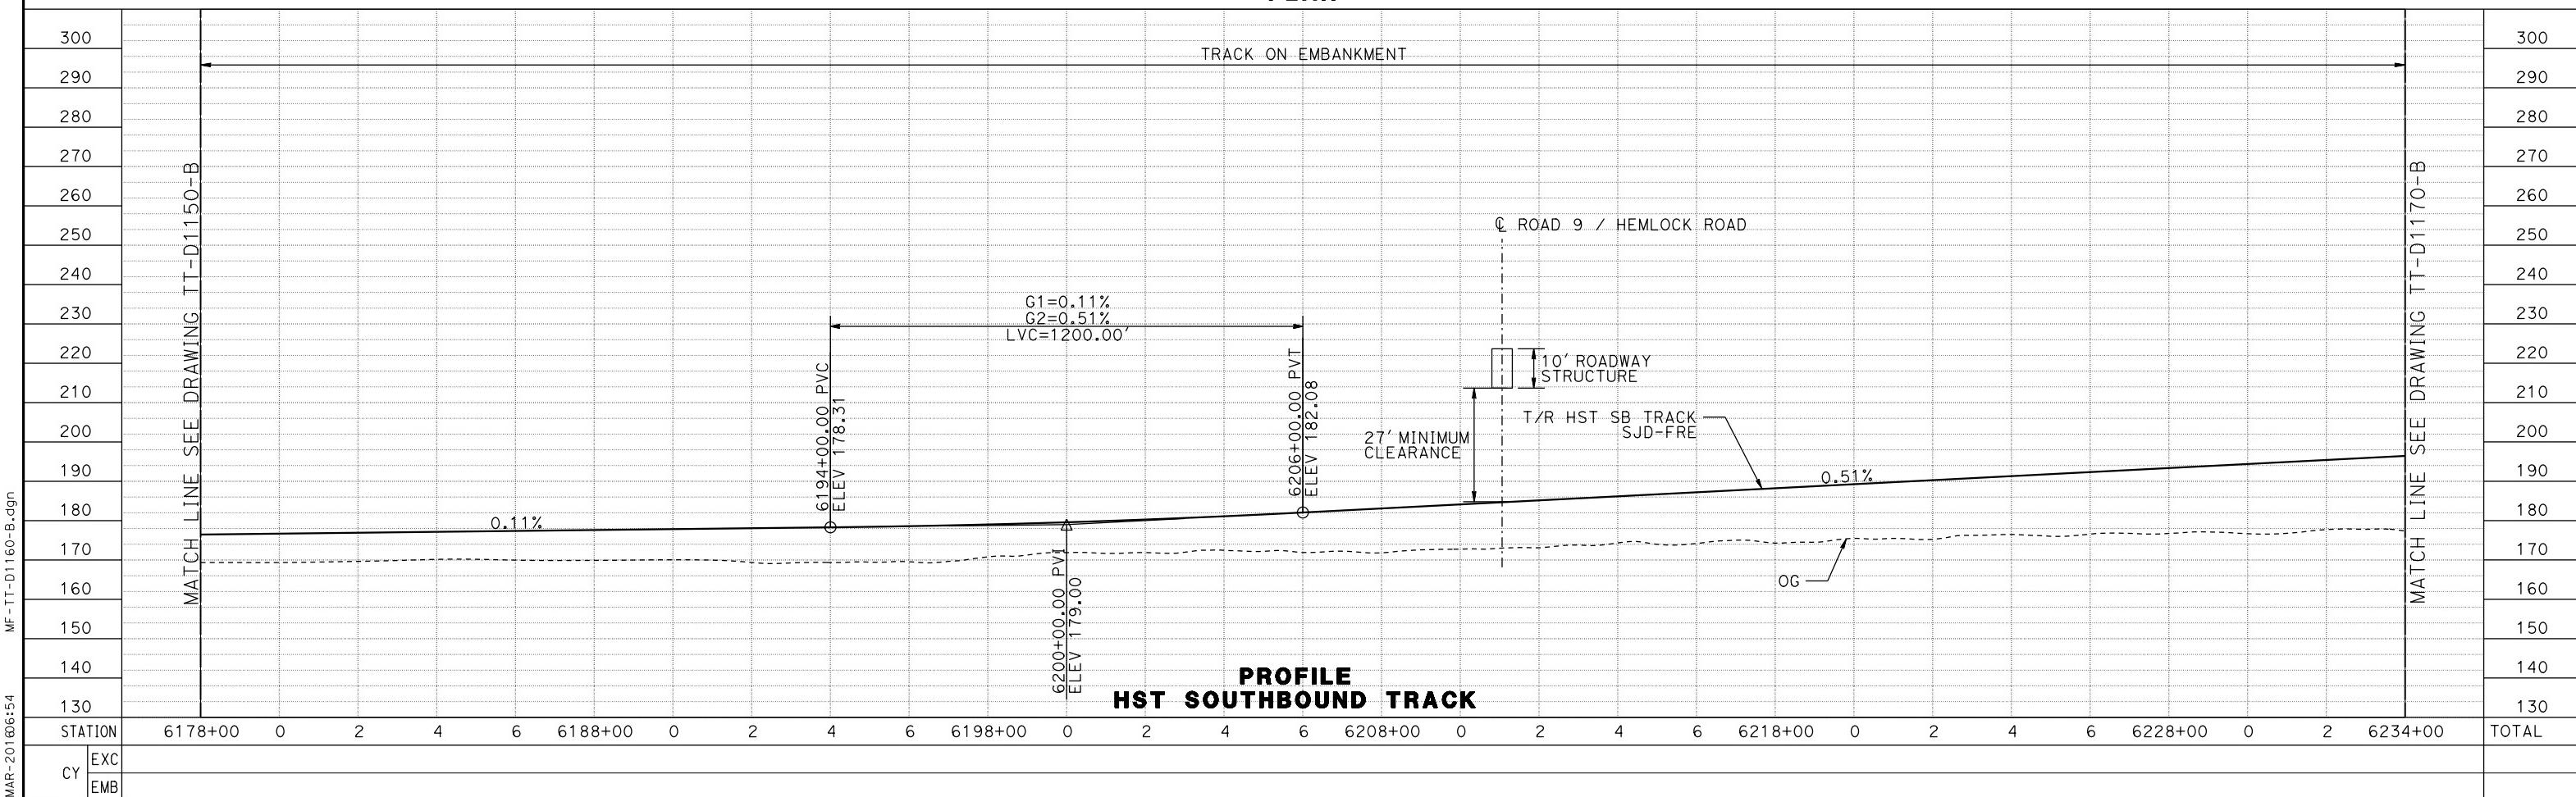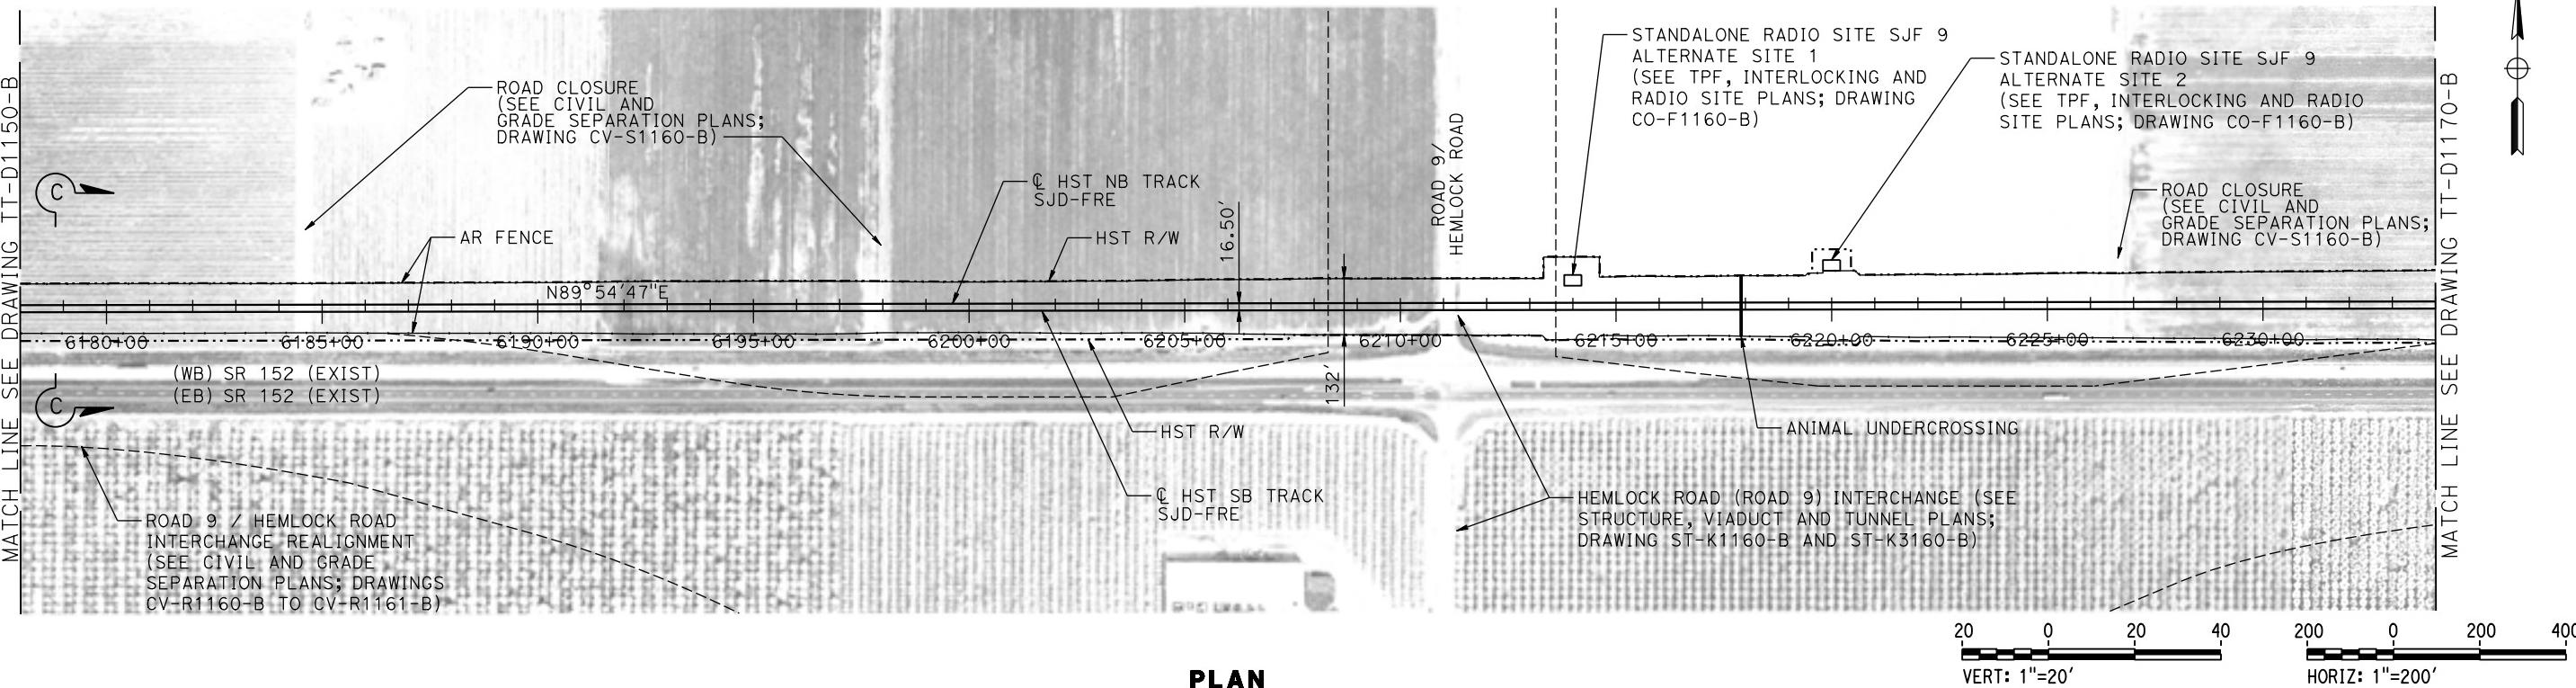


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p0042226					DRAWN BY S. WILSON	NOT FOR CONSTRUCTION			CENTRAL VALLEY WYE SR 152 (NORTH) TO ROAD 19 WYE ALTERNATIVE TRACK PLAN AND PROFILE SJD-FRE STA 6178+00 TO 6234+00	DRAWING NO. TT-D1160-B	
					CHECKED BY N. OUM					SCALE AS SHOWN	
					IN CHARGE C. LEMLEY					SHEET NO. 000	
					DATE 03/18/2016						
REV	DATE	BY	CHK	APP	DESCRIPTION						

MADERA COUNTY

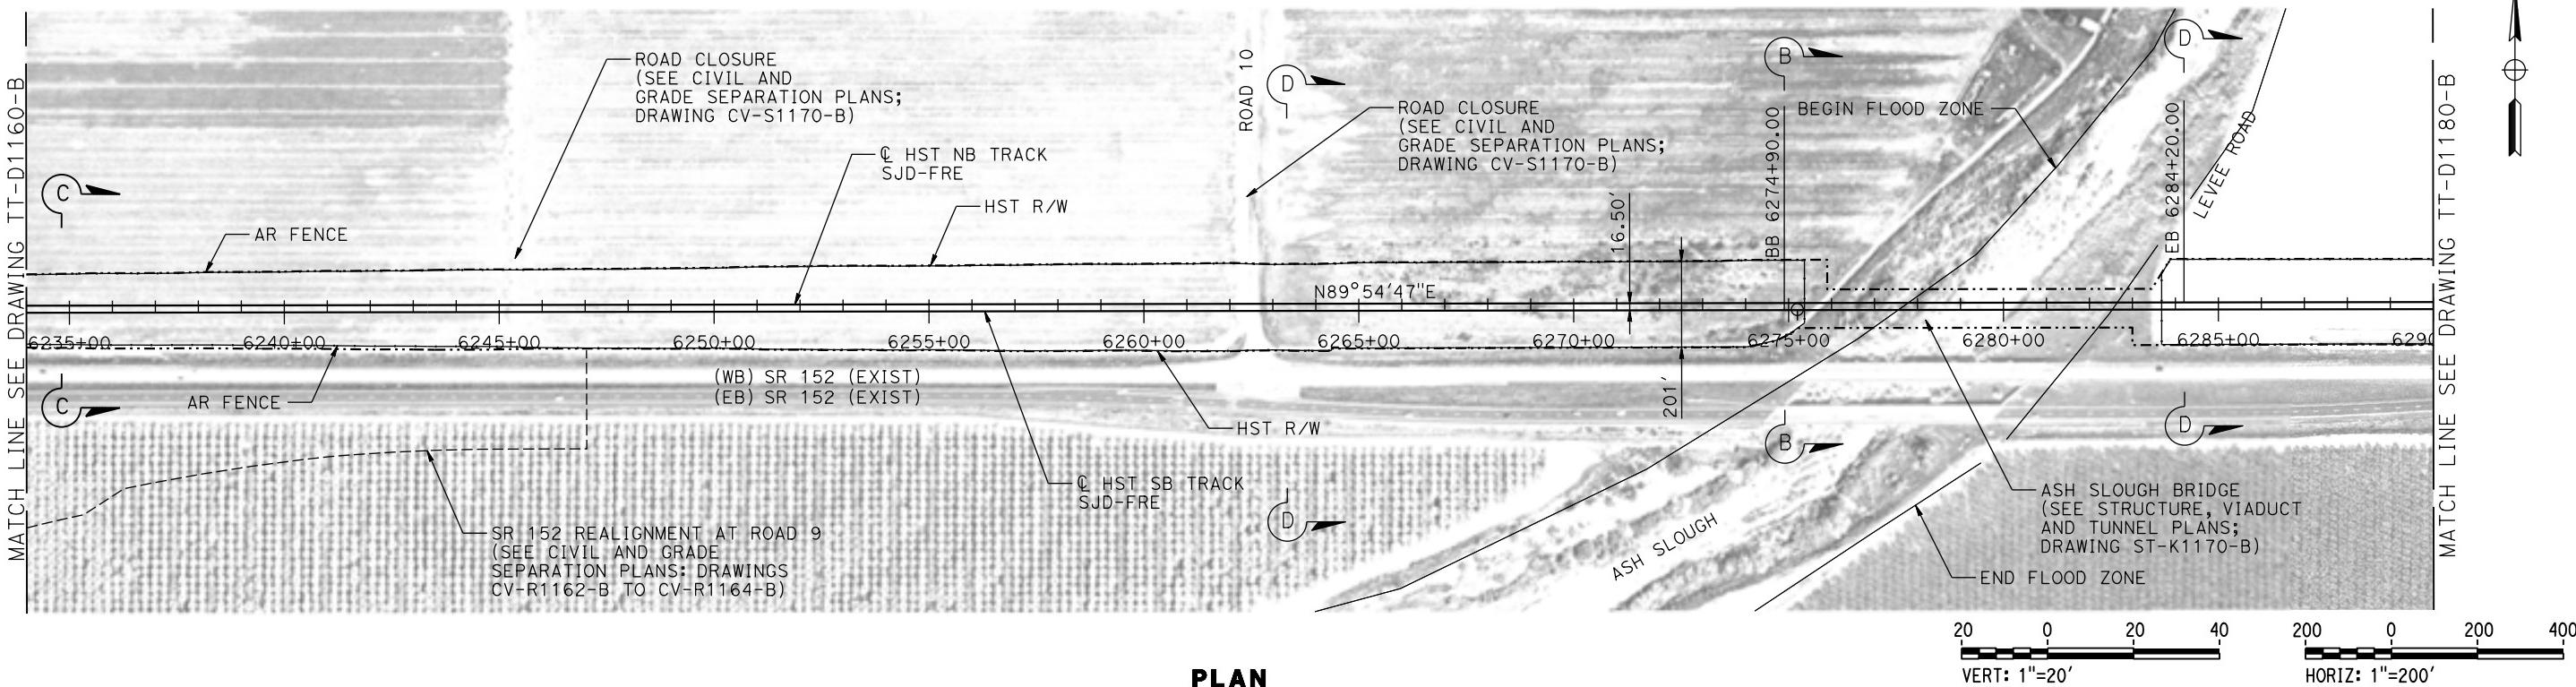

PLAN

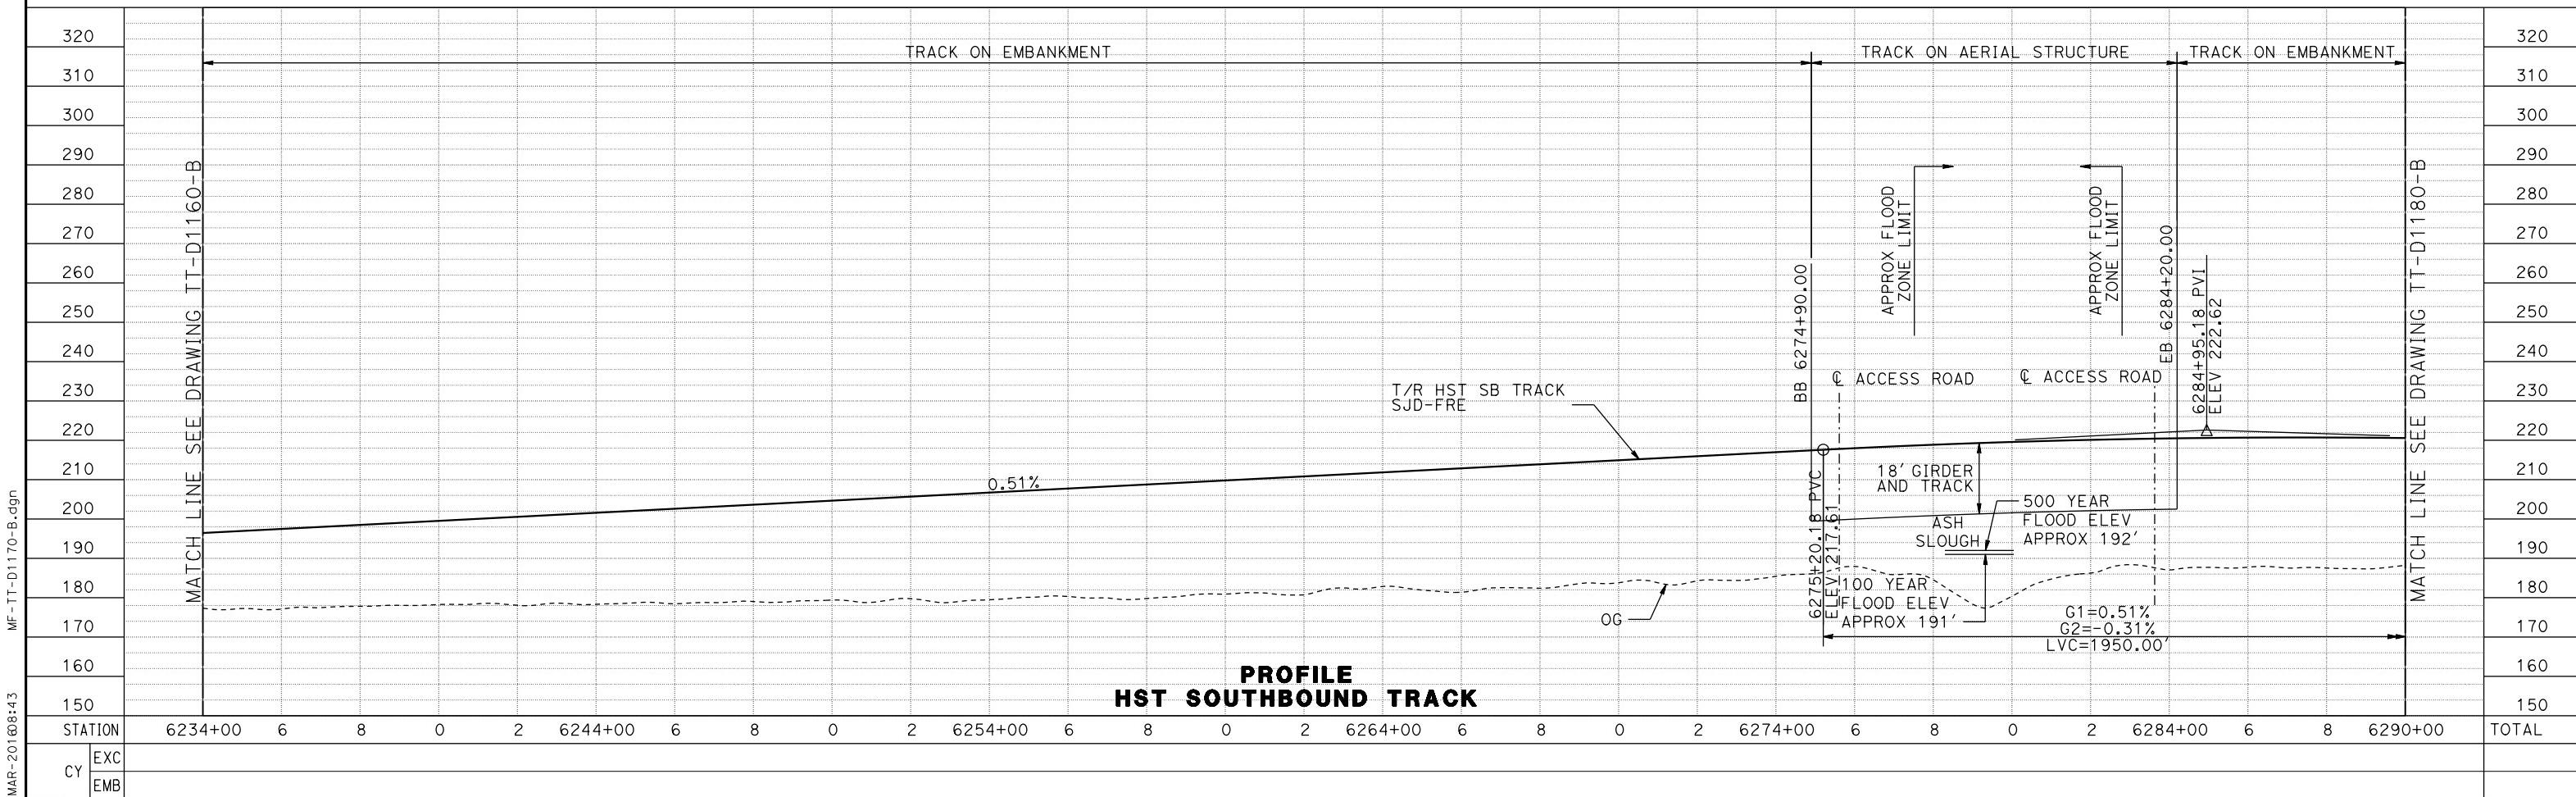


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CHECKED BY N. OUM		SCALE AS SHOWN						
IN CHARGE C. LEMLEY		SHEET NO.						
DATE 03/18/2016								
REV	DATE	BY	CHK	APP	DESCRIPTION			




CALIFORNIA HIGH-SPEED TRAIN PROJECT MERCED TO FRESNO SECTION

CENTRAL VALLEY WYE
SR 152 (NORTH) TO ROAD 19 WYE ALTERNATIVE
TRACK PLAN AND PROFILE
SJD-FRE STA 6234+00 TO 6290+00

MADERA COUNTY

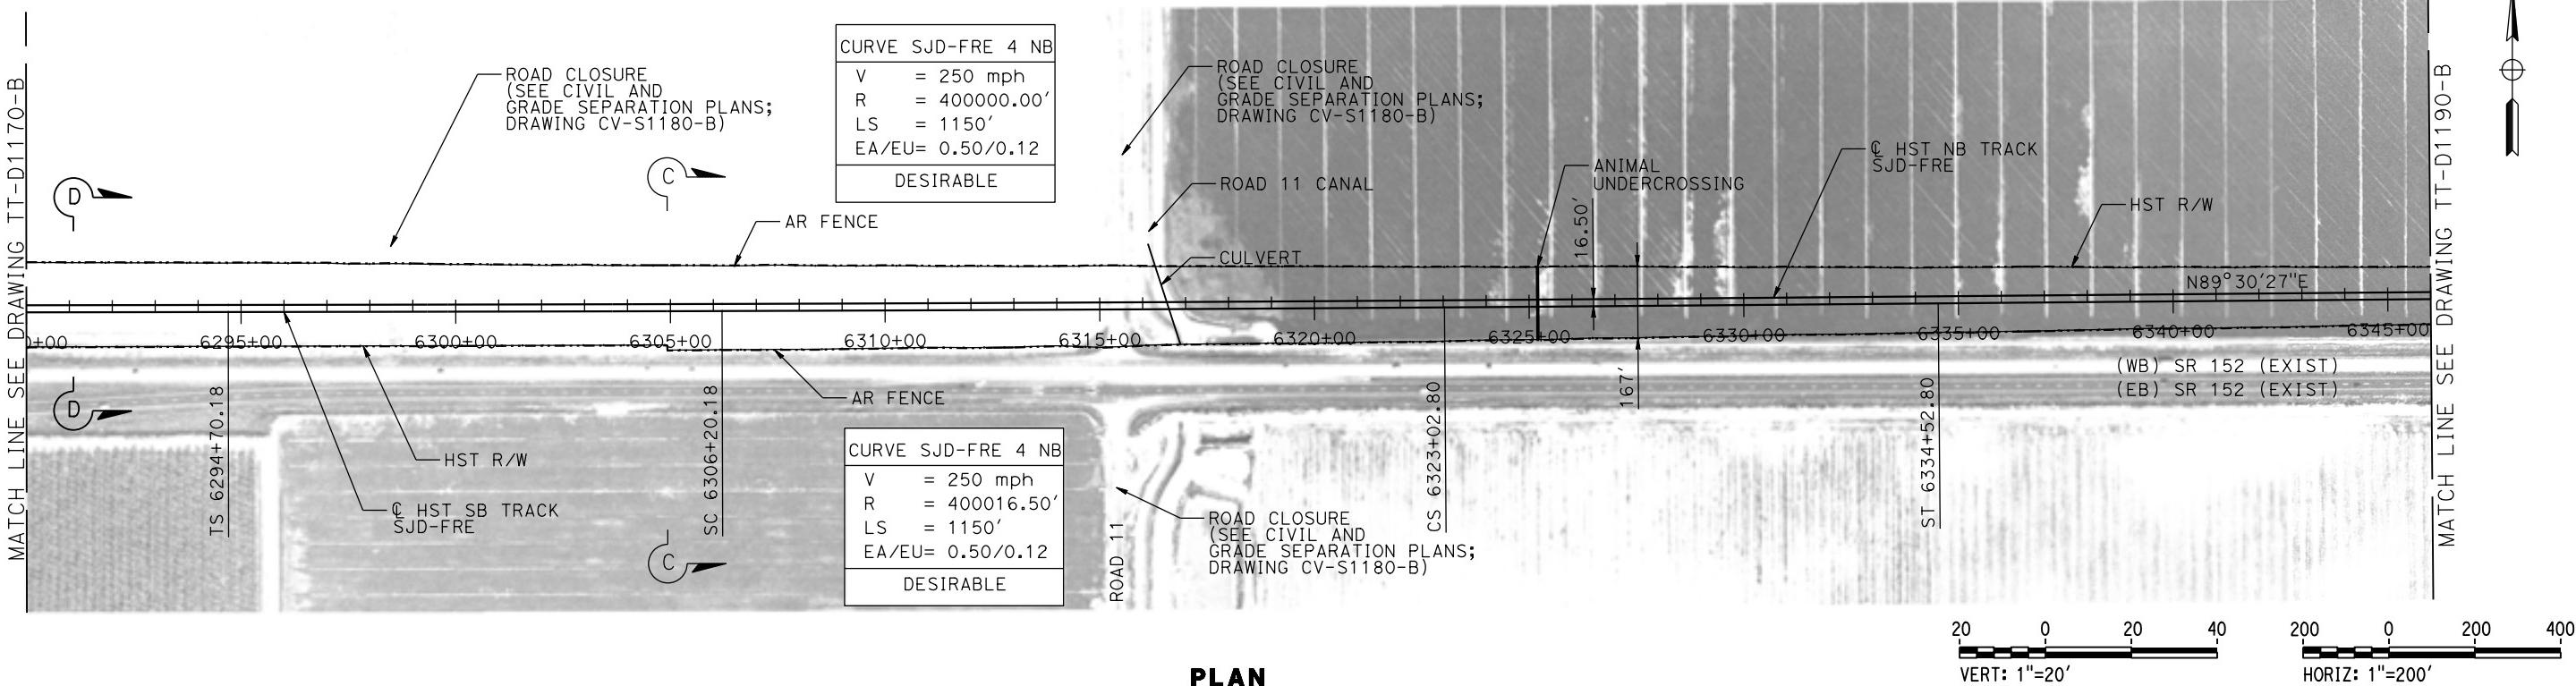


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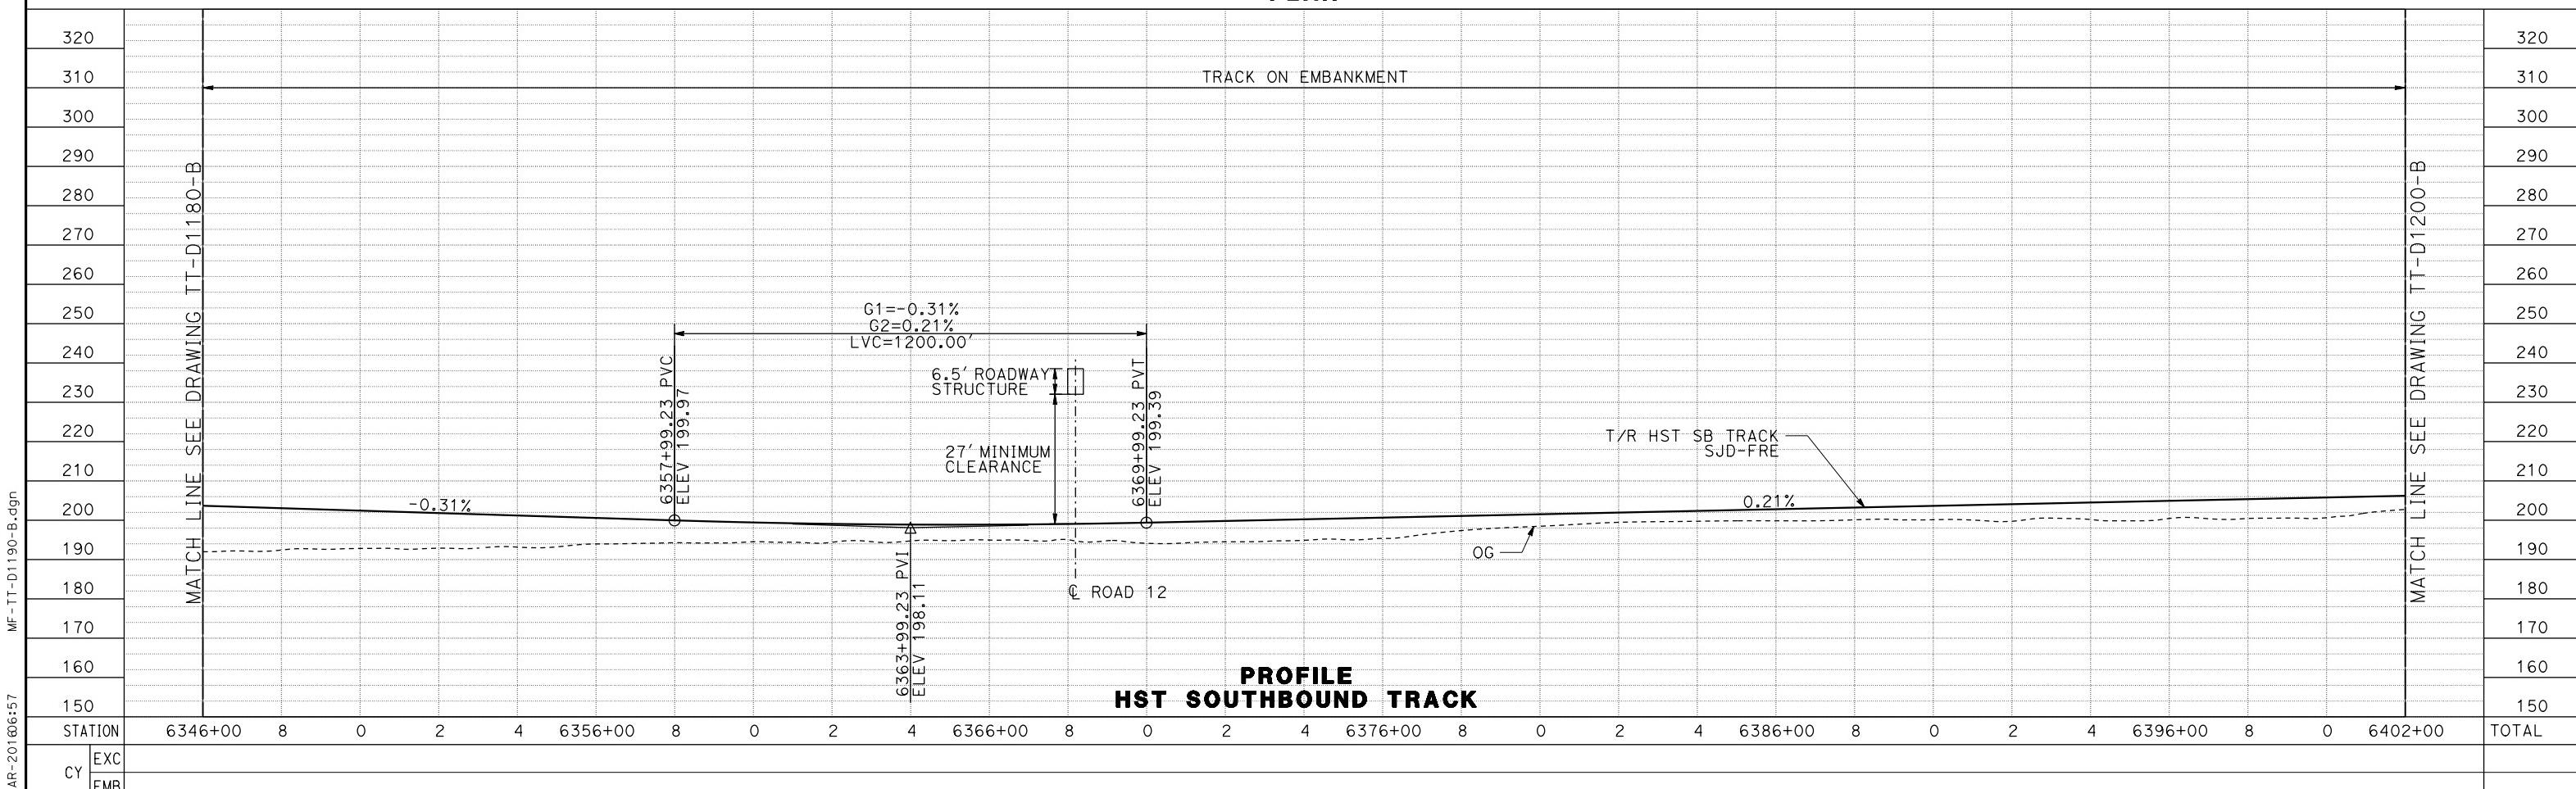

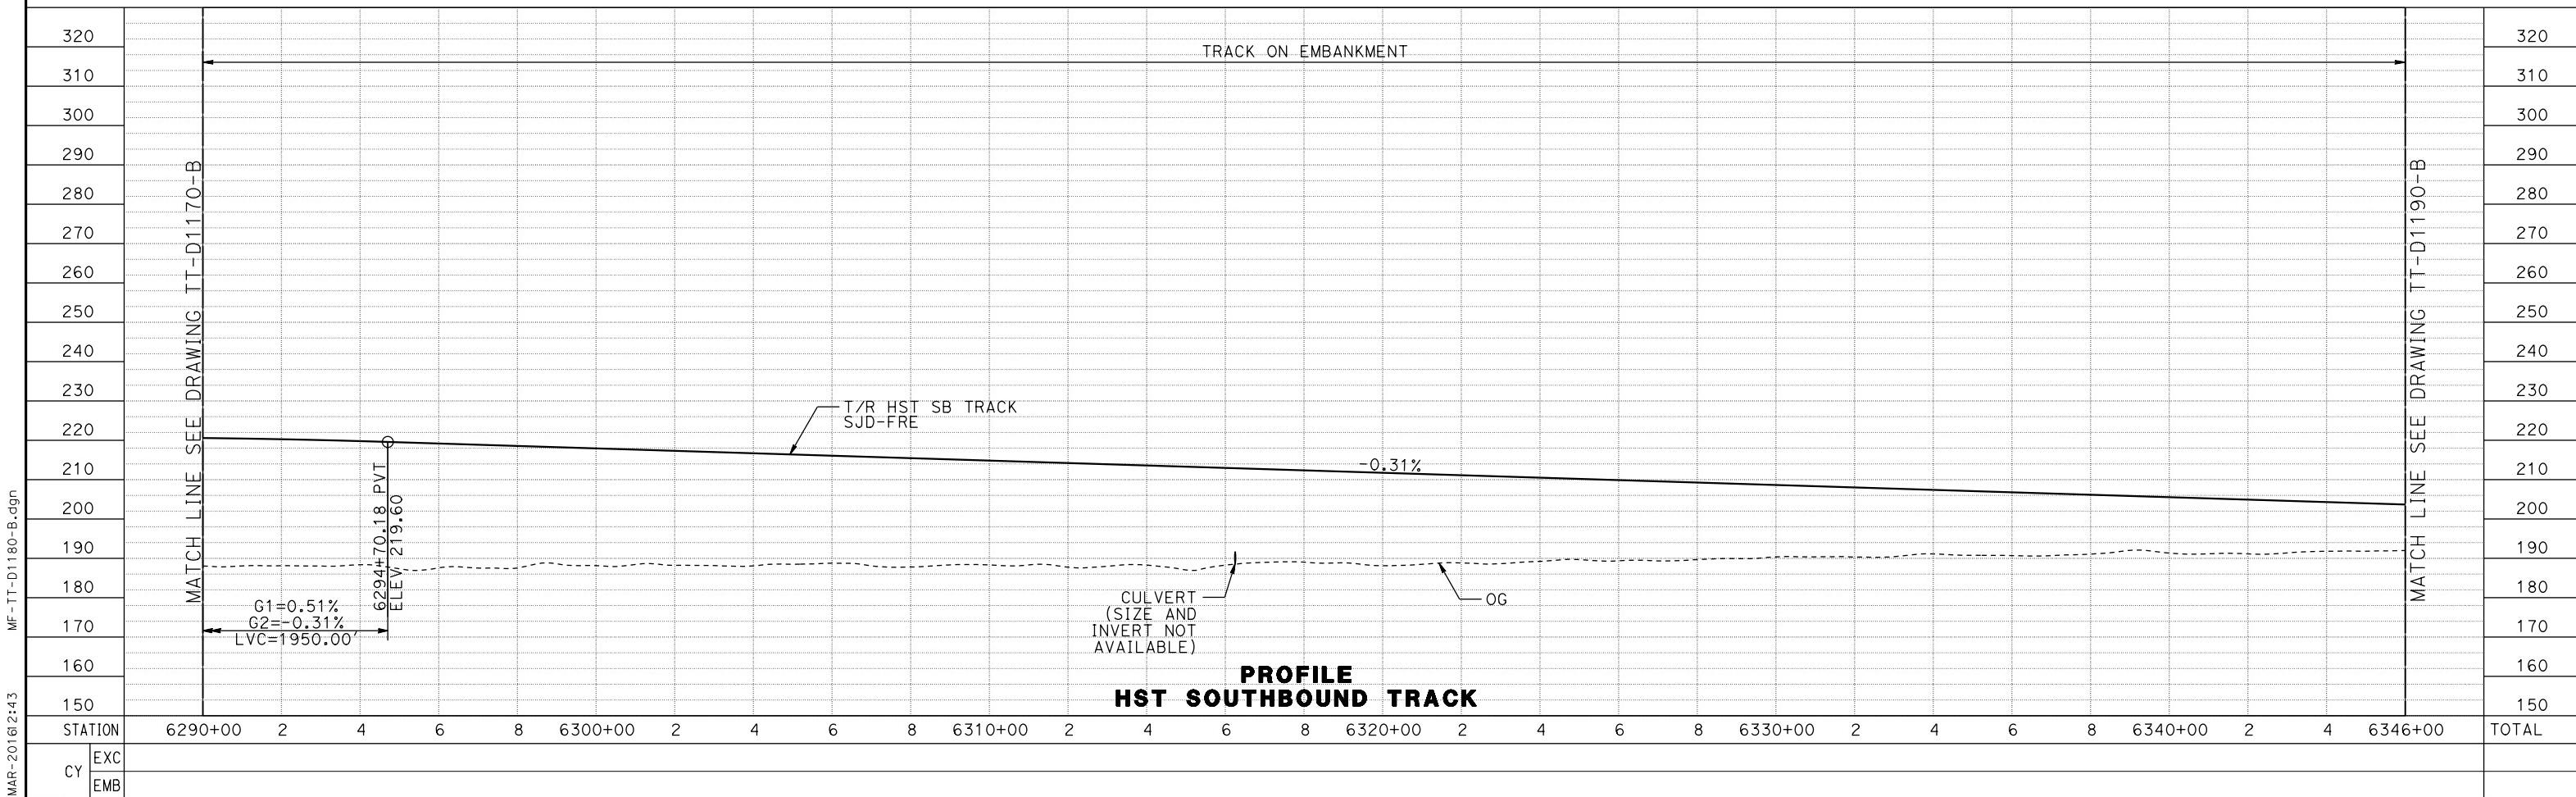
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p004226					DRAWN BY S. WILSON				CENTRAL VALLEY WYE SR 152 (NORTH) TO ROAD 19 WYE ALTERNATIVE TRACK PLAN AND PROFILE SJD-FRE STA 6290+00 TO 6346+00	DRAWING NO. TT-D1180-B	
					CHECKED BY N. OUM					SCALE AS SHOWN	
					IN CHARGE C. LEMLEY					SHEET NO. _____	
					DATE 03/18/2016	NOT FOR CONSTRUCTION					
REV	DATE	BY	CHK	APP	DESCRIPTION						

MADERA COUNTY

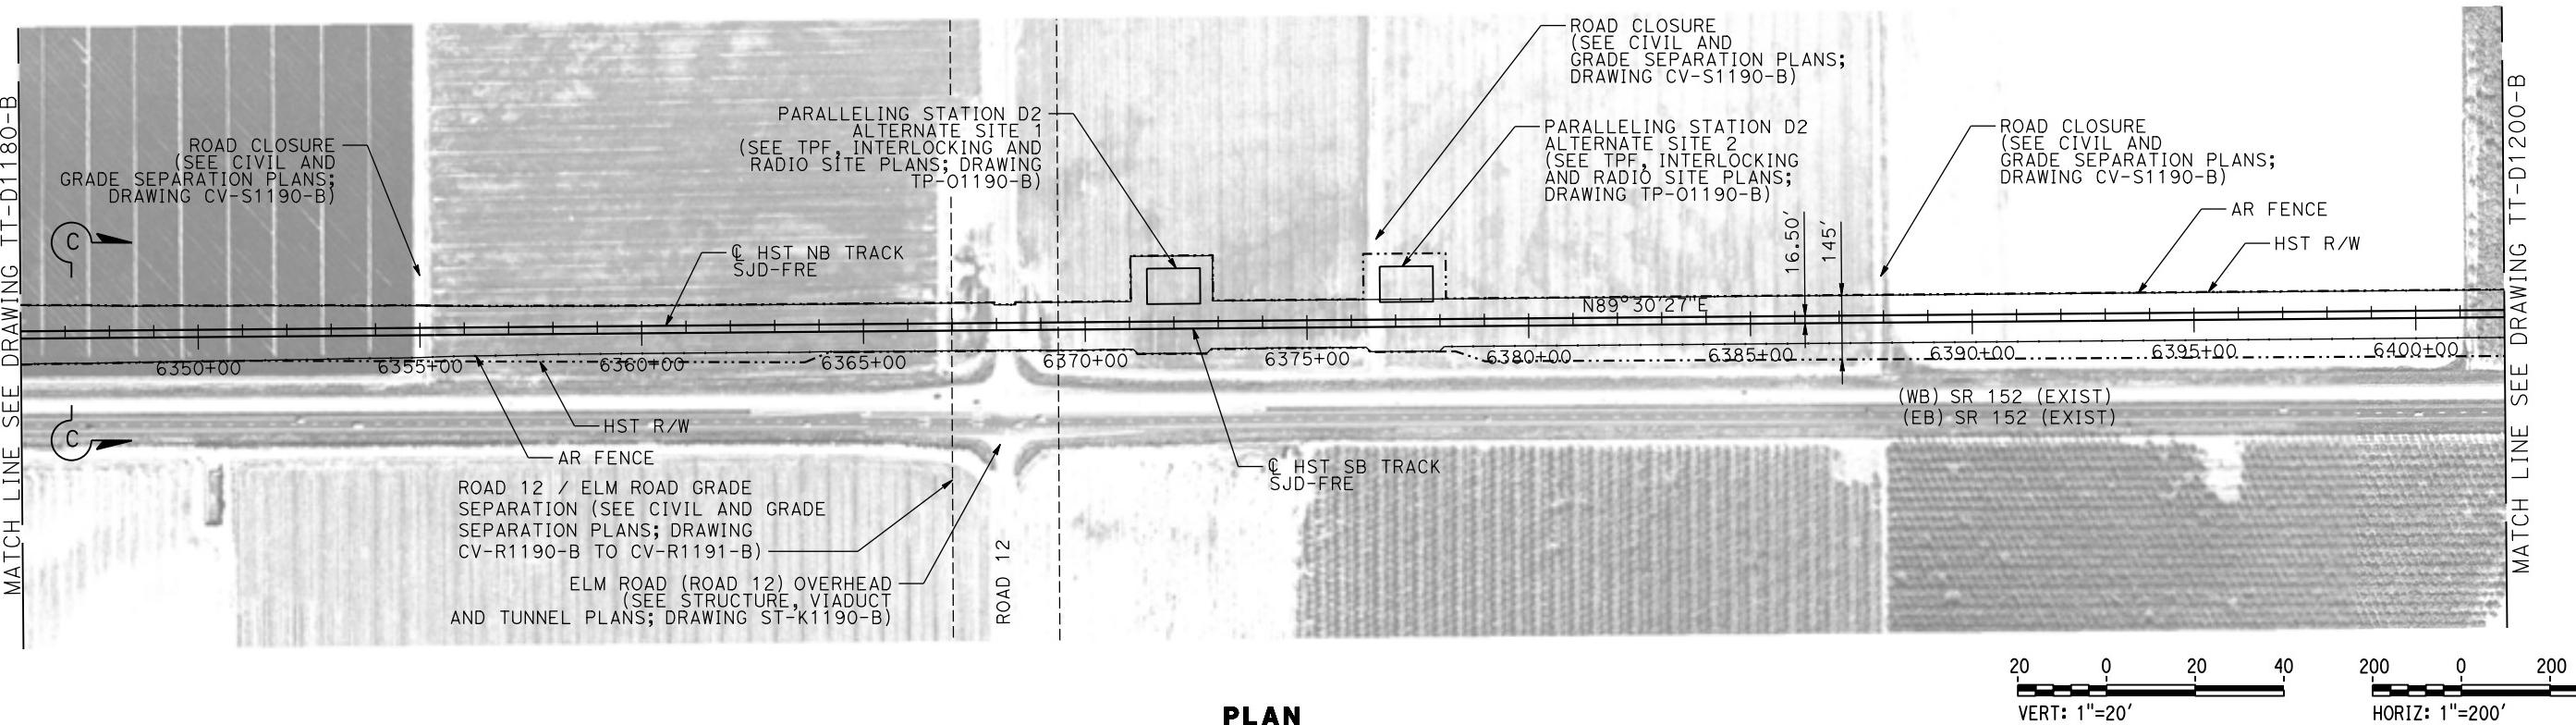


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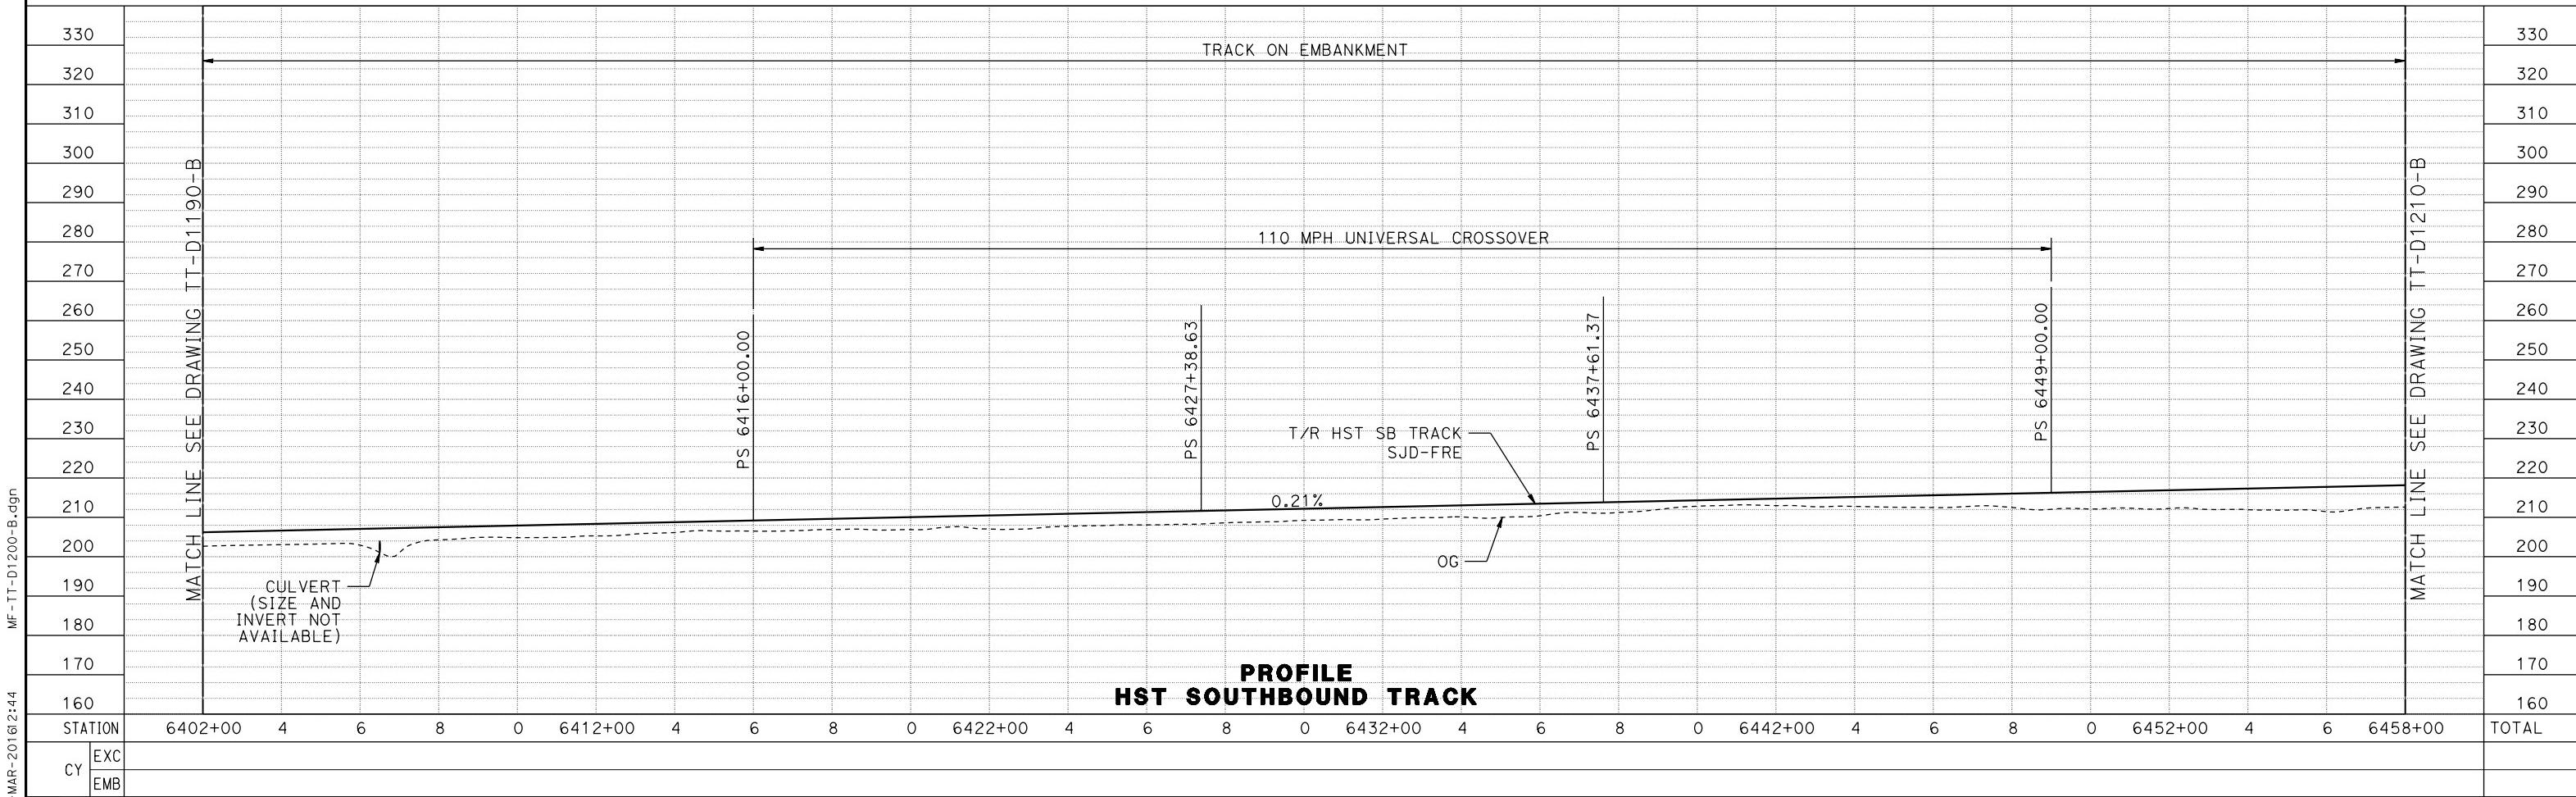


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p0042226					DRAWN BY S. WILSON				CENTRAL VALLEY WYE SR 152 (NORTH) TO ROAD 19 WYE ALTERNATIVE TRACK PLAN AND PROFILE SJD-FRE STA 6346+00 TO 6402+00	DRAWING NO. TT-D1190-B
					CHECKED BY N. OUM					SCALE AS SHOWN
					IN CHARGE C. LEMLEY	NOT FOR CONSTRUCTION				SHEET NO. _____
					DATE 03/18/2016					
REV	DATE	BY	CHK	APP	DESCRIPTION					

MADERA COUNTY

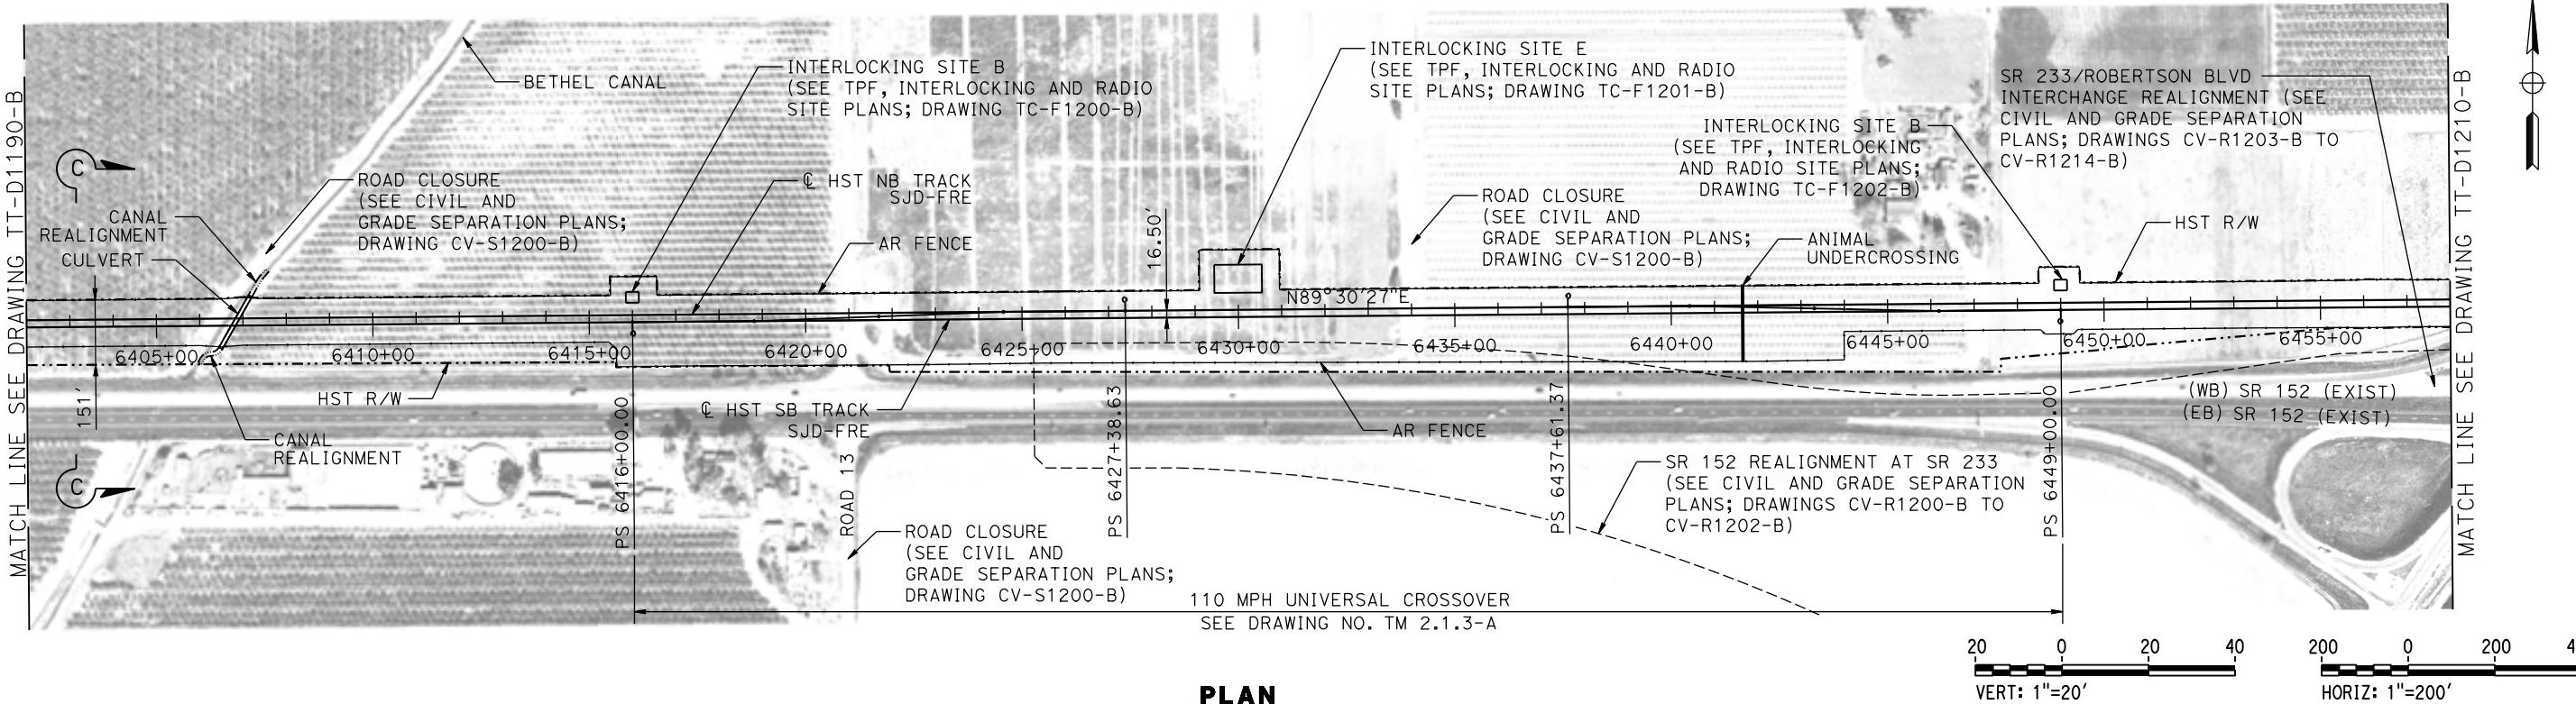

PLAN



08-MAR-2016 2:44

p004226

REV	DATE	BY	CHK	APP	DESCRIPTION

DESIGNED BY
D. OLIVETI
DRAWN BY
S. WILSON
CHECKED BY
N. OUM
IN CHARGE
C. LEMLEY
DATE
03/18/2016


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**NOT FOR
CONSTRUCTION**




**CALIFORNIA HIGH-SPEED TRAIN PROJECT
MERCED TO FRESNO SECTION**
CENTRAL VALLEY WYE
SR 152 (NORTH) TO ROAD 19 WYE ALTERNATIVE
TRACK PLAN AND PROFILE
SJD-FRE STA 6402+00 TO 6458+00

CONTRACT NO.
HSR08-05
DRAWING NO.
TT-D1200-B
SCALE
AS SHOWN
SHEET NO.
1

MADERA COUNTY

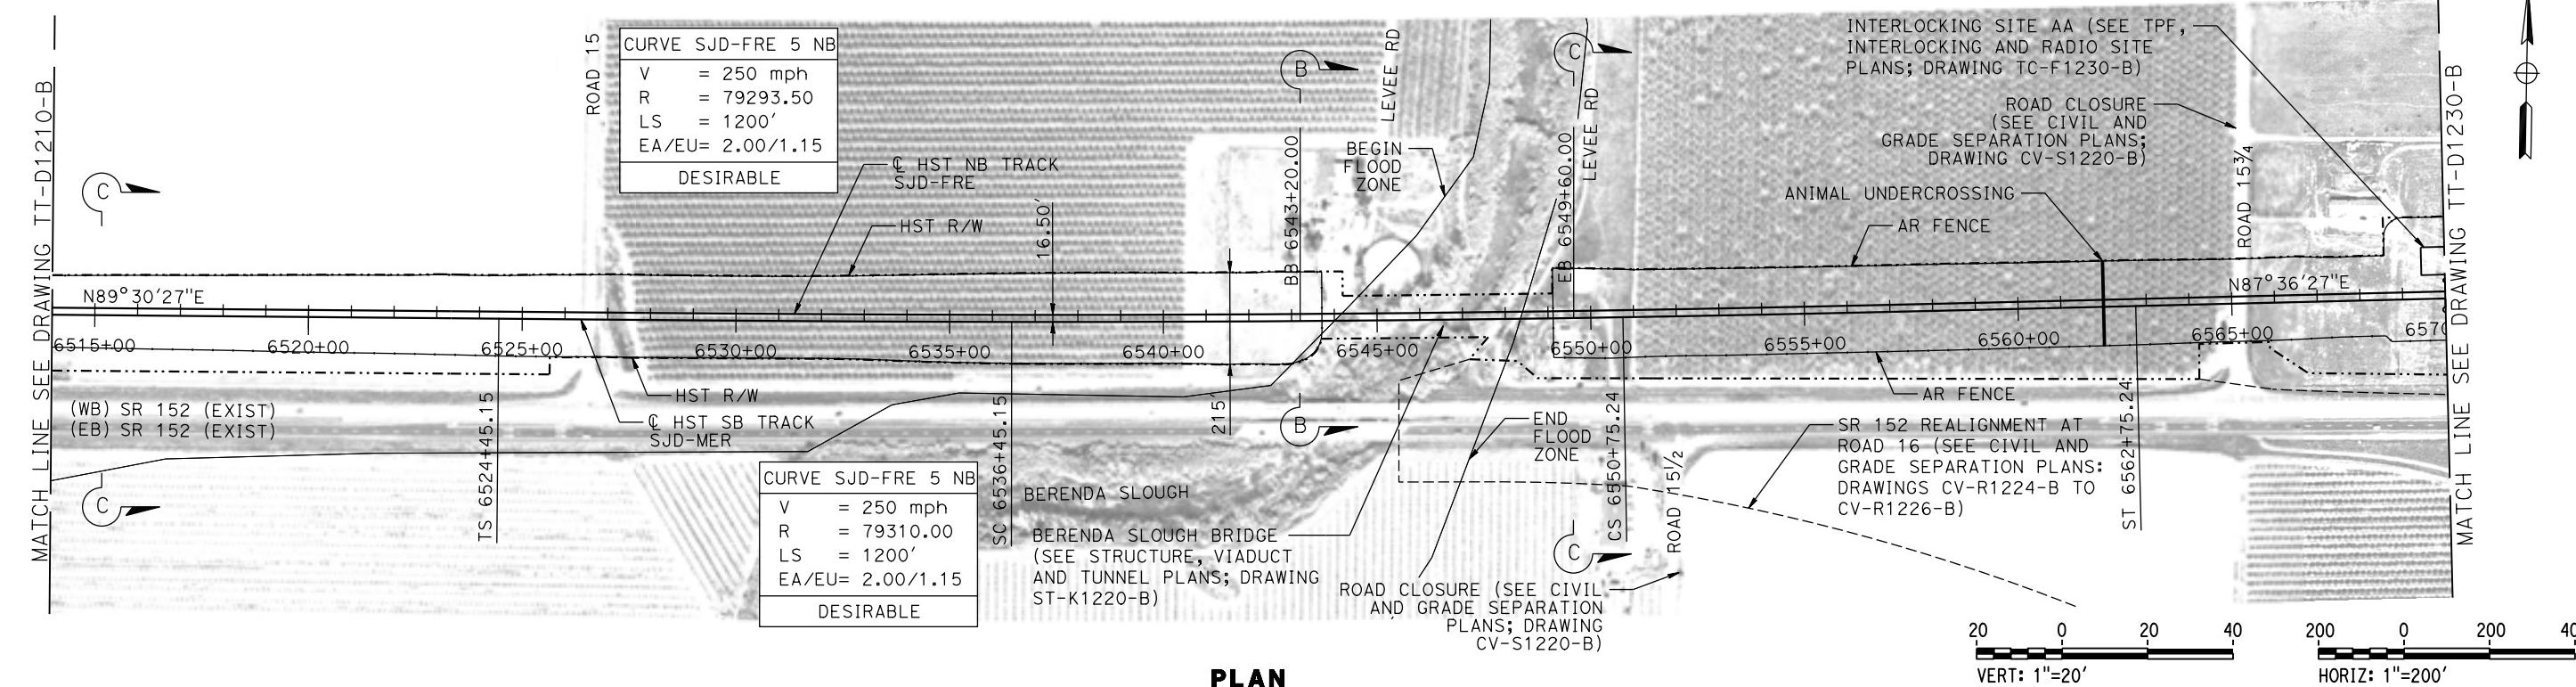

PLAN

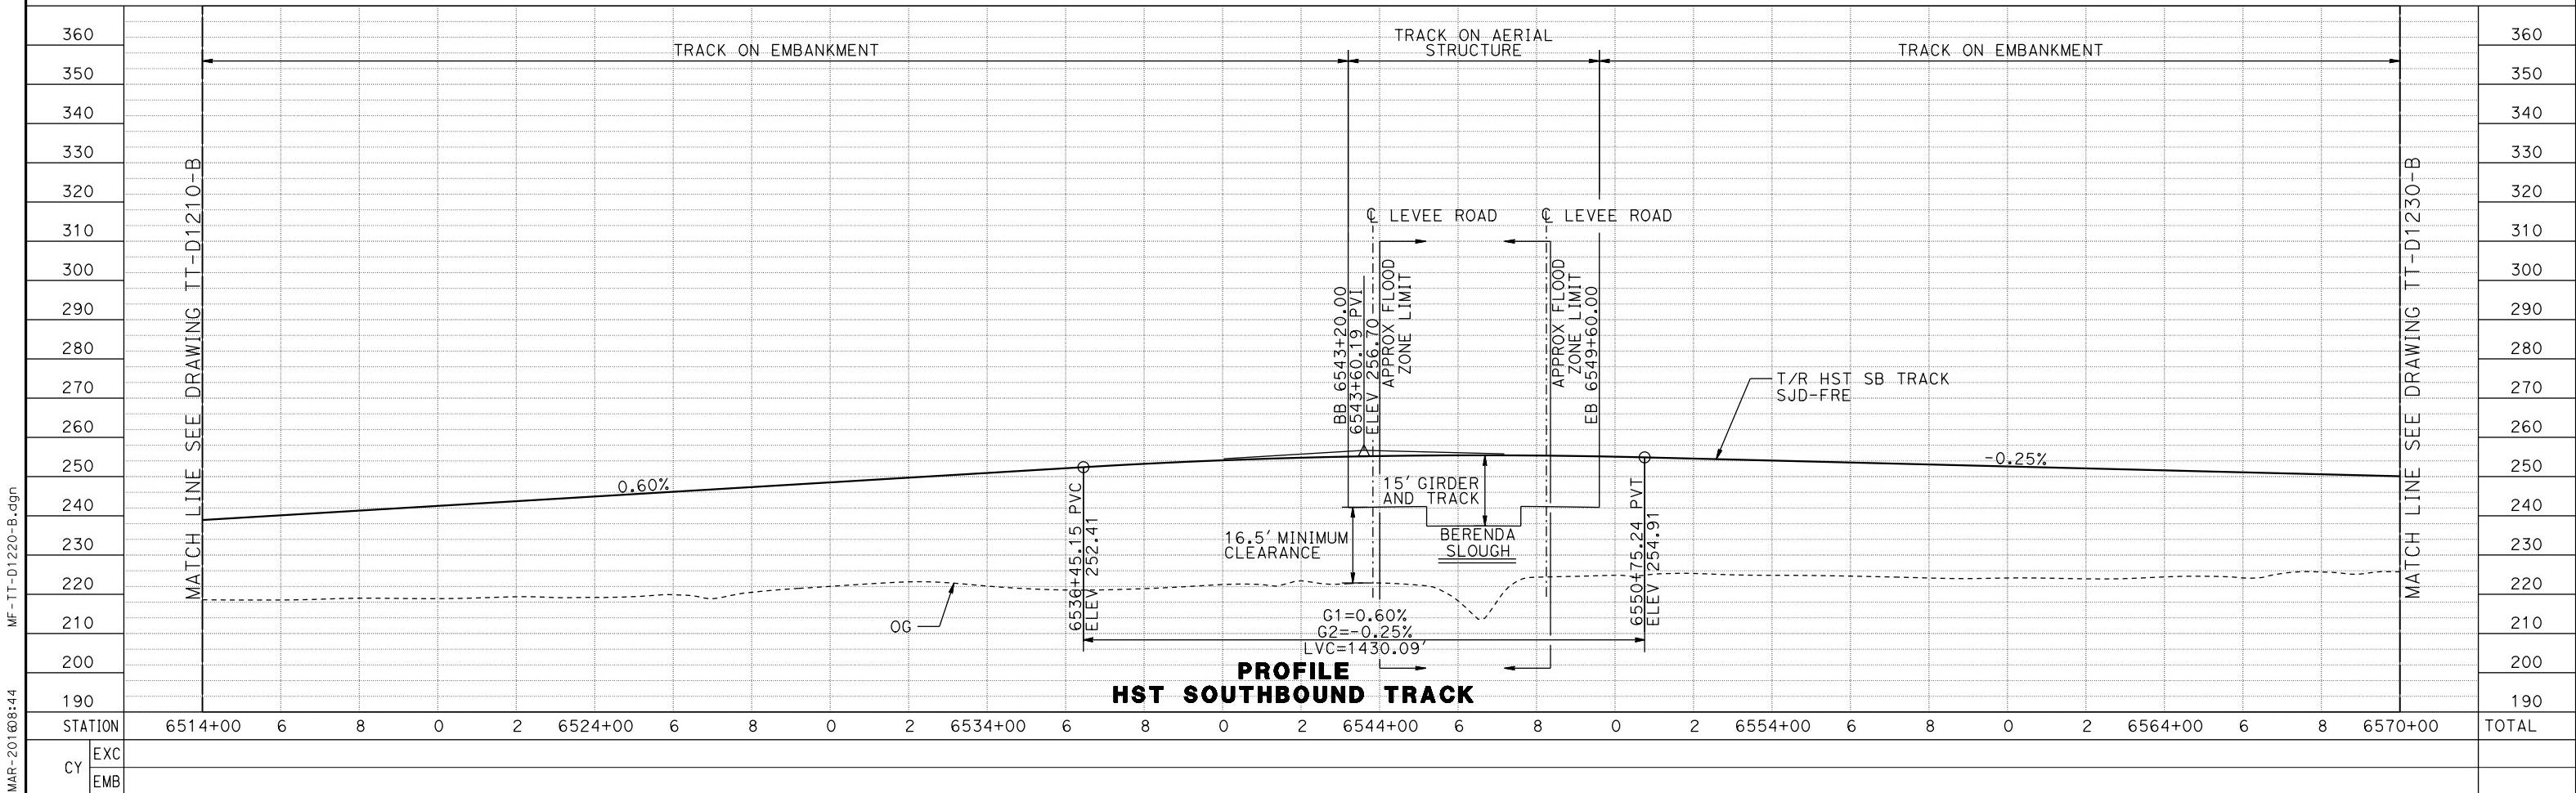


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DRAWN BY S. WILSON	NOT FOR CONSTRUCTION	DRAWING NO. TT-D1220-B
CHECKED BY N. OUM		SCALE AS SHOWN
IN CHARGE C. LEMLEY		SHEET NO.
DATE 03/18/2016		
REV DATE BY CHK APP	DESCRIPTION	




CALIFORNIA HIGH-SPEED TRAIN PROJECT MERCED TO FRESNO SECTION

CENTRAL VALLEY WYE
SR 152 (NORTH) TO ROAD 19 WYE ALTERNATIVE
TRACK PLAN AND PROFILE
SJD-FRE STA 6514+00 TO 6570+00

MADERA COUNTY

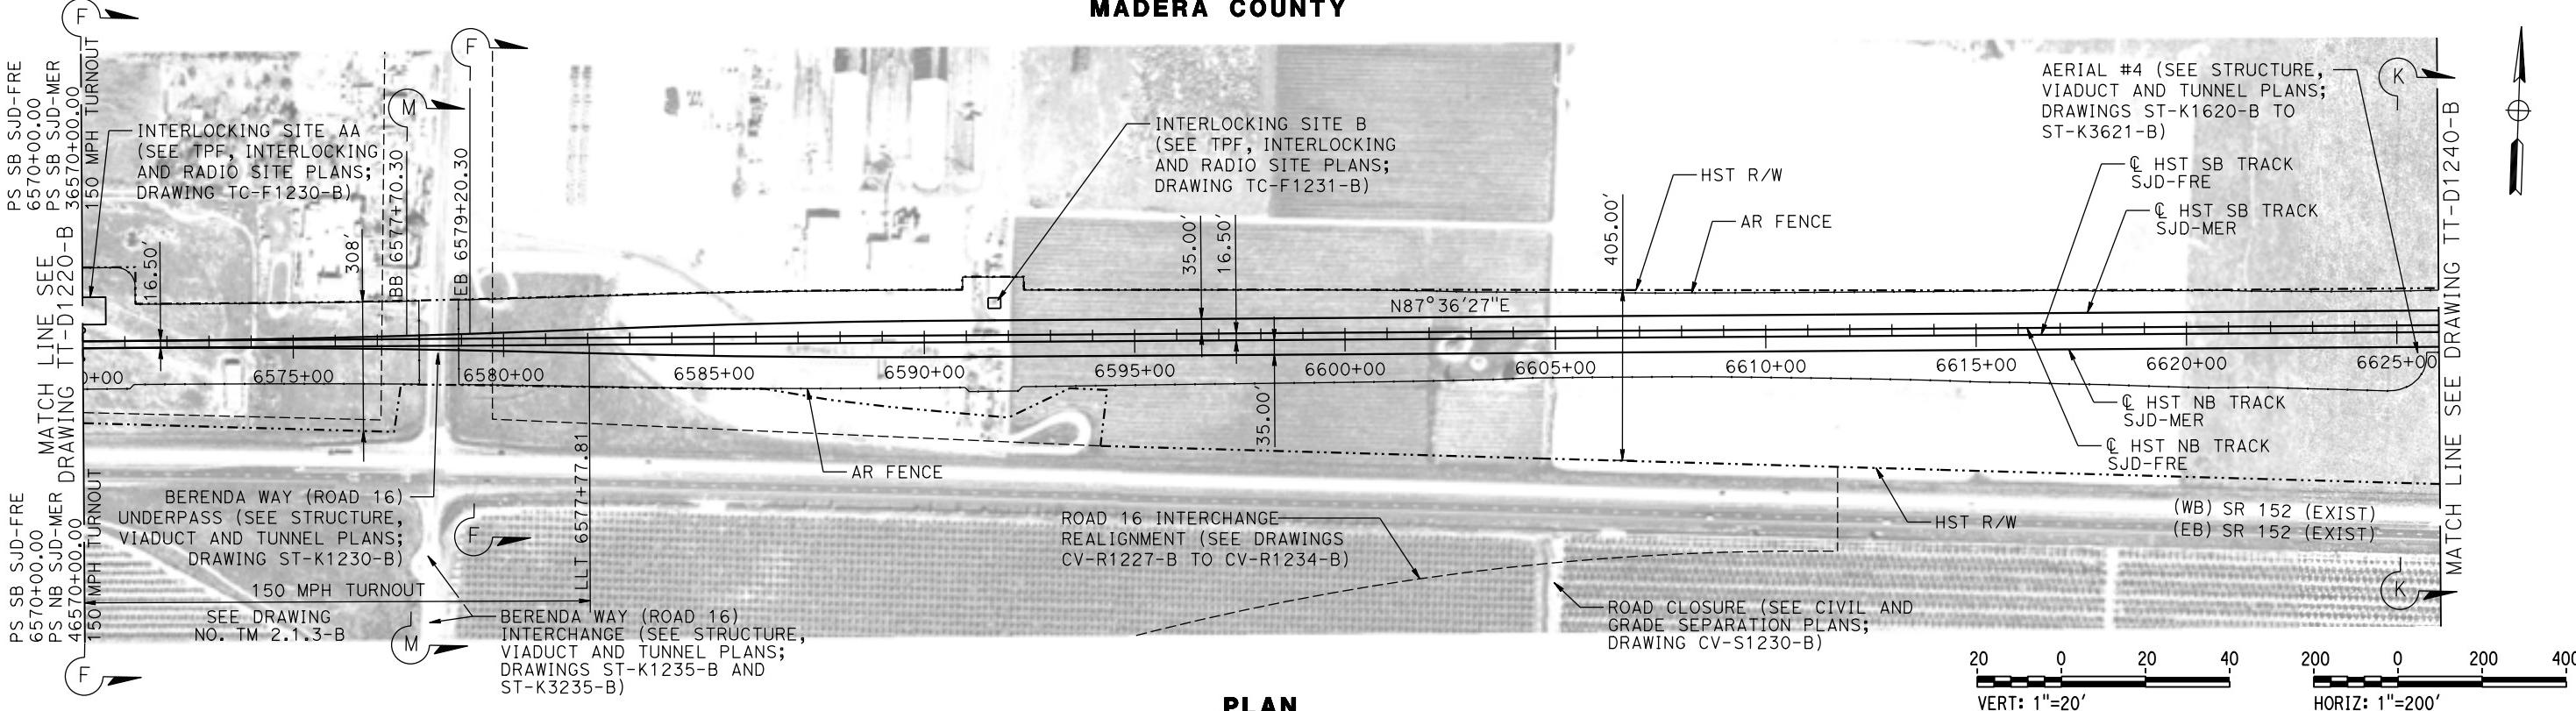

PLAN

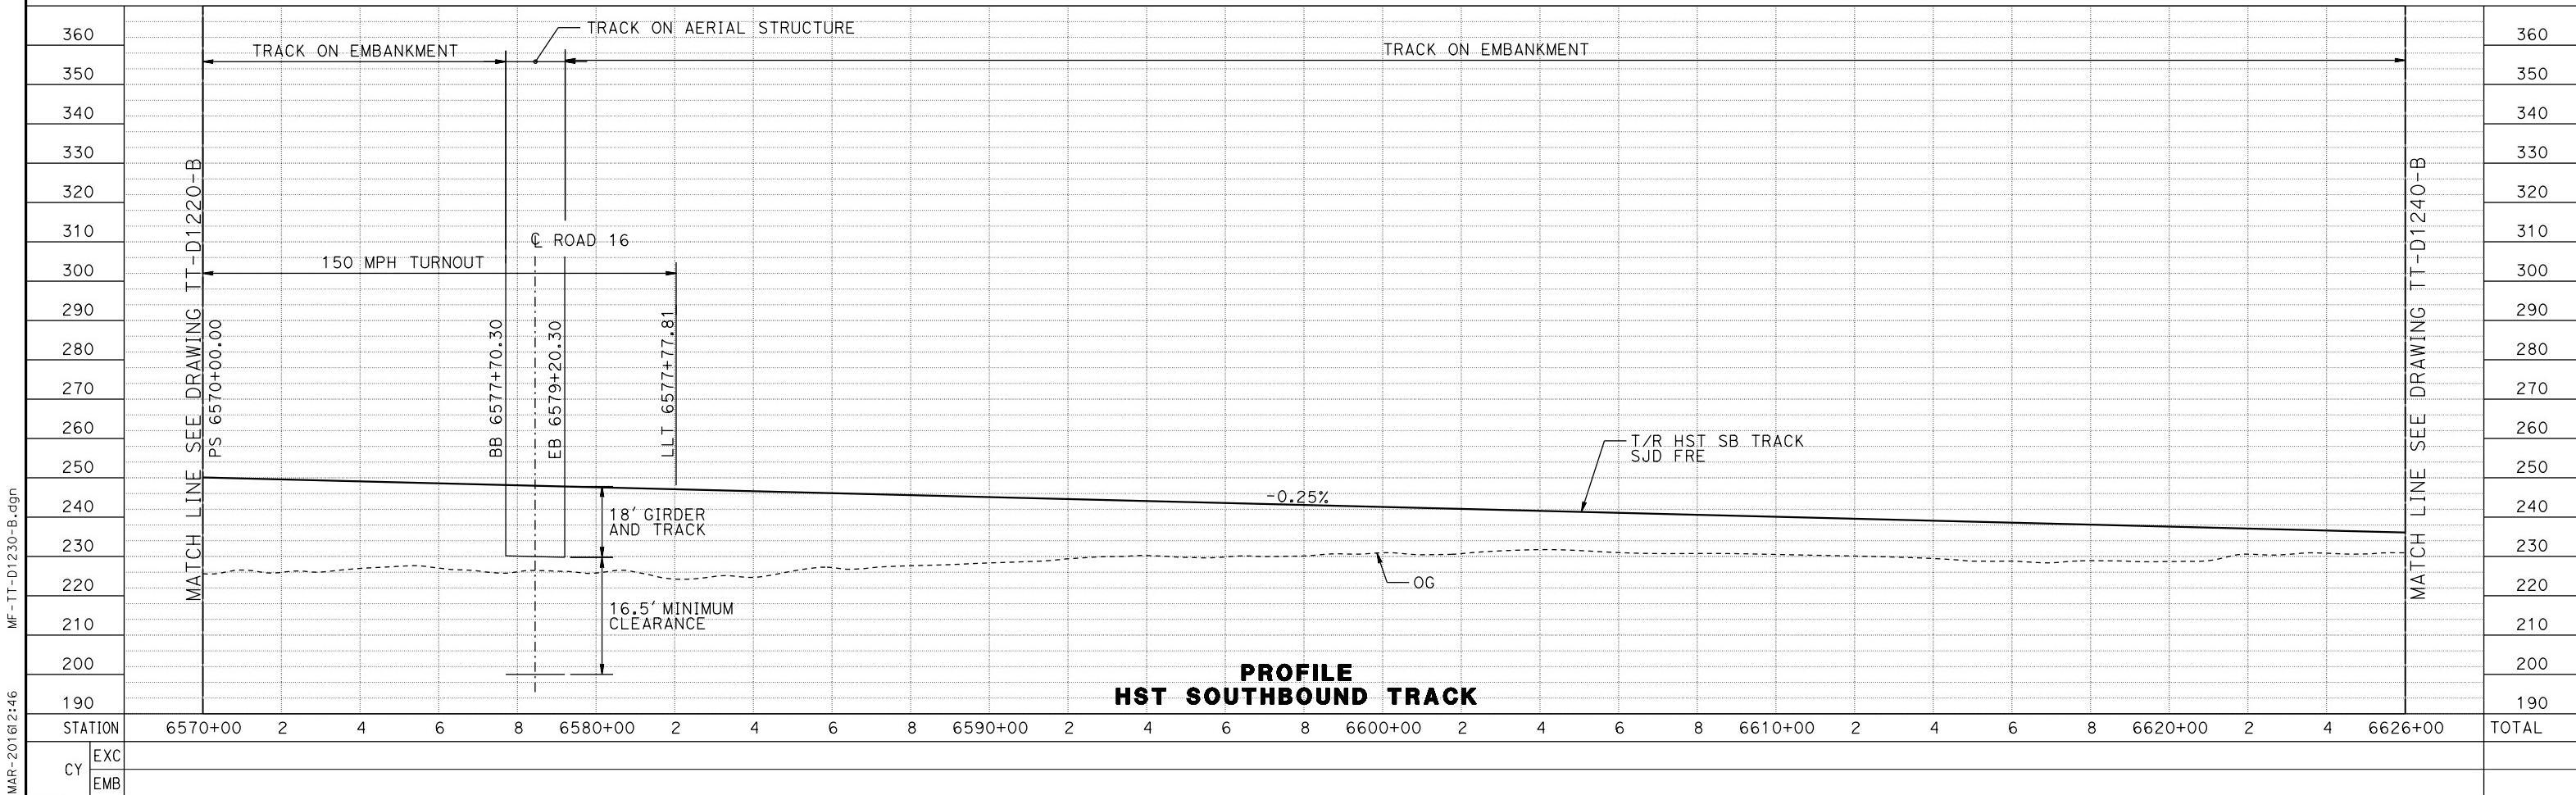



REV	DATE	BY	CHK	APP	DESCRIPTION	DESIGNED BY D. OLIVETI	DRAWN BY S. WILSON	CHECKED BY N. OUM	IN CHARGE C. LEMLEY	RECORD SET 15% DESIGN SUBMITTAL	NOT FOR CONSTRUCTION	CALIFORNIA HIGH-SPEED TRAIN PROJECT MERCED TO FRESNO SECTION	CONTRACT NO. HSR08-05
p004226	08-MAR-2016											CENTRAL VALLEY WYE SR 152 (NORTH) TO ROAD 19 WYE ALTERNATIVE TRACK PLAN AND PROFILE SJD-FRE STA 6570+00 TO 6626+00	DRAWING NO. TT-D1230-B




CALIFORNIA HIGH-SPEED TRAIN PROJECT
MERCED TO FRESNO SECTION

CONTRACT NO.
HSR08-05
DRAWING NO.
TT-D1230-B
SCALE
AS SHOWN
SHEET NO.


MADERA COUNTY

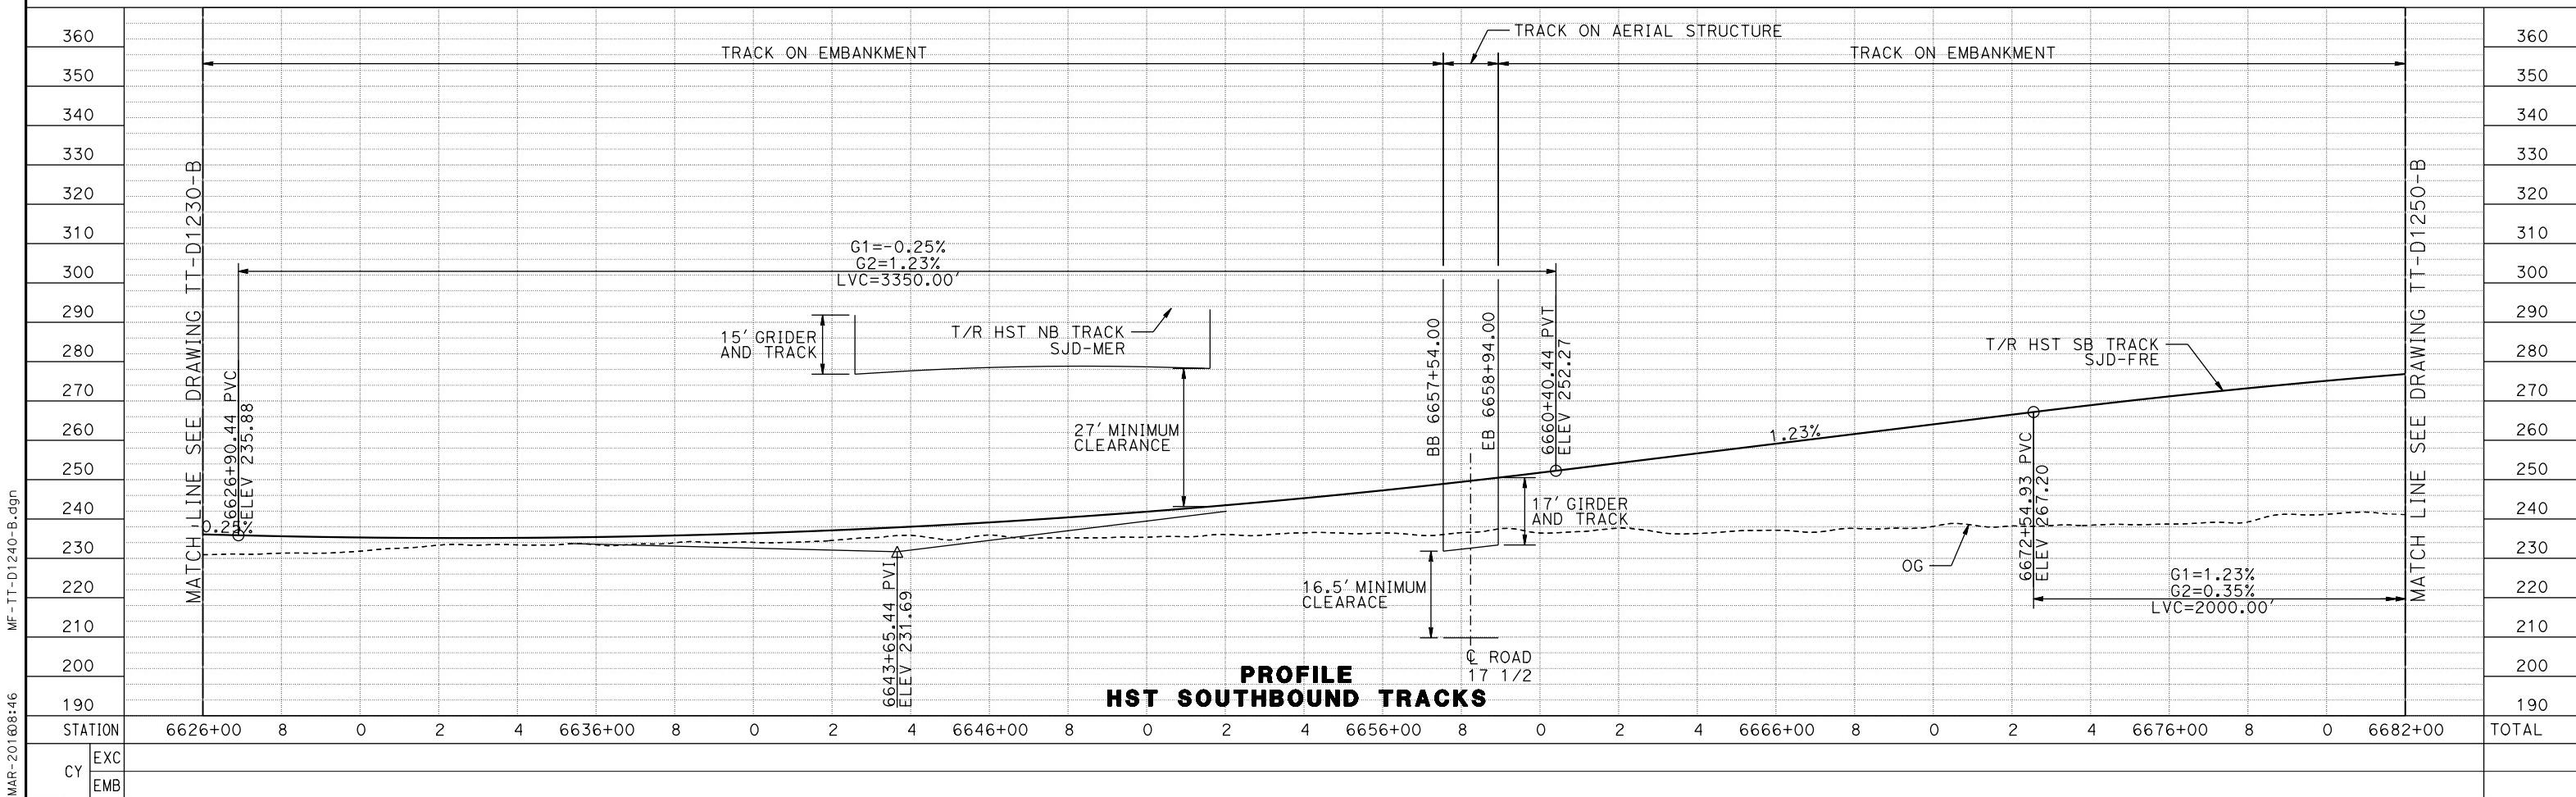
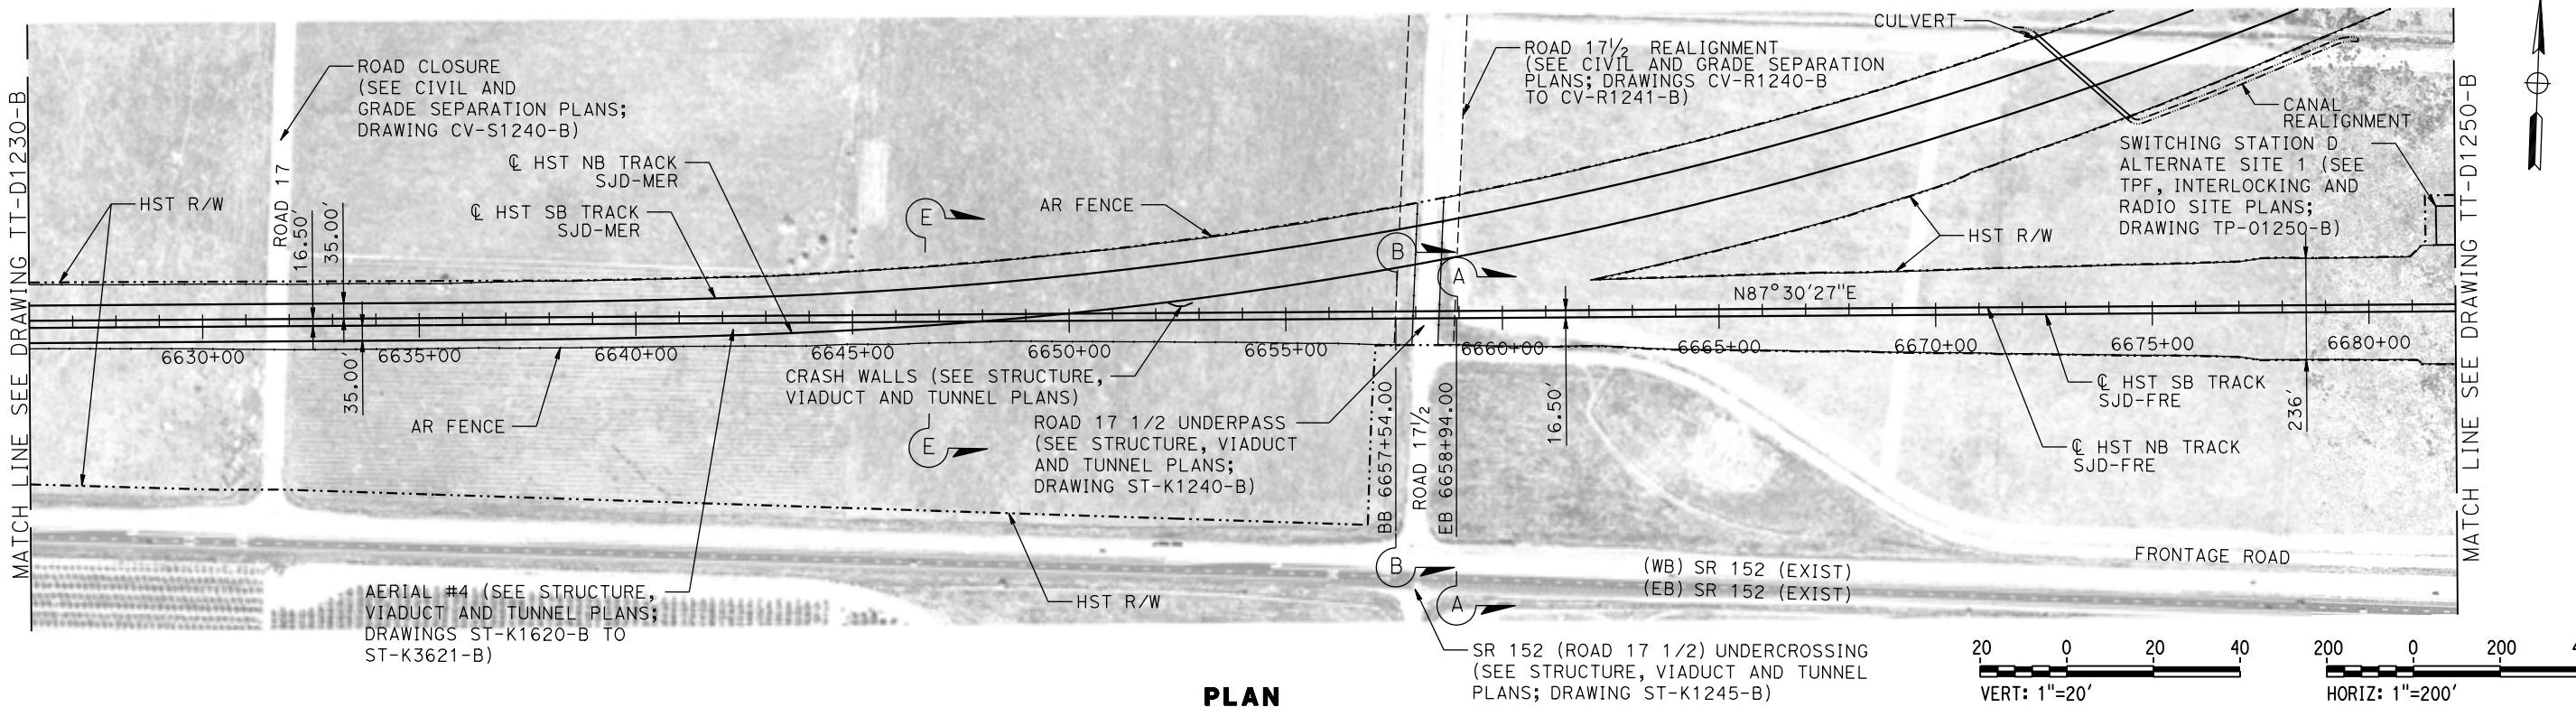


DESIGNED BY D. OLIVETI	RECORD SET 15% DESIGN SUBMITTAL	CONTRACT NO. HSR08-05
DRAWN BY S. WILSON	NOT FOR CONSTRUCTION	DRAWING NO. TT-D1240-B
CHECKED BY N. OUM		SCALE AS SHOWN
IN CHARGE C. LEMLEY		SHEET NO.
DATE 03/18/2016		
REV DATE BY CHK APP	DESCRIPTION	CALIFORNIA HIGH-SPEED TRAIN PROJECT MERCED TO FRESNO SECTION
p004226		CENTRAL VALLEY WYE SR 152 (NORTH) TO ROAD 19 WYE ALTERNATIVE TRACK PLAN AND PROFILE SJD-FRE STA 6626+00 TO 6682+00
		PARSONS
		CALIFORNIA HIGH-SPEED RAIL AUTHORITY


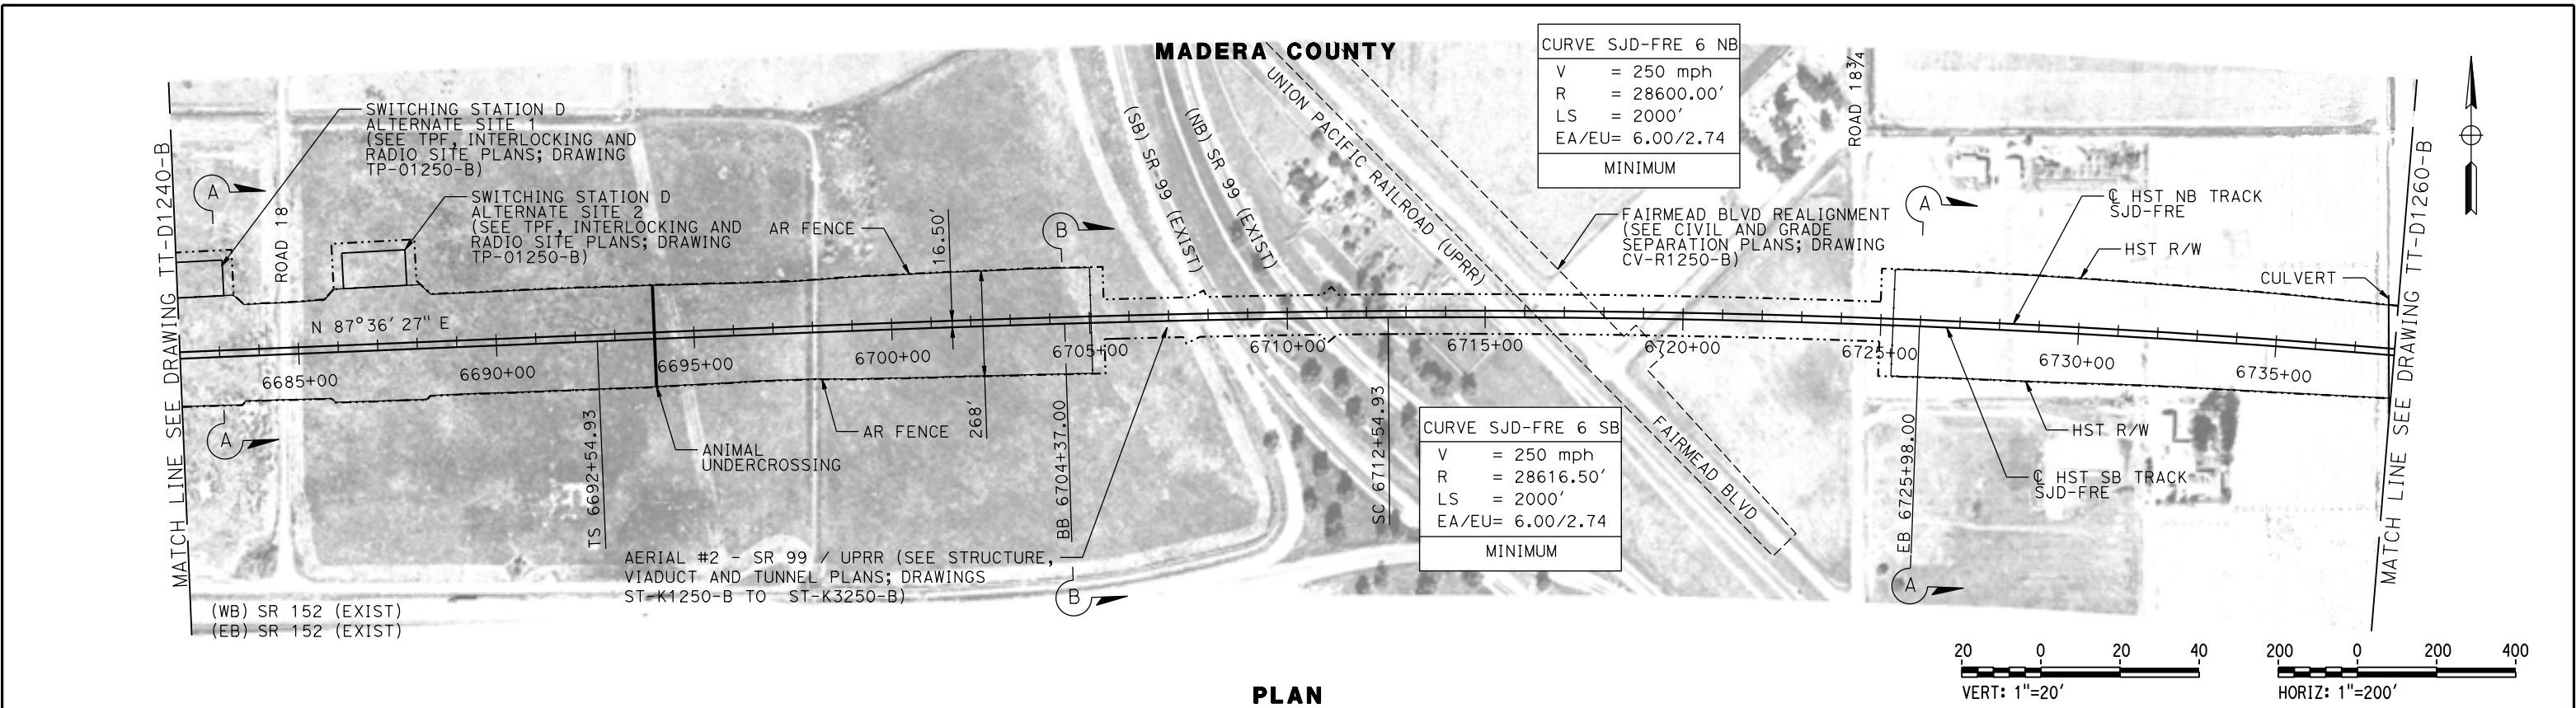


PLAN

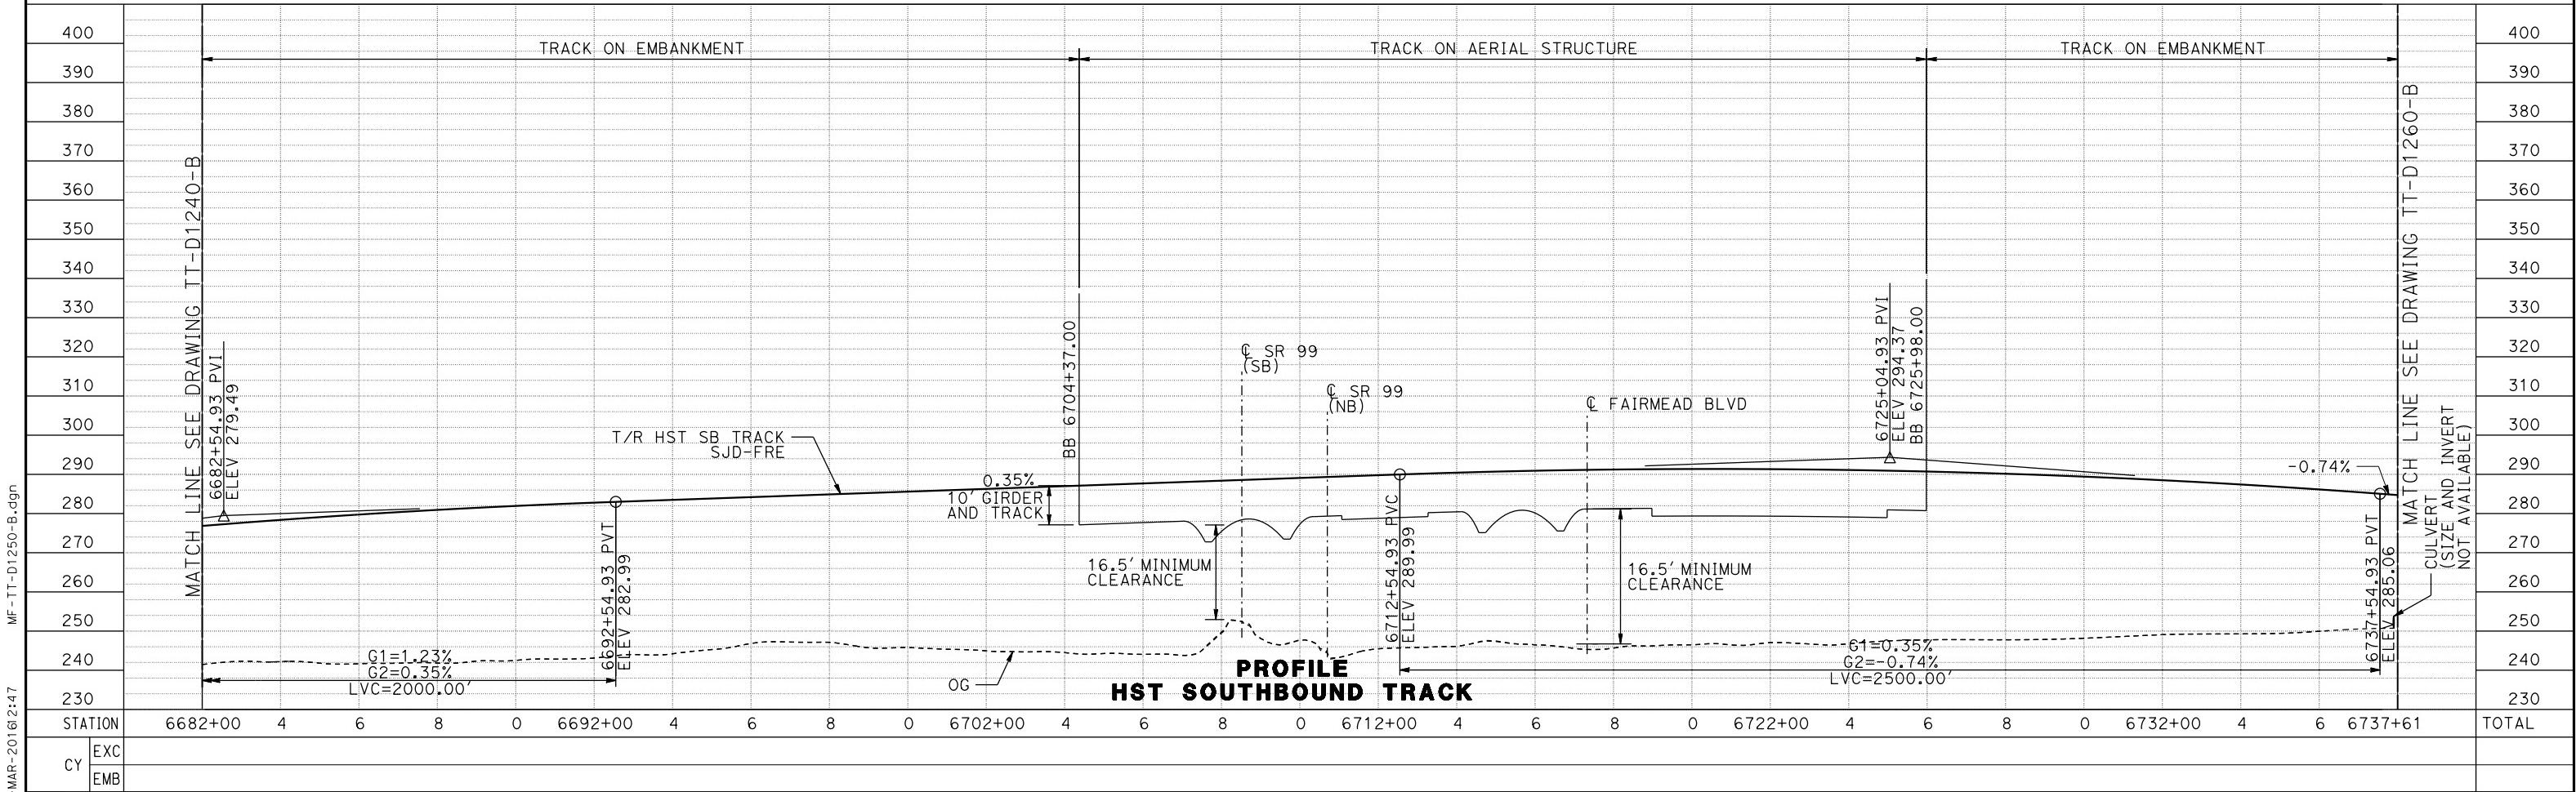

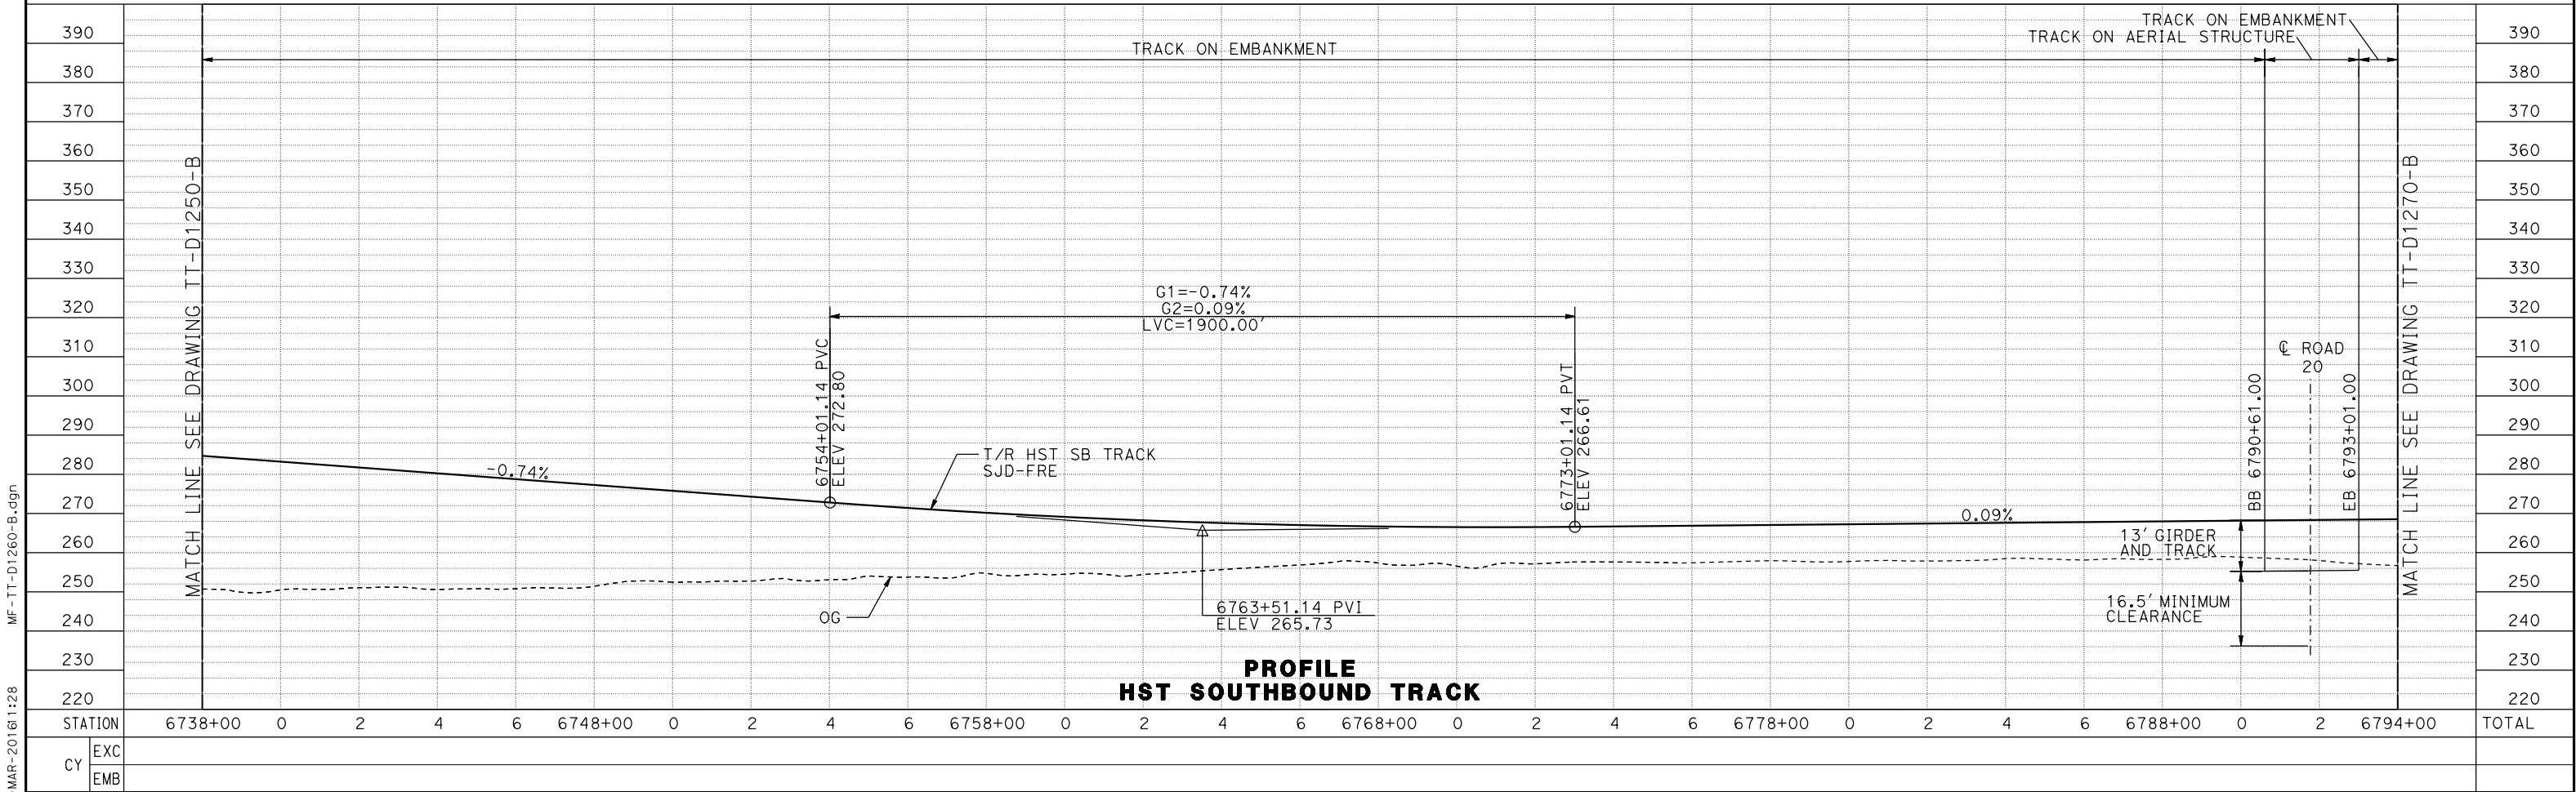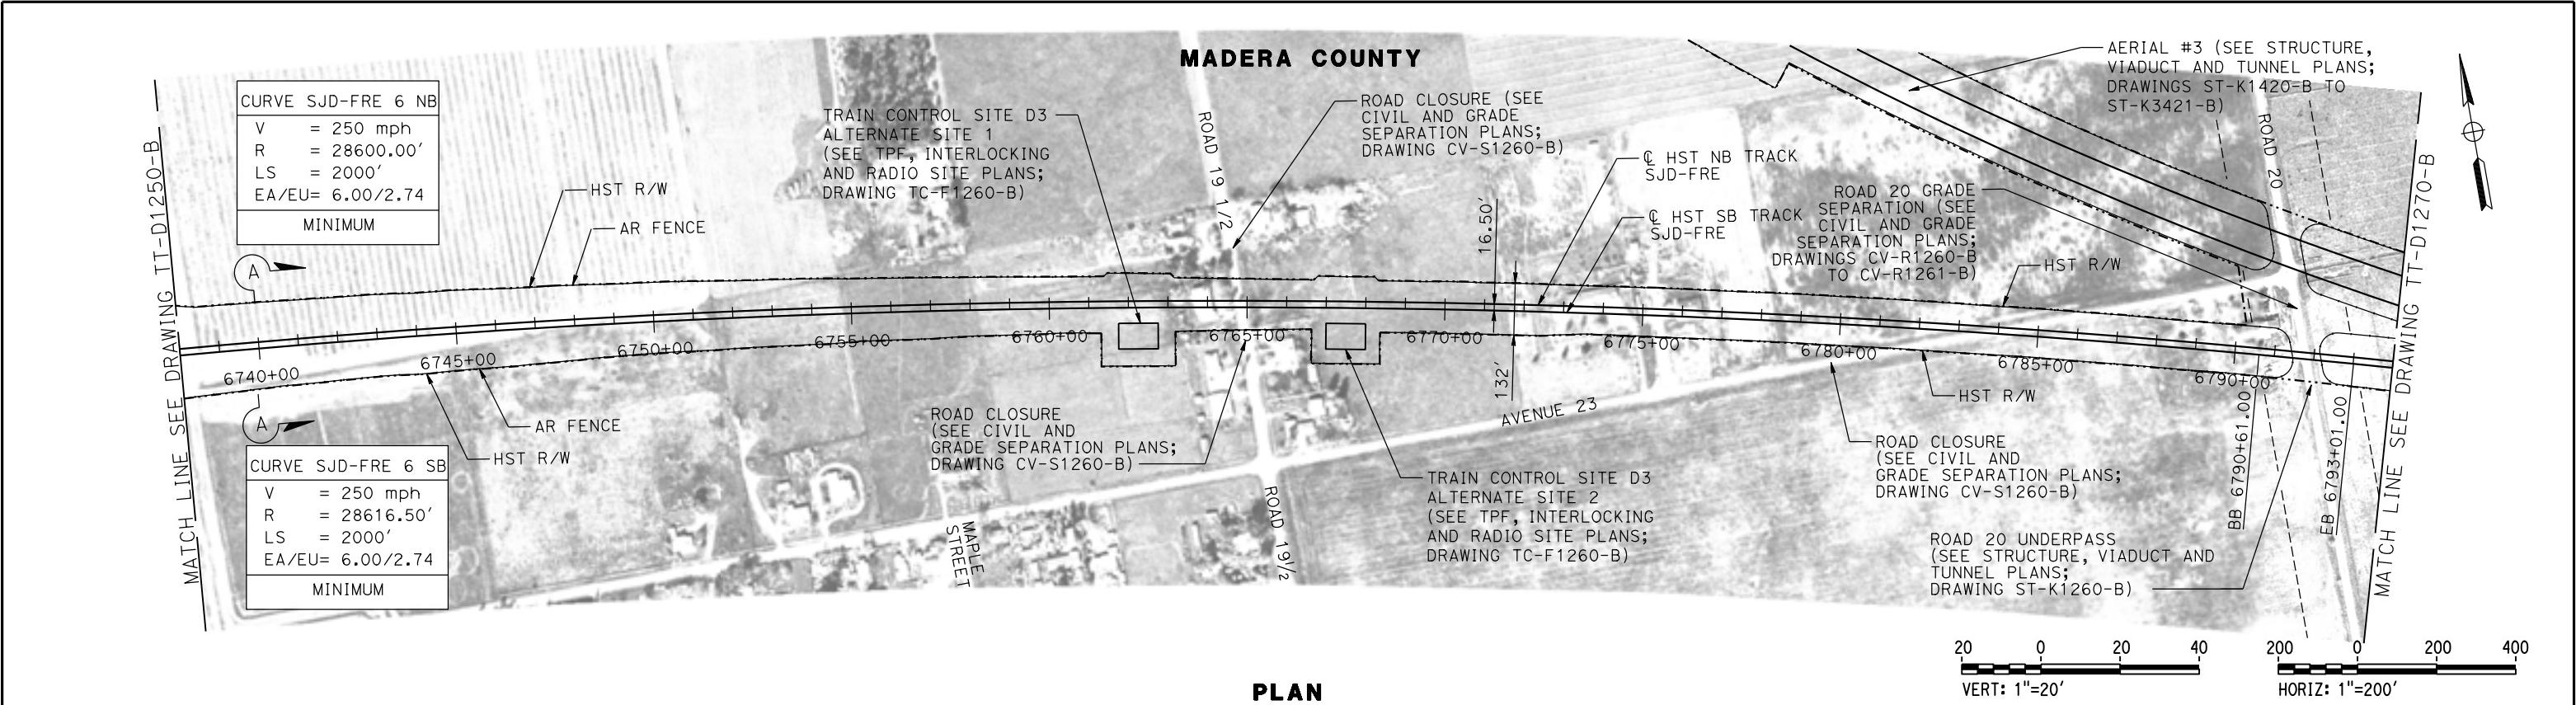


MADERA COUNTY

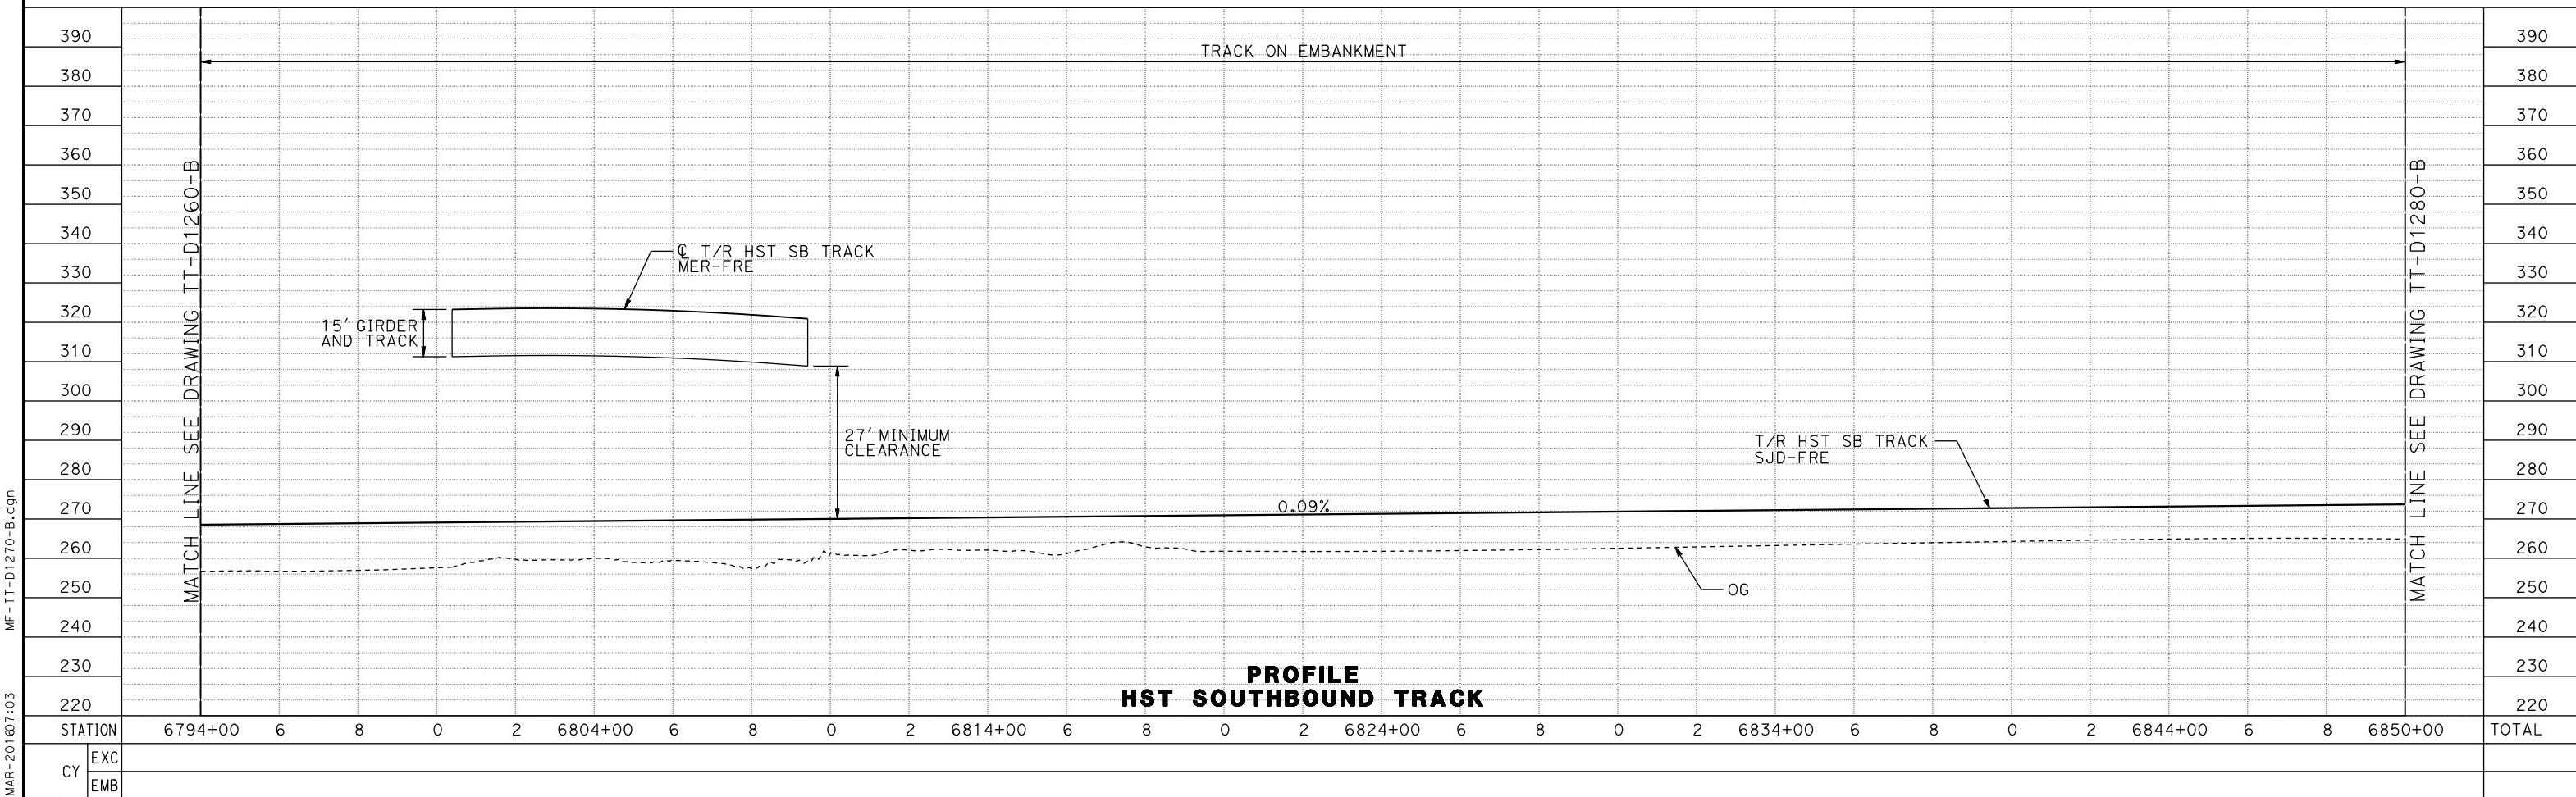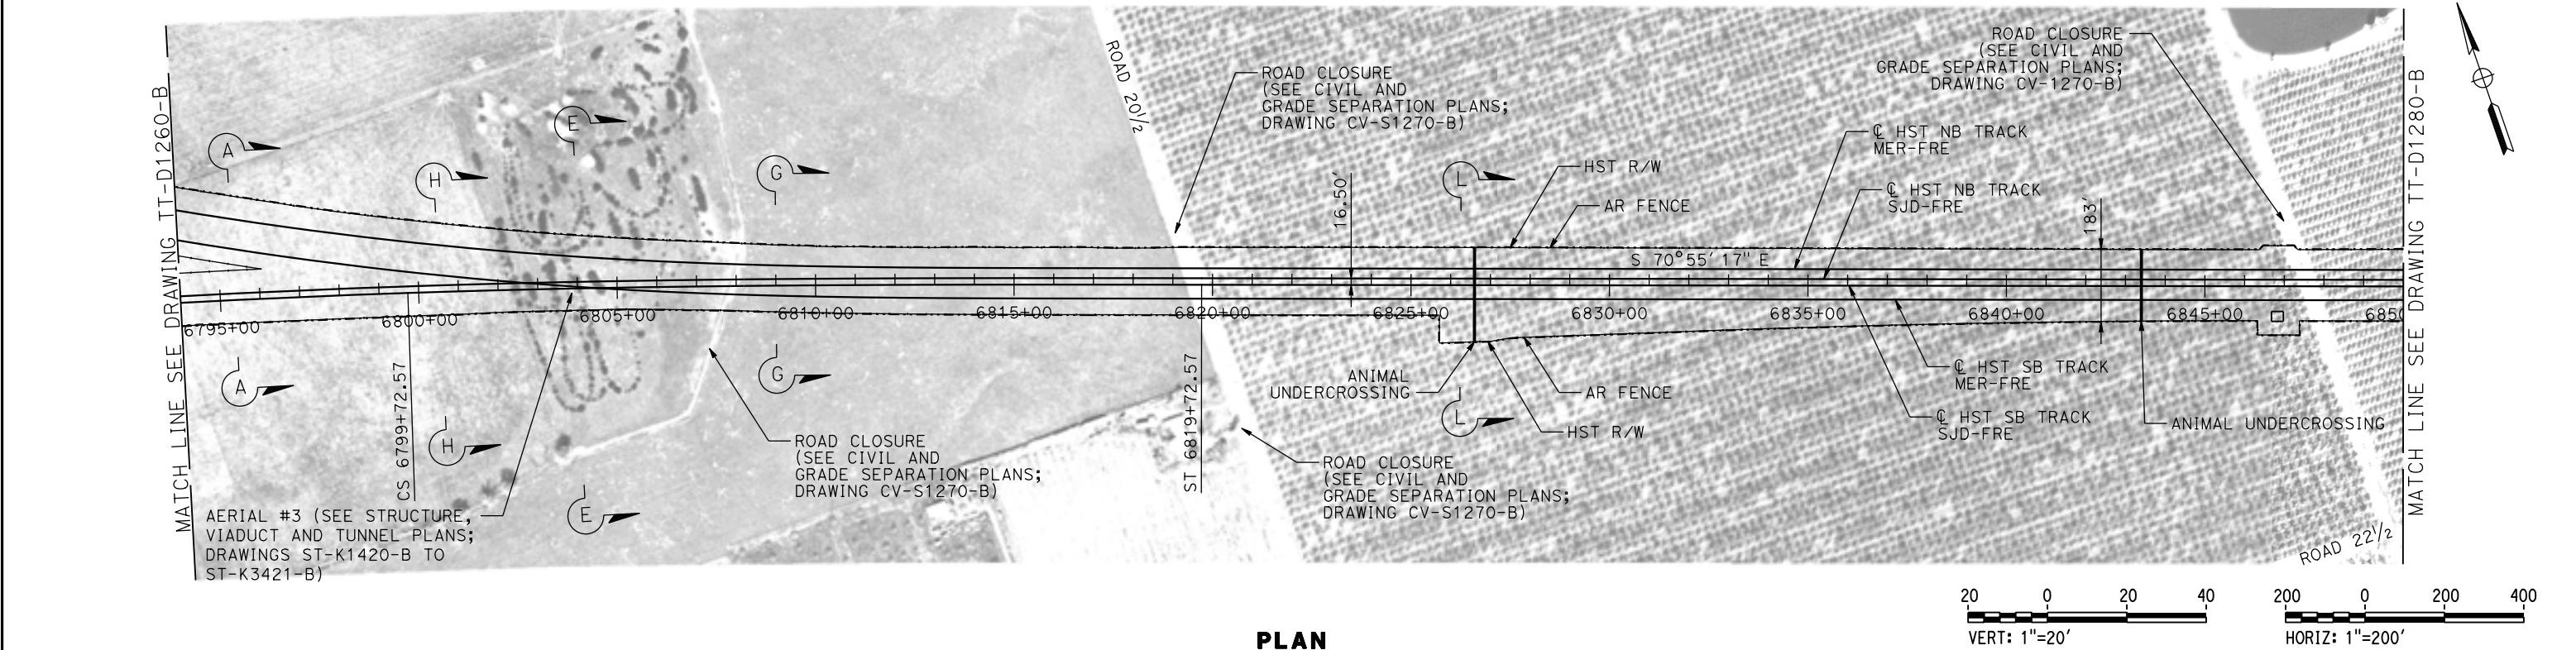


03-MAR-2016:07:03					DESIGNED BY D. OLIVETI	RECORD SET 15% DESIGN SUBMITTAL			CALIFORNIA HIGH-SPEED TRAIN PROJECT MERCED TO FRESNO SECTION	CONTRACT NO. HSR08-05
					DRAWN BY S. WILSON				CENTRAL VALLEY WYE	DRAWING NO. TT-D1270-B
					CHECKED BY N. OUM				SR 152 (NORTH) TO ROAD 19 WYE ALTERNATIVE	SCALE AS SHOWN
					IN CHARGE C. LEMLEY	NOT FOR CONSTRUCTION			TRACK PLAN AND PROFILE	SHEET NO. 000
p004226	REV	DATE	BY	CHK	APP	DESCRIPTION	03/18/2016		SJD-FRE STA 6794+00 TO 6850+00	

MADERA COUNTY

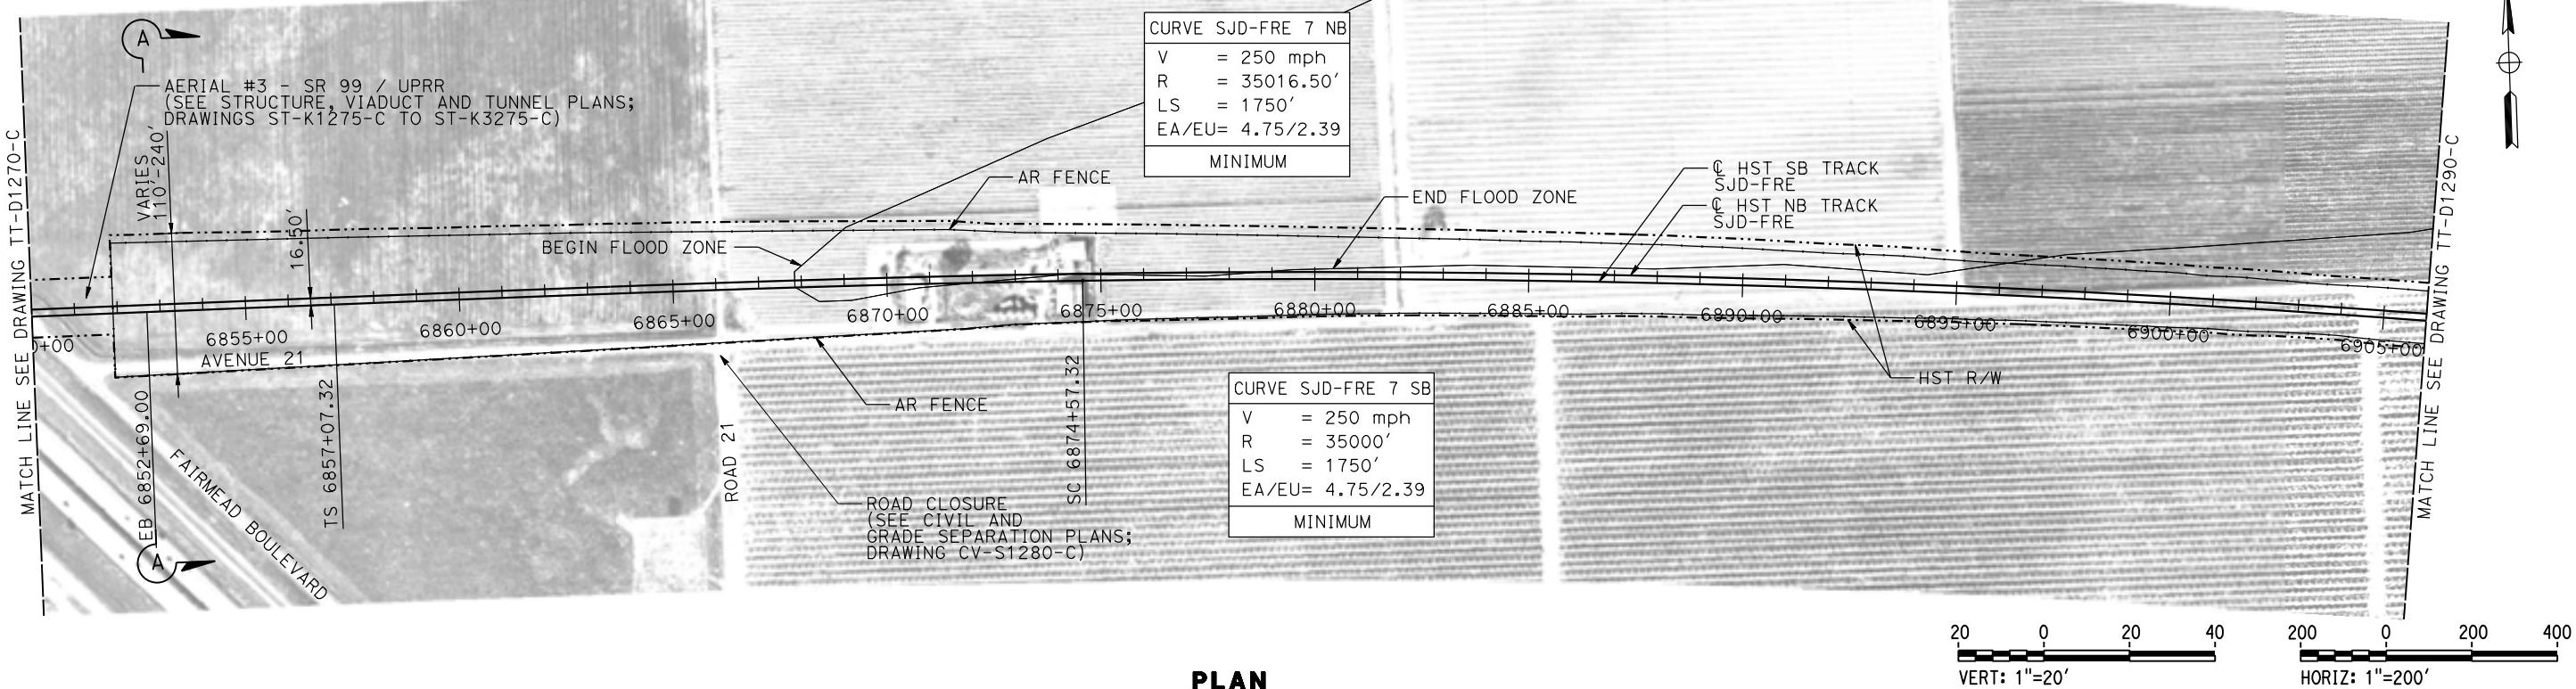

PLAN

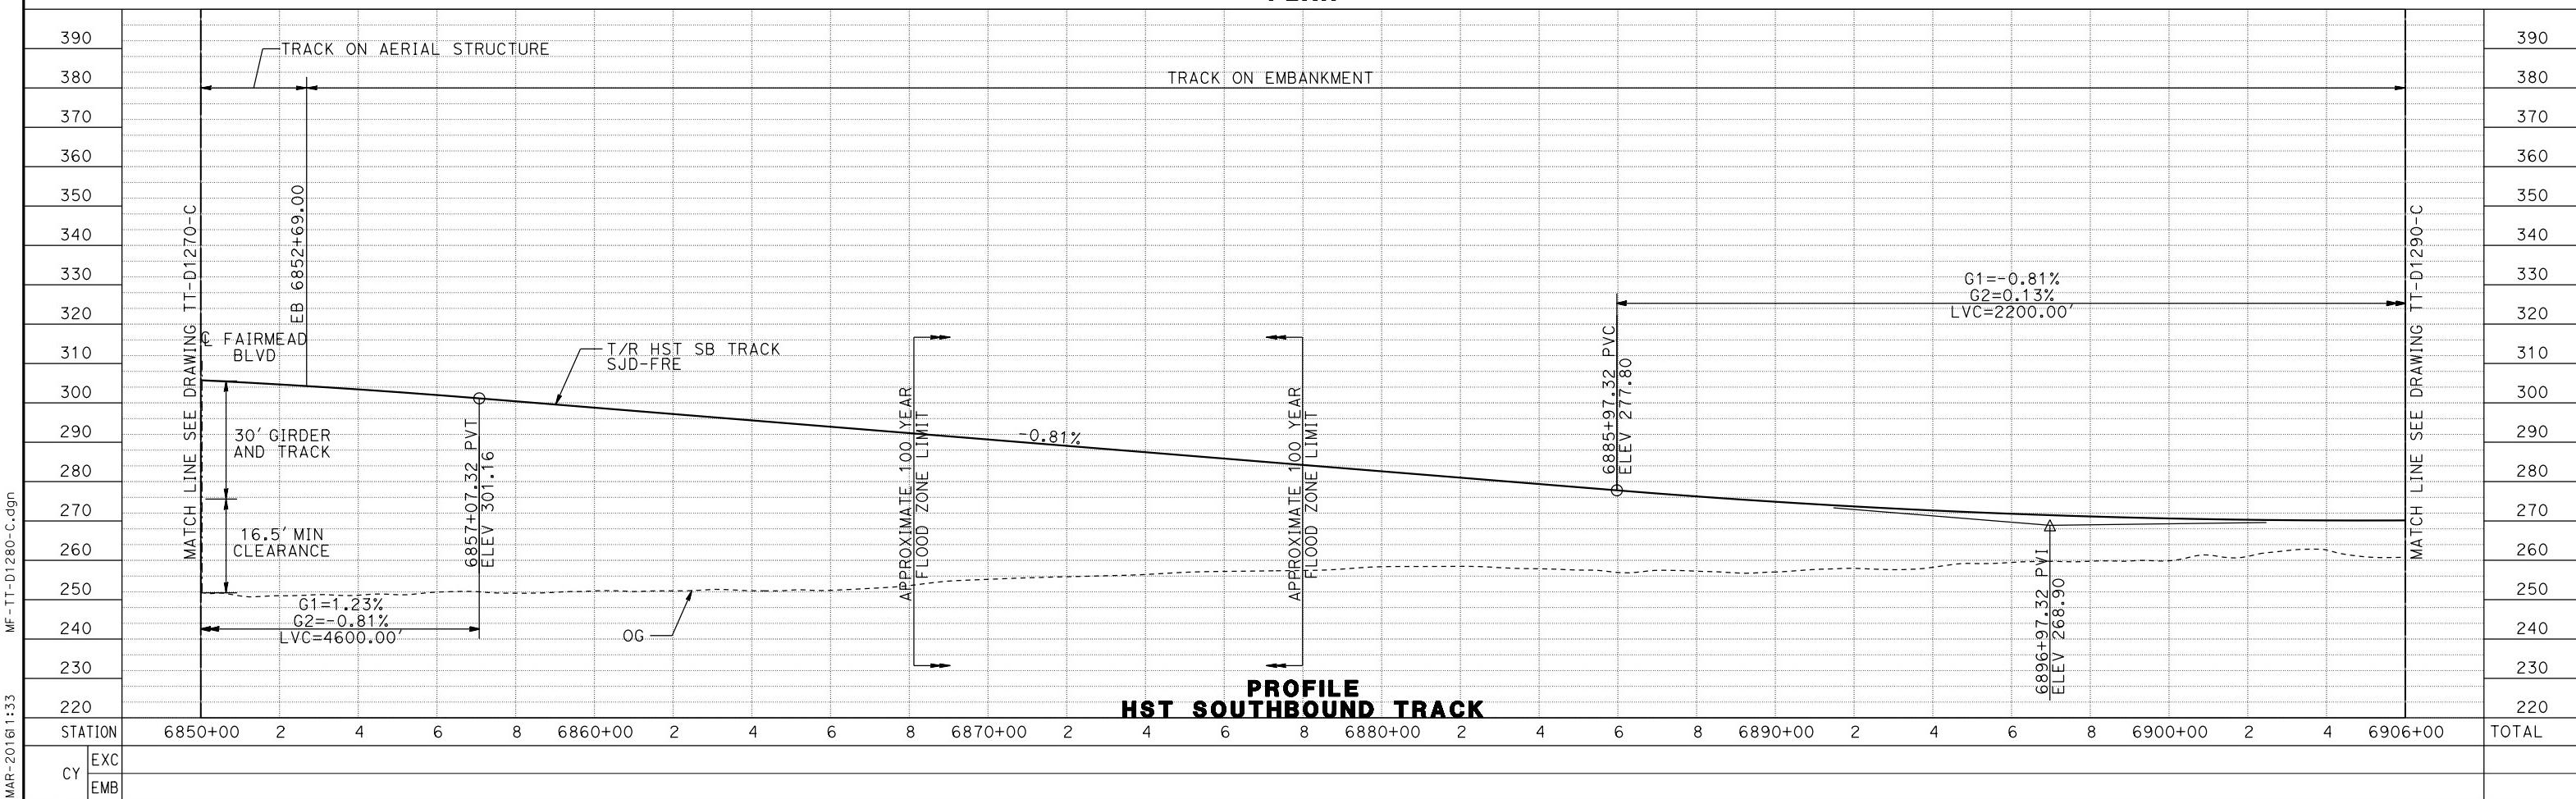

17-MAR-2016 1:33
p00513A

REV	DATE	BY	CHK	APP	DESCRIPTION

DESIGNED BY
D. OLIVETI
DRAWN BY
M. TACTAY
CHECKED BY
N. OUM
IN CHARGE
C. LEMLEY
DATE
03/18/2016


RECORD SET
15% DESIGN
SUBMITTAL
NOT FOR
CONSTRUCTION




**CALIFORNIA HIGH-SPEED TRAIN PROJECT
MERCED TO FRESNO SECTION**
CENTRAL VALLEY WYE
AVENUE 21 TO ROAD 13 WYE ALTERNATIVE
TRACK PLAN AND PROFILE
SJD-FRE STA 6850+00 TO 6906+00

CONTRACT NO.
HSR08-05
DRAWING NO.
TT-D1280-C
SCALE
AS SHOWN
SHEET NO.
1

MADERA COUNTY

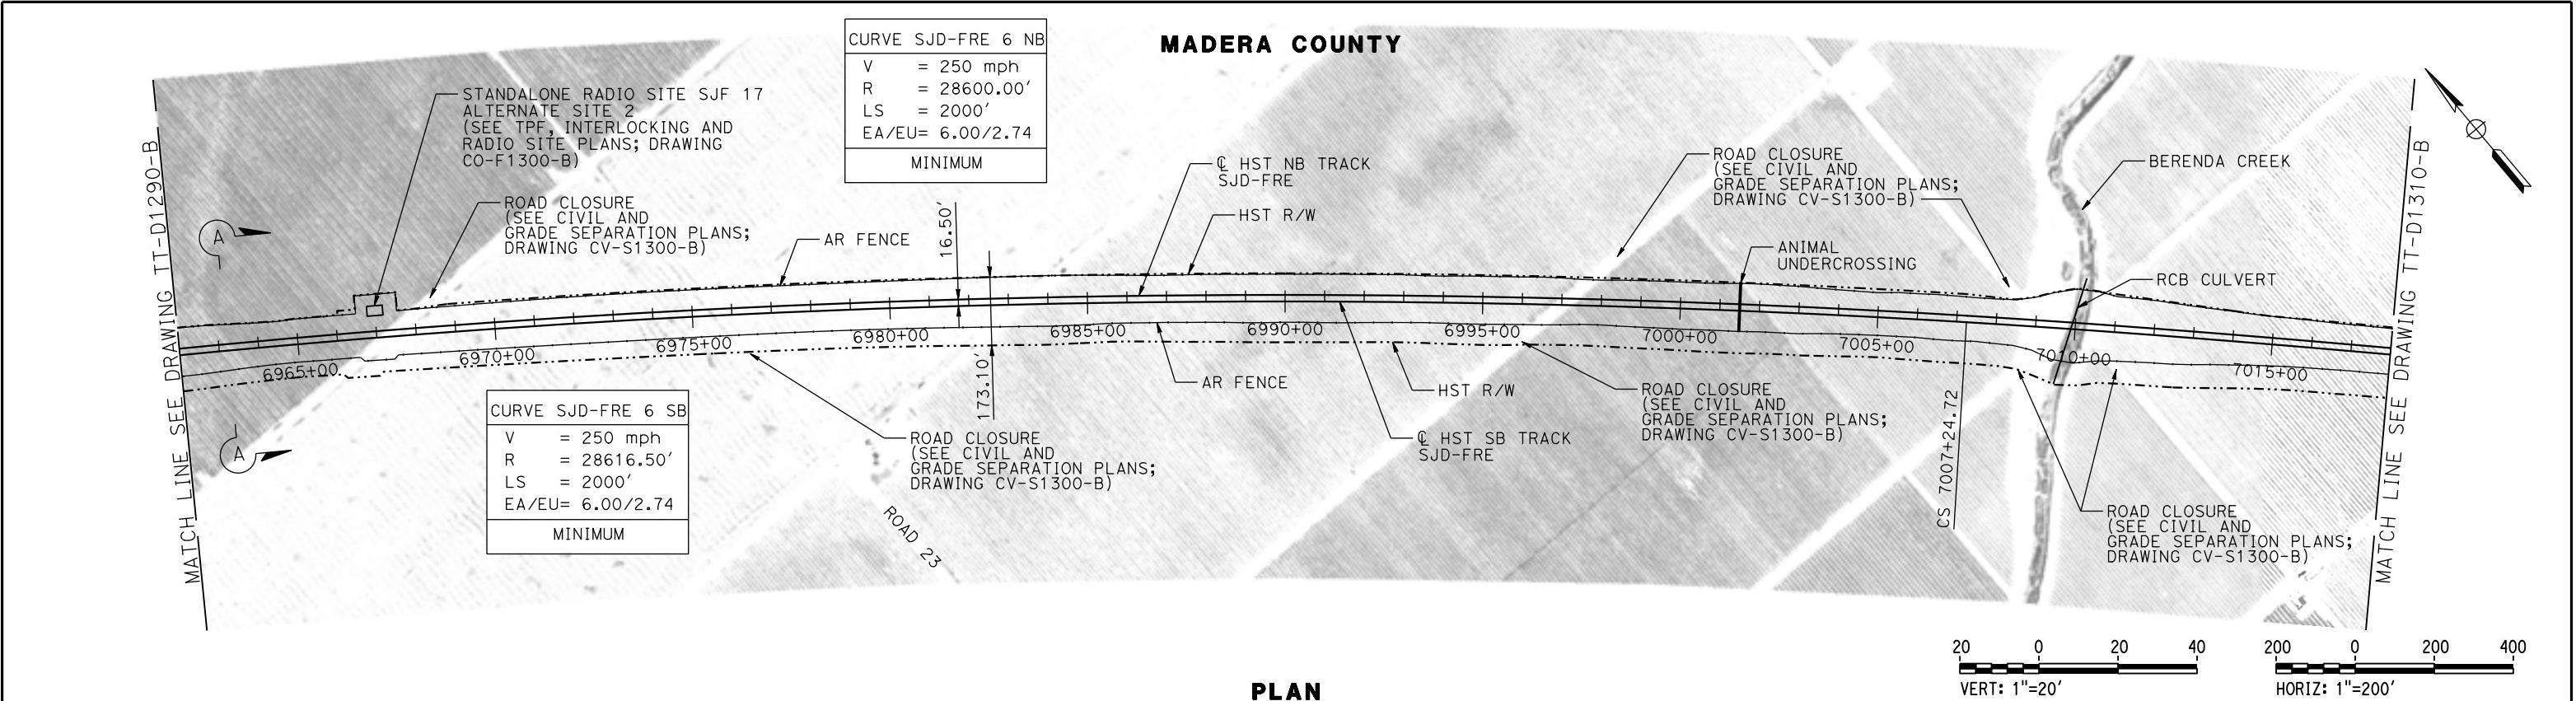


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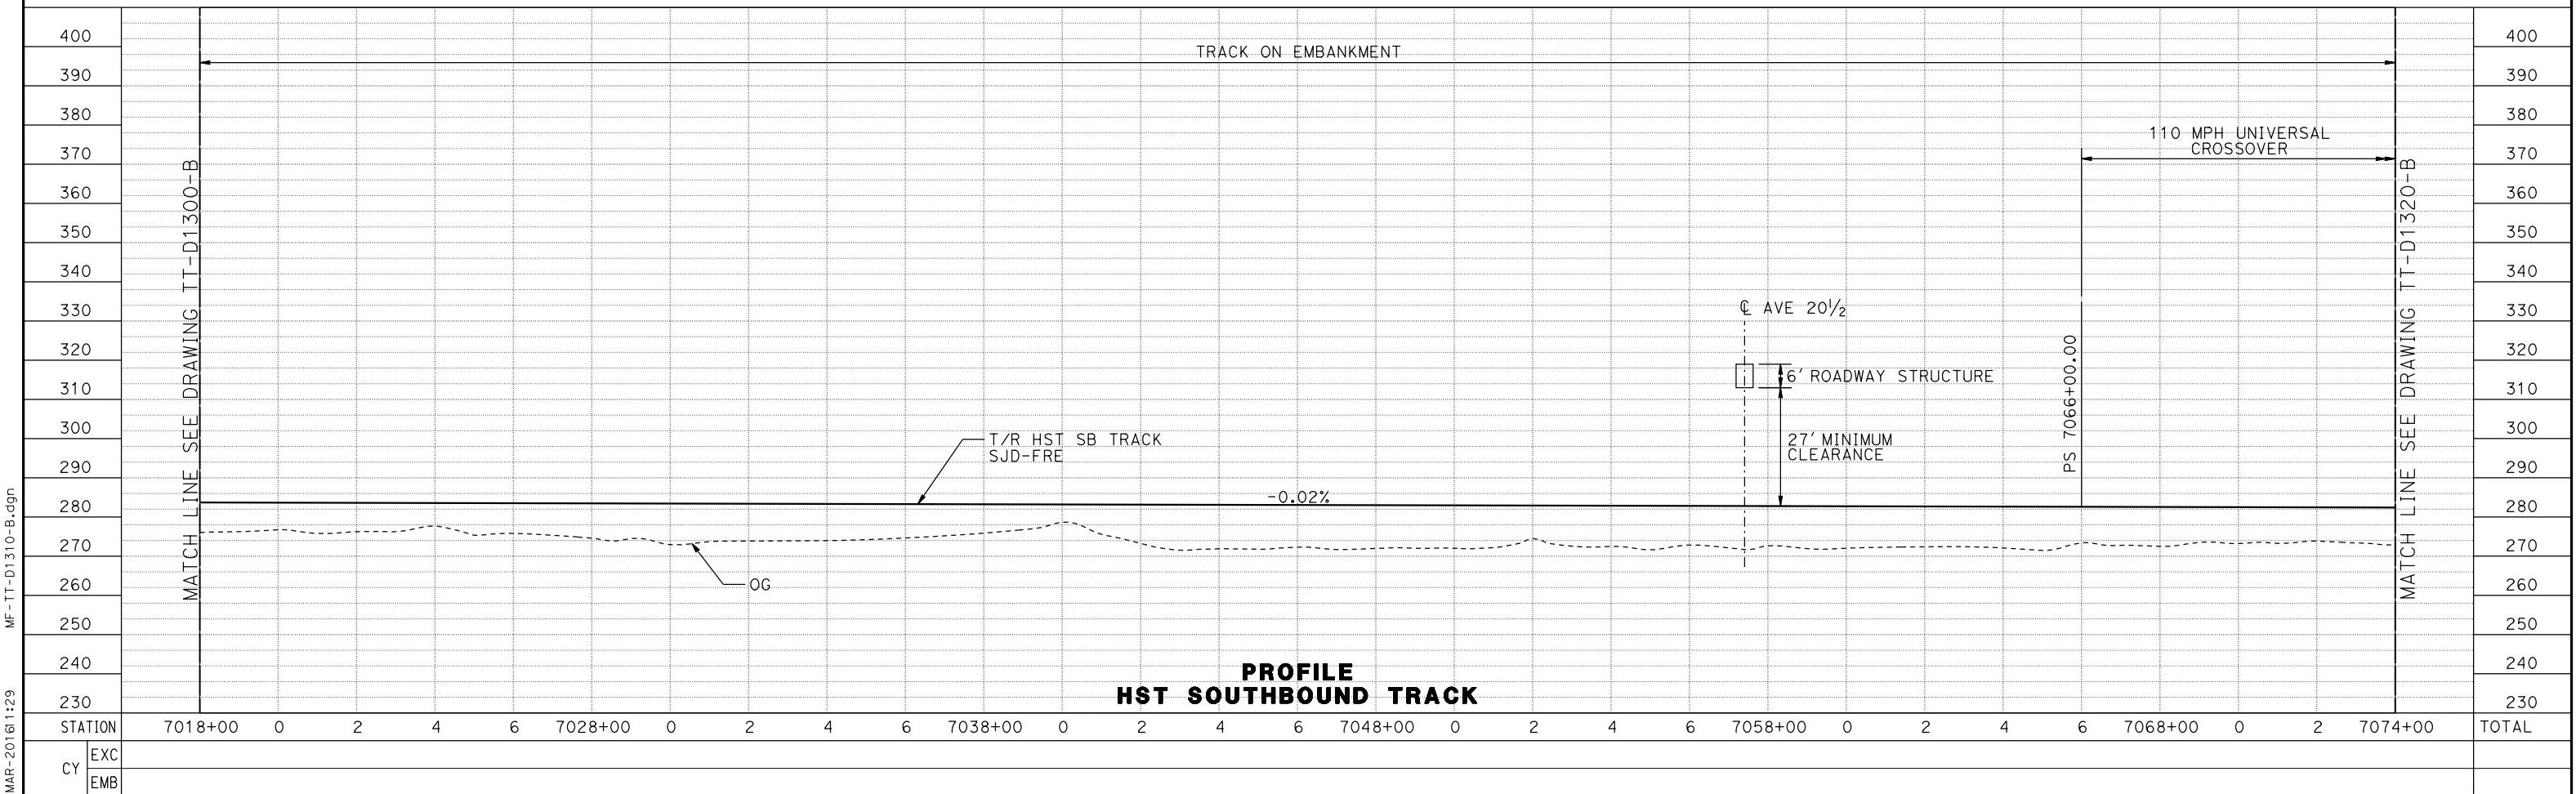


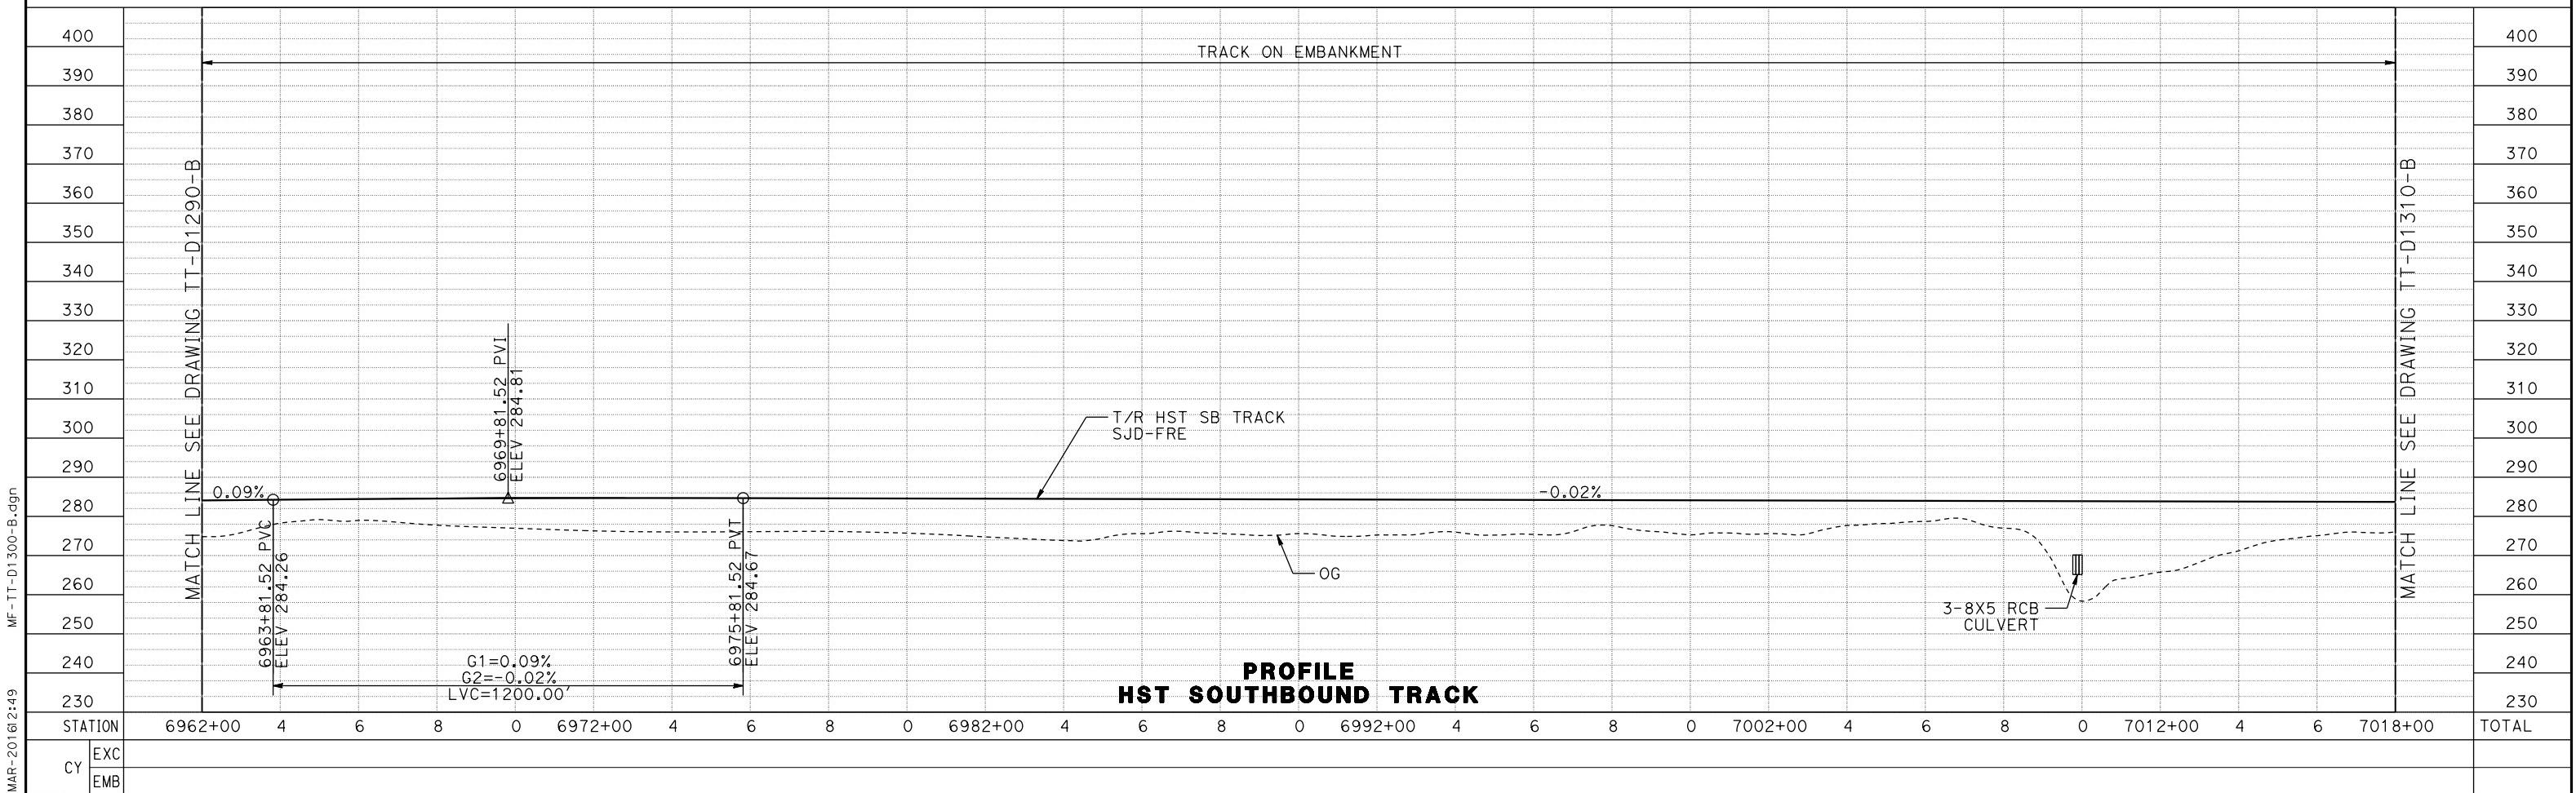08-MAR-2016 2:49					DESIGNED BY D. OLIVETI	RECORD SET 15% DESIGN SUBMITTAL	 PARSONS	 CALIFORNIA HIGH-SPEED RAIL AUTHORITY	CALIFORNIA HIGH-SPEED TRAIN PROJECT MERCED TO FRESNO SECTION	CONTRACT NO. HSR08-05	
p0042226					DRAWN BY S. WILSON				CENTRAL VALLEY WYE	DRAWING NO. TT-D1300-B	
					CHECKED BY N. OUM				SR 152 (NORTH) TO ROAD 19 WYE ALTERNATIVE	SCALE AS SHOWN	
					IN CHARGE C. LEMLEY				TRACK PLAN AND PROFILE	SHEET NO. 000	
					DATE 03/18/2016	NOT FOR CONSTRUCTION			SJD-FRE STA 6962+00 TO 7018+00		
REV	DATE	BY	CHK	APP	DESCRIPTION						

MADERA COUNTY

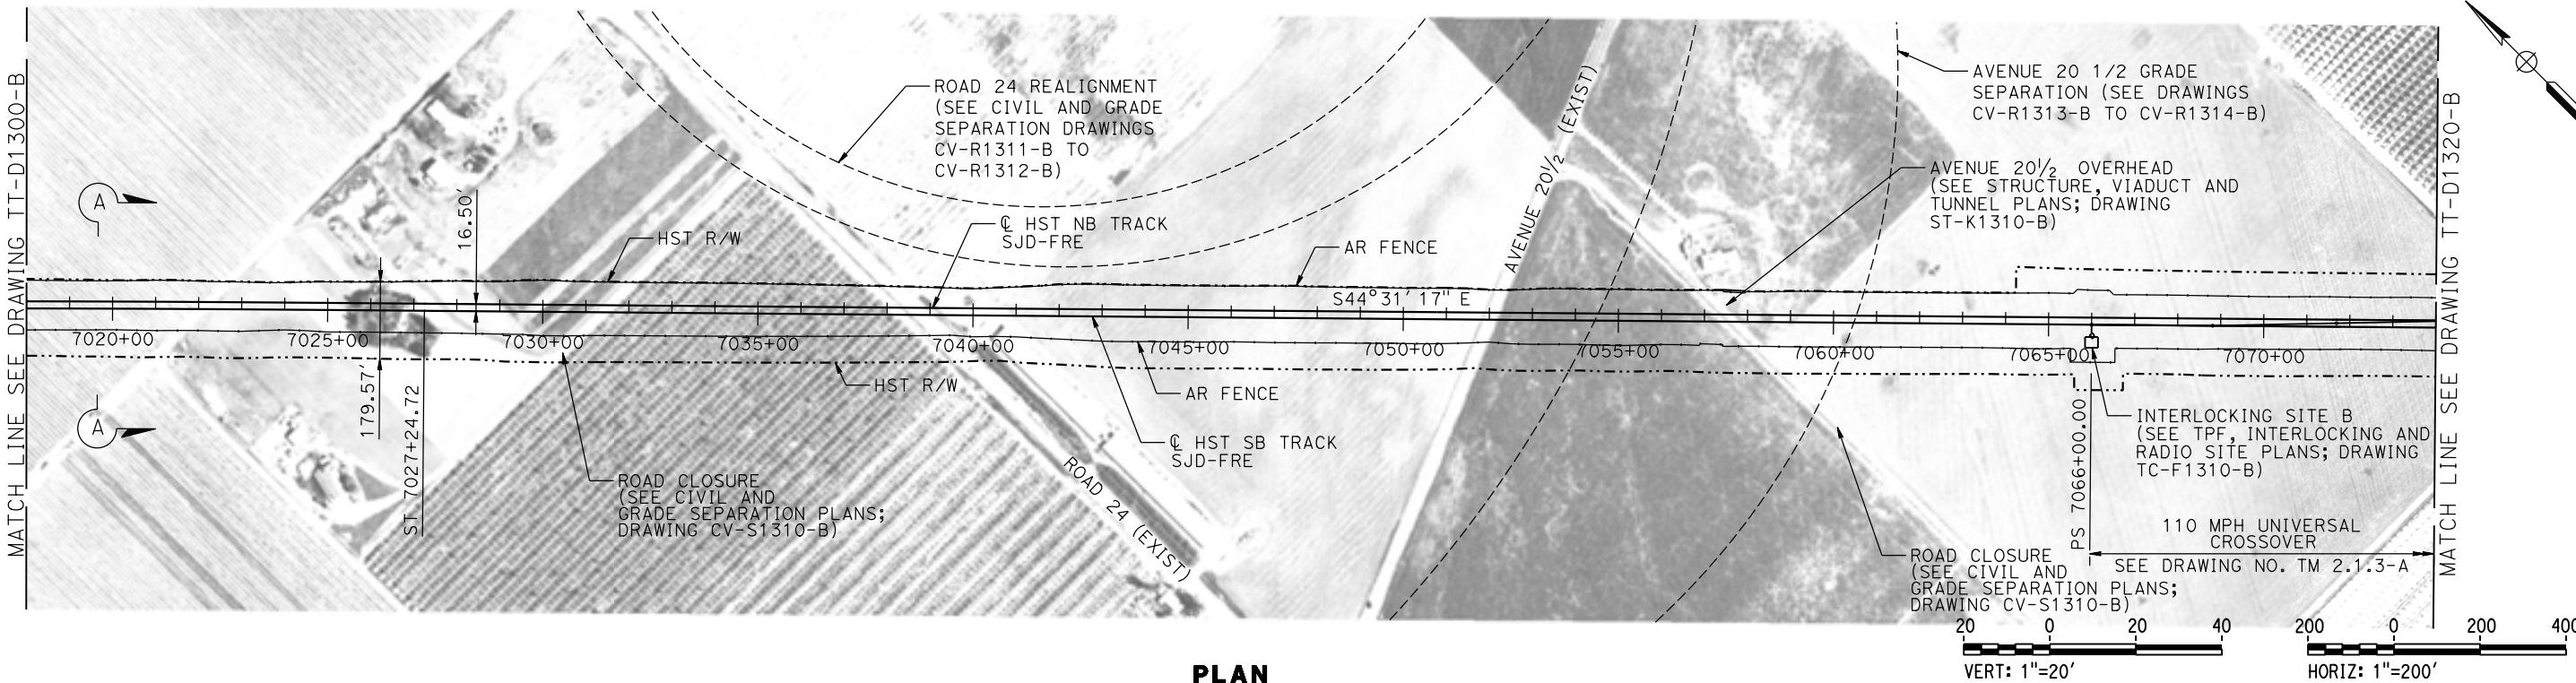

PLAN



DESIGNED BY D. OLIVETI	RECORD SET 15% DESIGN SUBMITTAL	CONTRACT NO. HSR08-05
DRAWN BY S. WILSON		DRAWING NO. TT-D1310-B
CHECKED BY N. OUM		SCALE AS SHOWN
IN CHARGE C. LEMLEY		SHEET NO. 0001
DATE 03/18/2016	NOT FOR CONSTRUCTION	
REV DATE BY CHK APP	DESCRIPTION	

17-MAR-2016 1:29

p00513A



**CALIFORNIA HIGH-SPEED TRAIN PROJECT
MERCED TO FRESNO SECTION**

CENTRAL VALLEY WYE
SR 152 (NORTH) TO ROAD 19 WYE ALTERNATIVE
TRACK PLAN AND PROFILE
SJD-FRE STA 7018+00 TO 7074+00


PARSONS

CALIFORNIA
HIGH-SPEED RAIL AUTHORITY

MADERA COUNTY

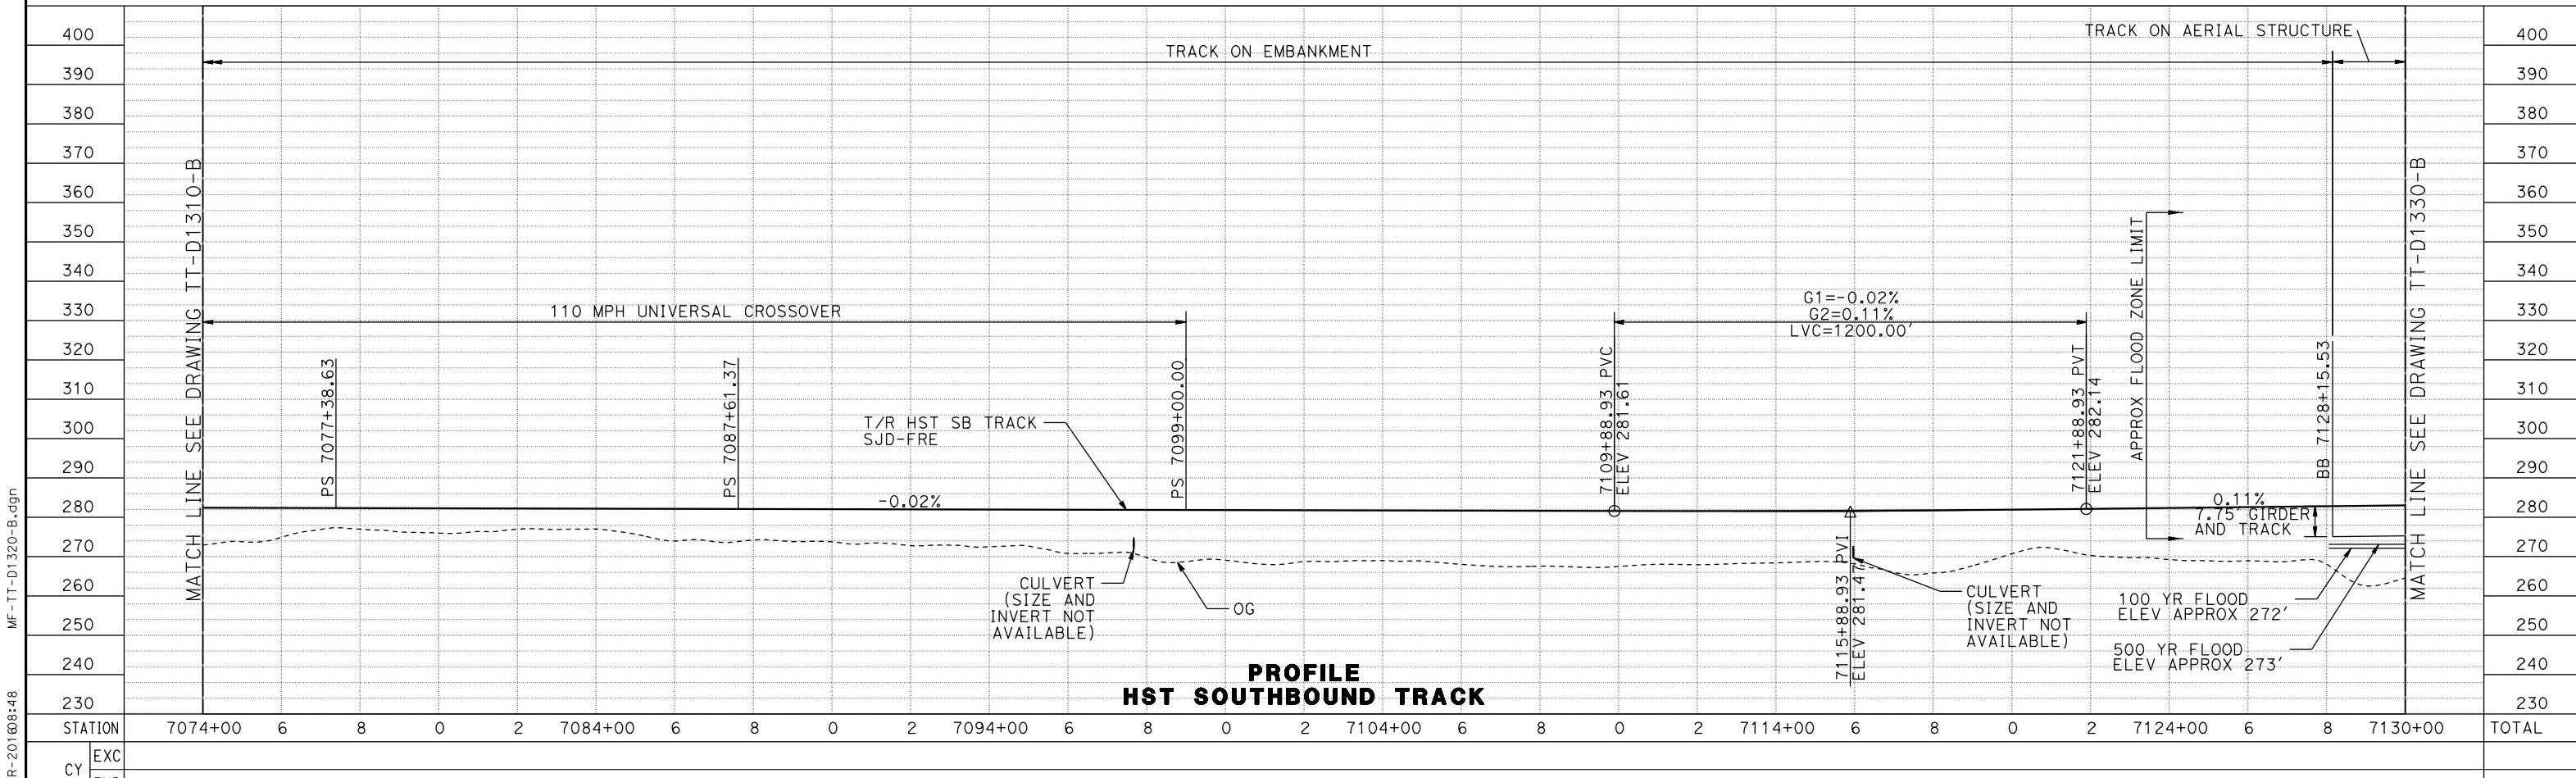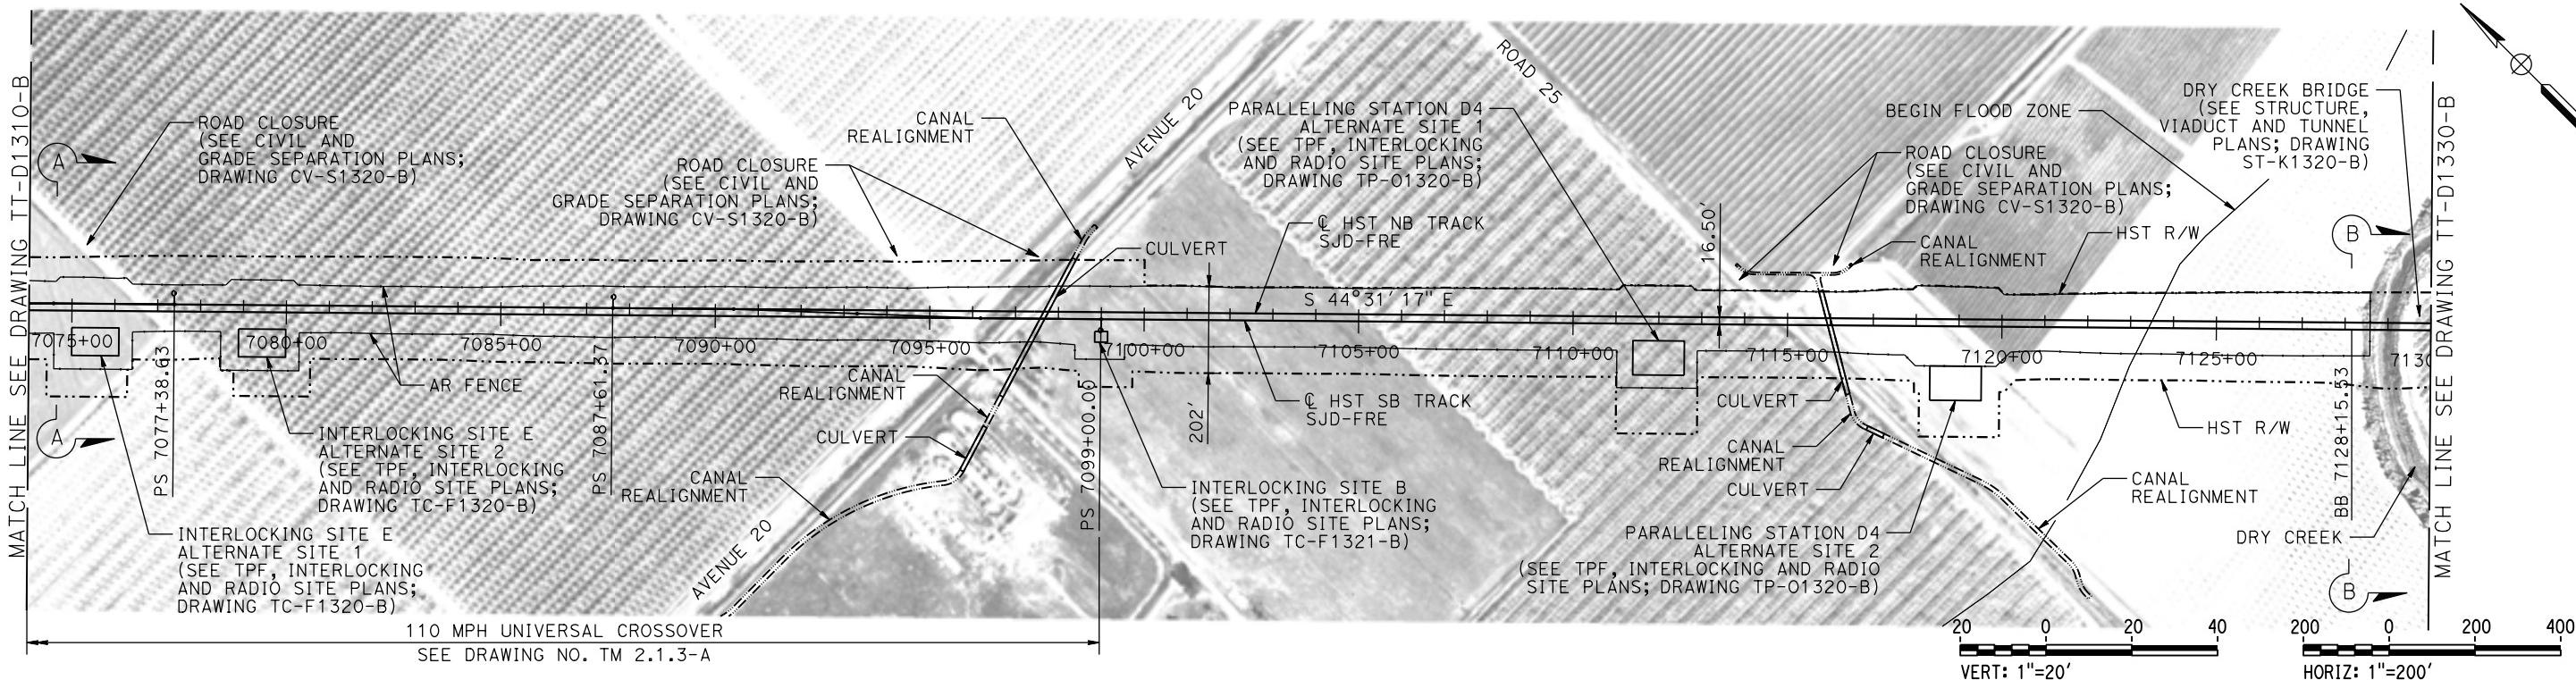


MADERA COUNTY

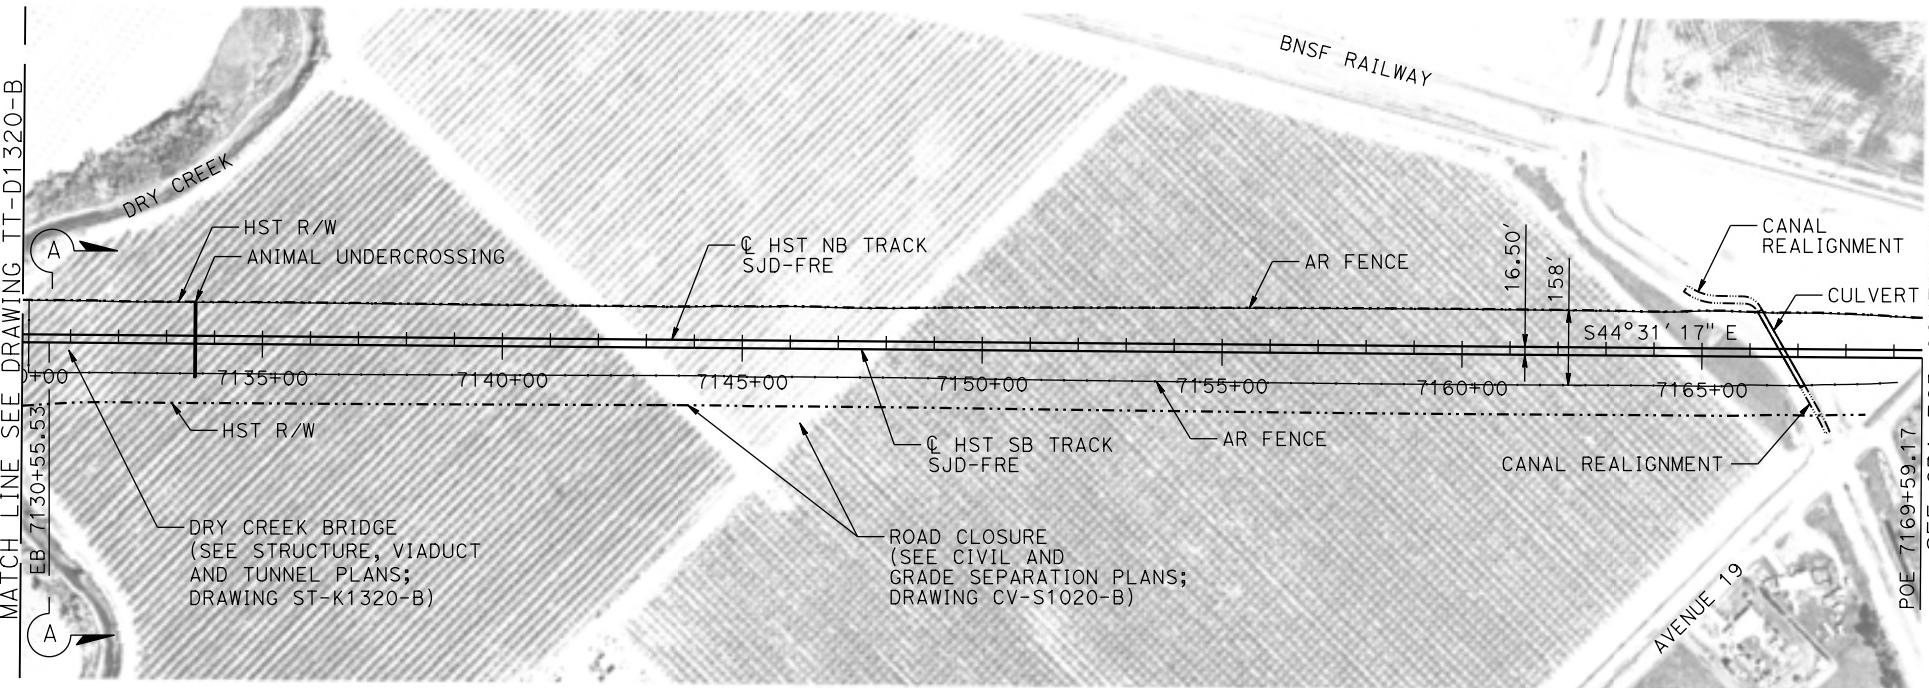


PLAN



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200 0 200 400
VERT: 1"=20' HORIZ: 1"=200'

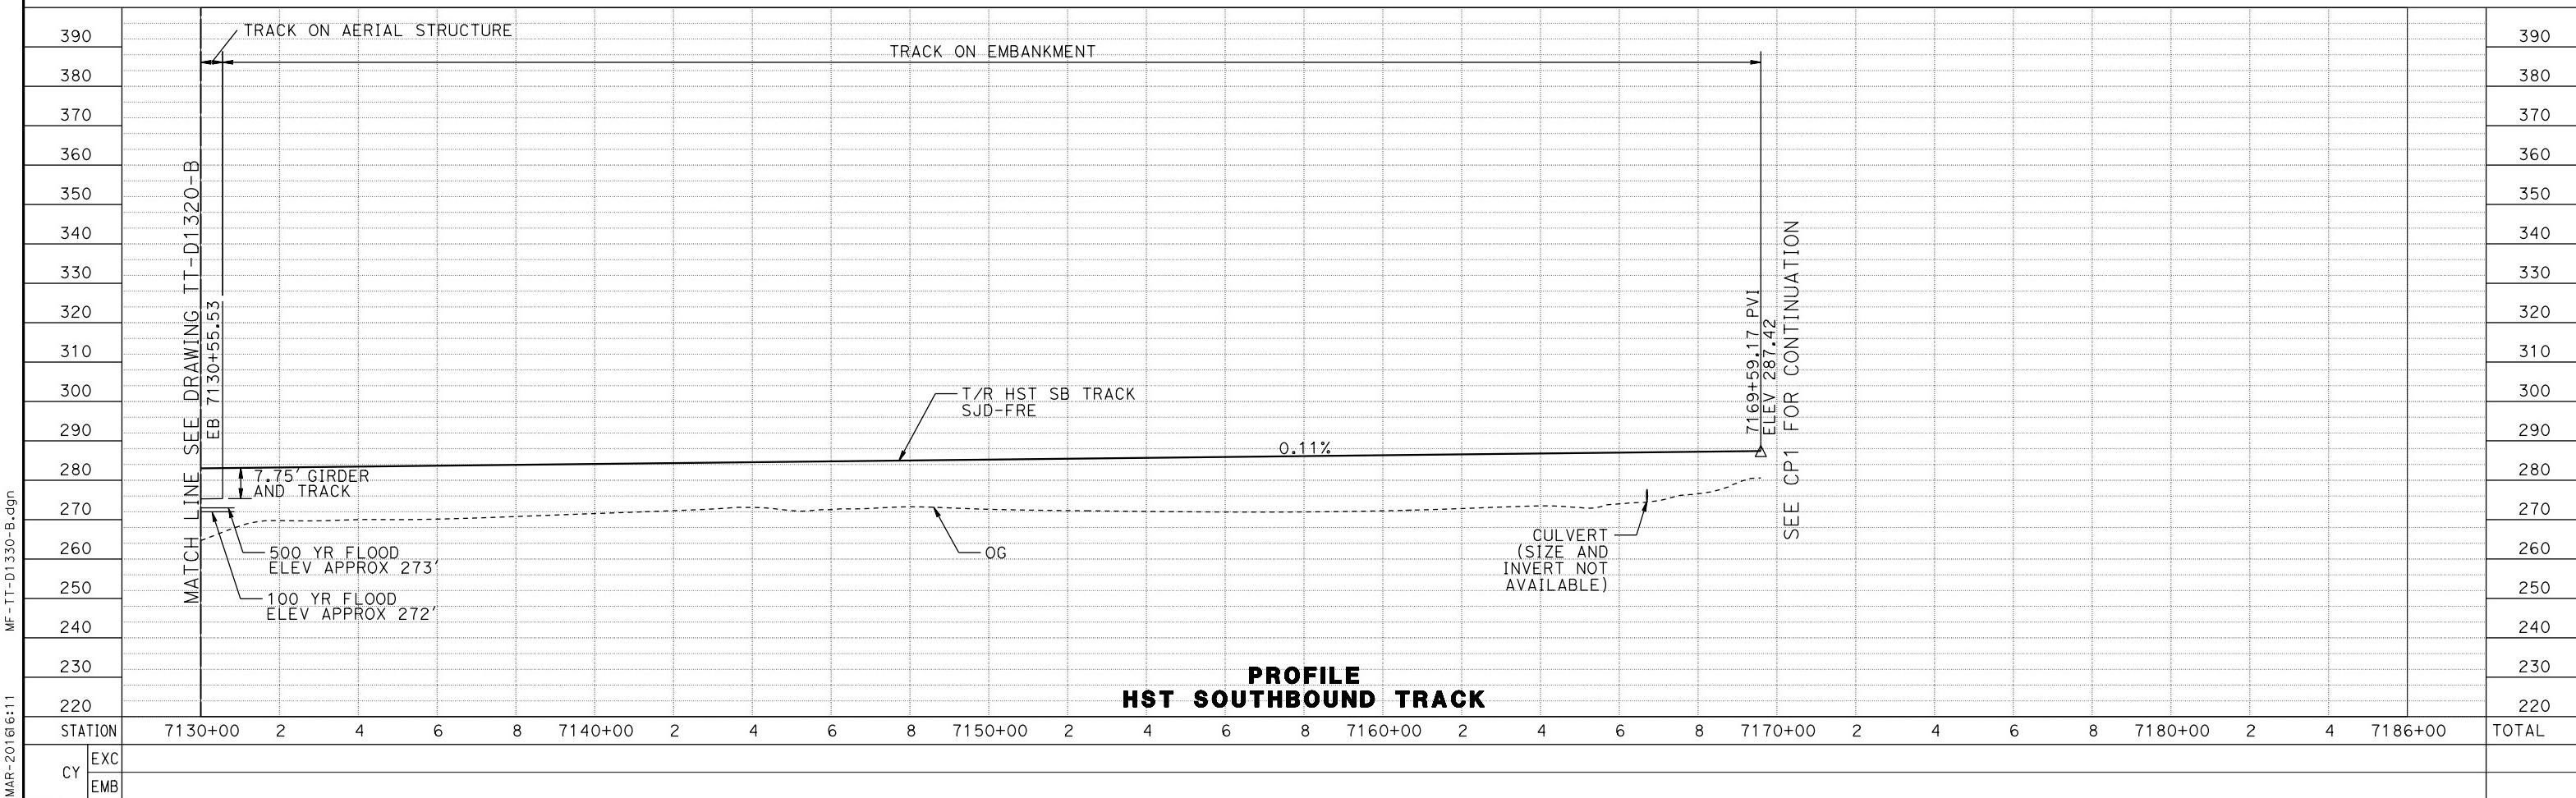


DESIGNED BY D. OLIVETI	RECORD SET 15% DESIGN SUBMITTAL	CONTRACT NO. HSR08-05
DRAWN BY S. WILSON	NOT FOR CONSTRUCTION	DRAWING NO. TT-D1330-B
CHECKED BY N. OUM		SCALE AS SHOWN
IN CHARGE C. LEMLEY		SHEET NO.
DATE 03/18/2016		
REV DATE BY CHK APP	DESCRIPTION	CALIFORNIA HIGH-SPEED TRAIN PROJECT MERCED TO FRESNO SECTION CENTRAL VALLEY WYE SR 152 (NORTH) TO ROAD 19 WYE ALTERNATIVE TRACK PLAN AND PROFILE SJD-FRE STA 7130+00 TO 7169+59.17



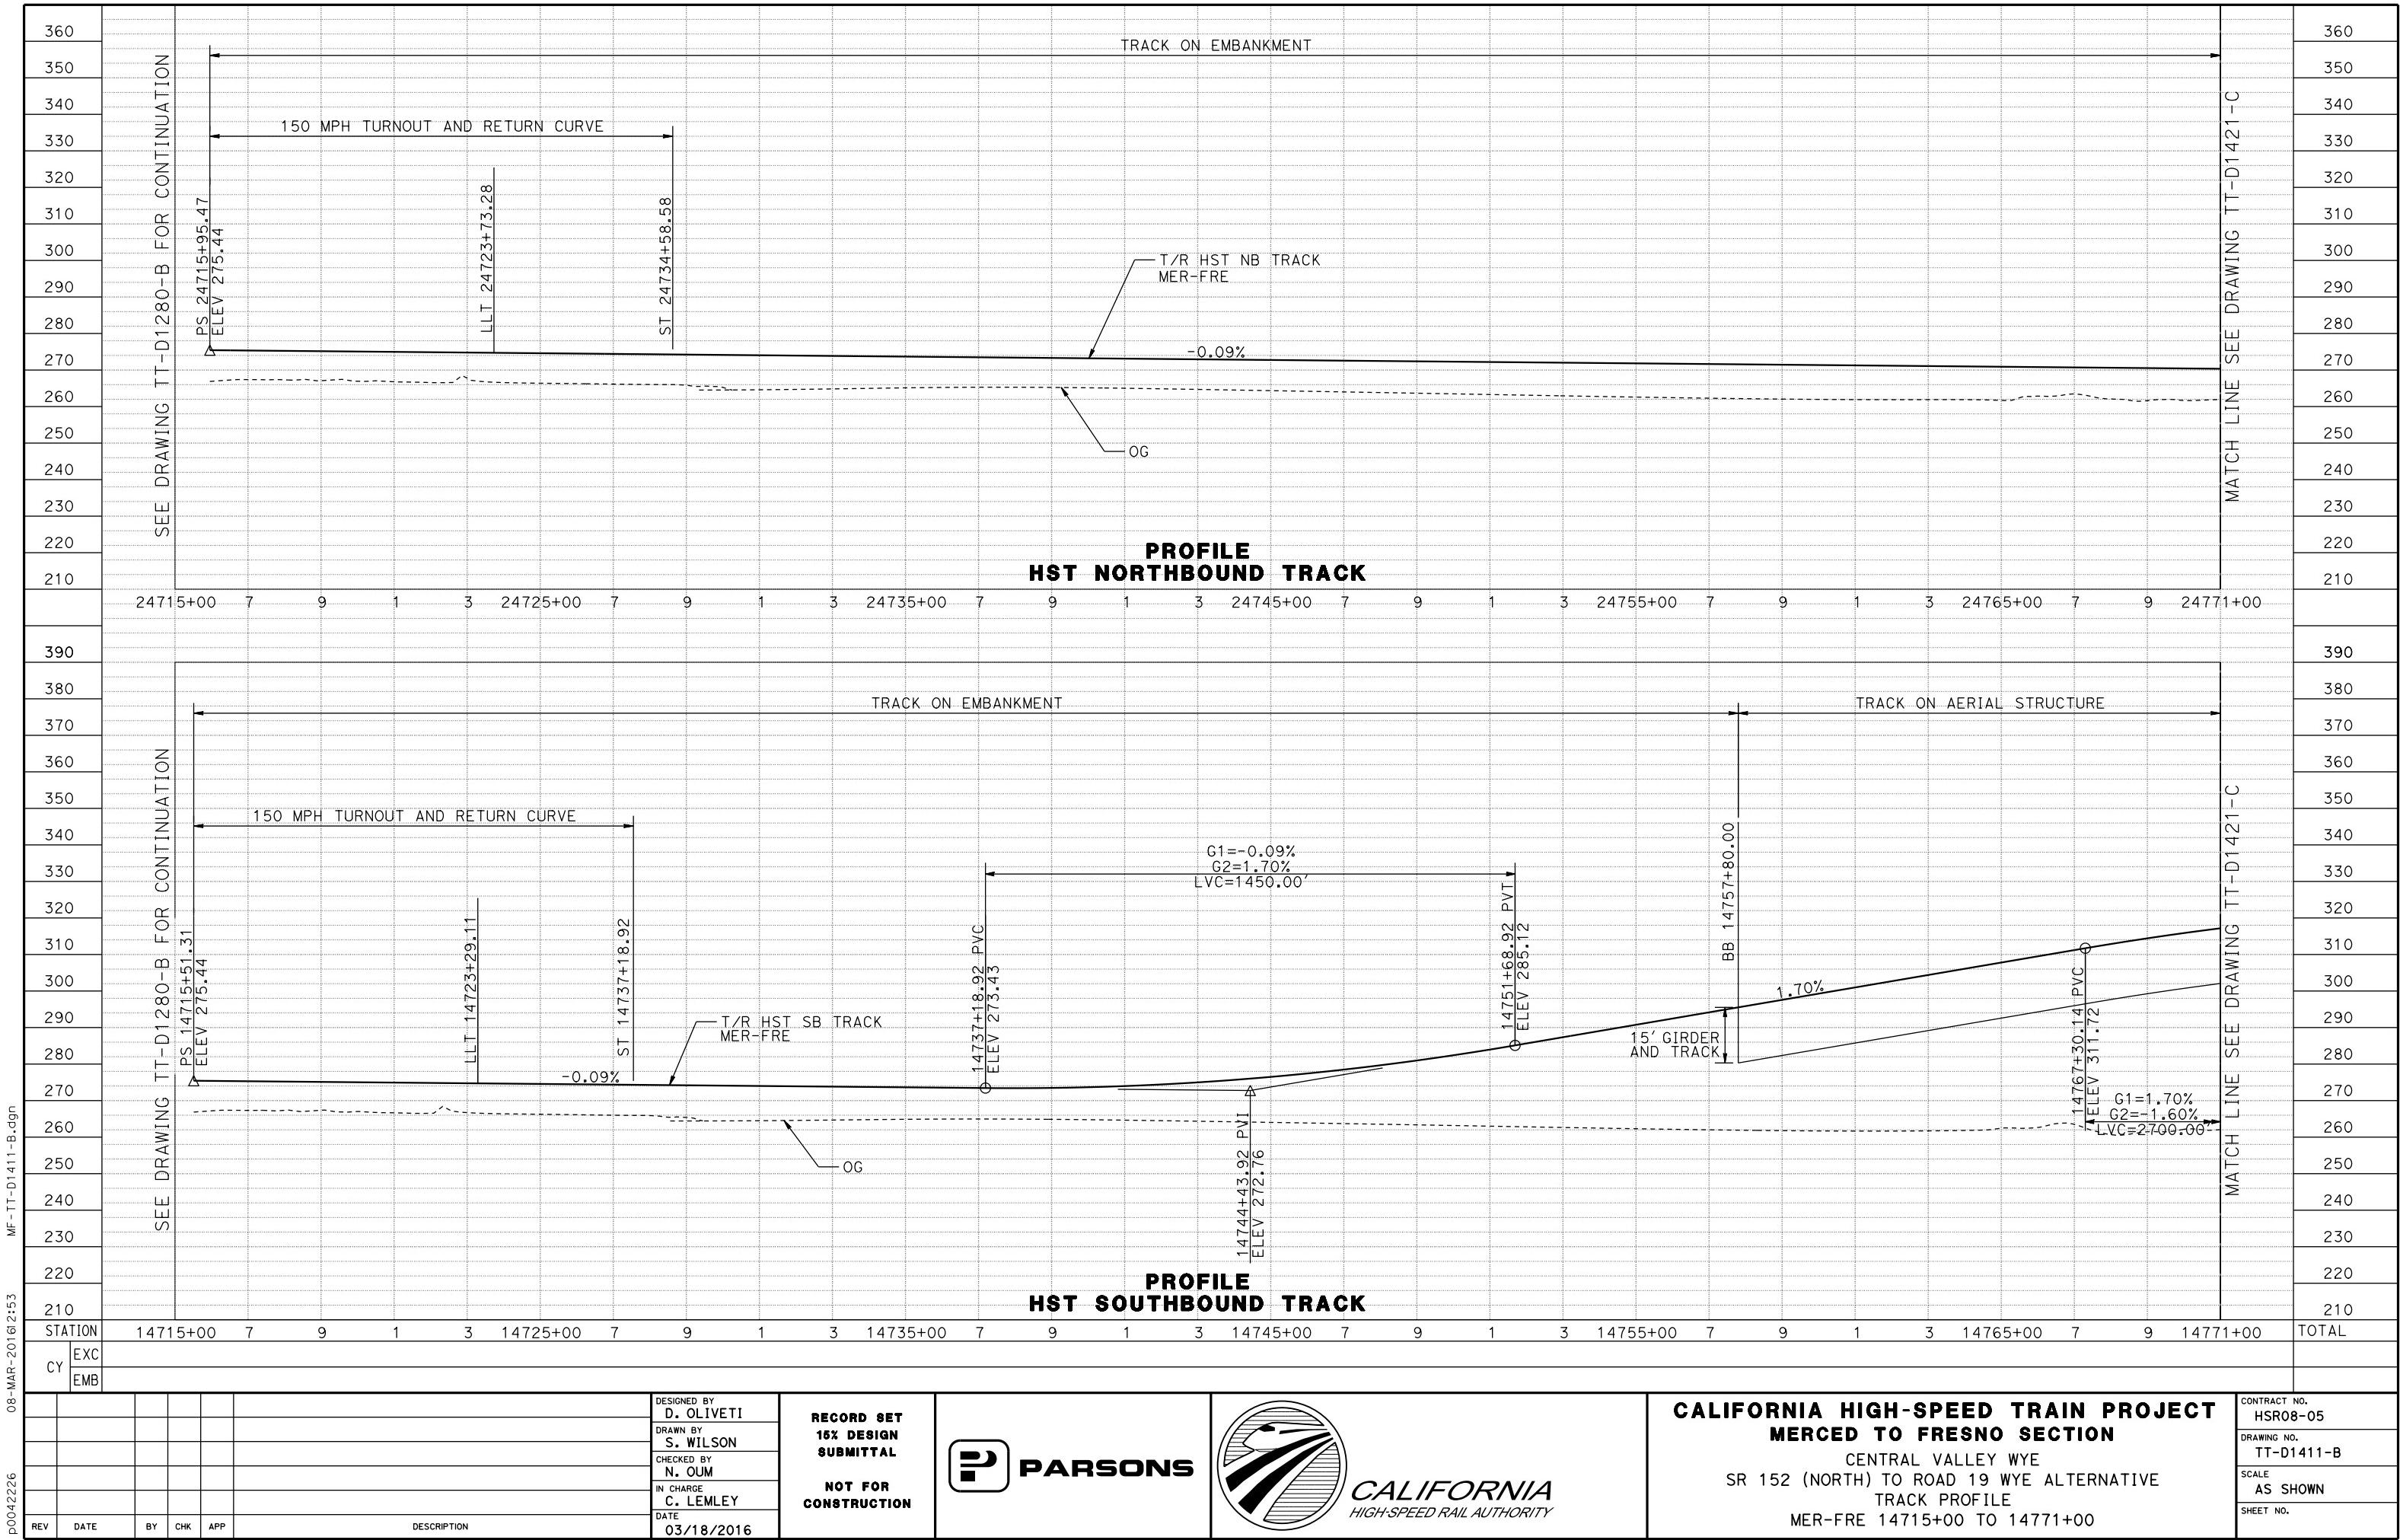

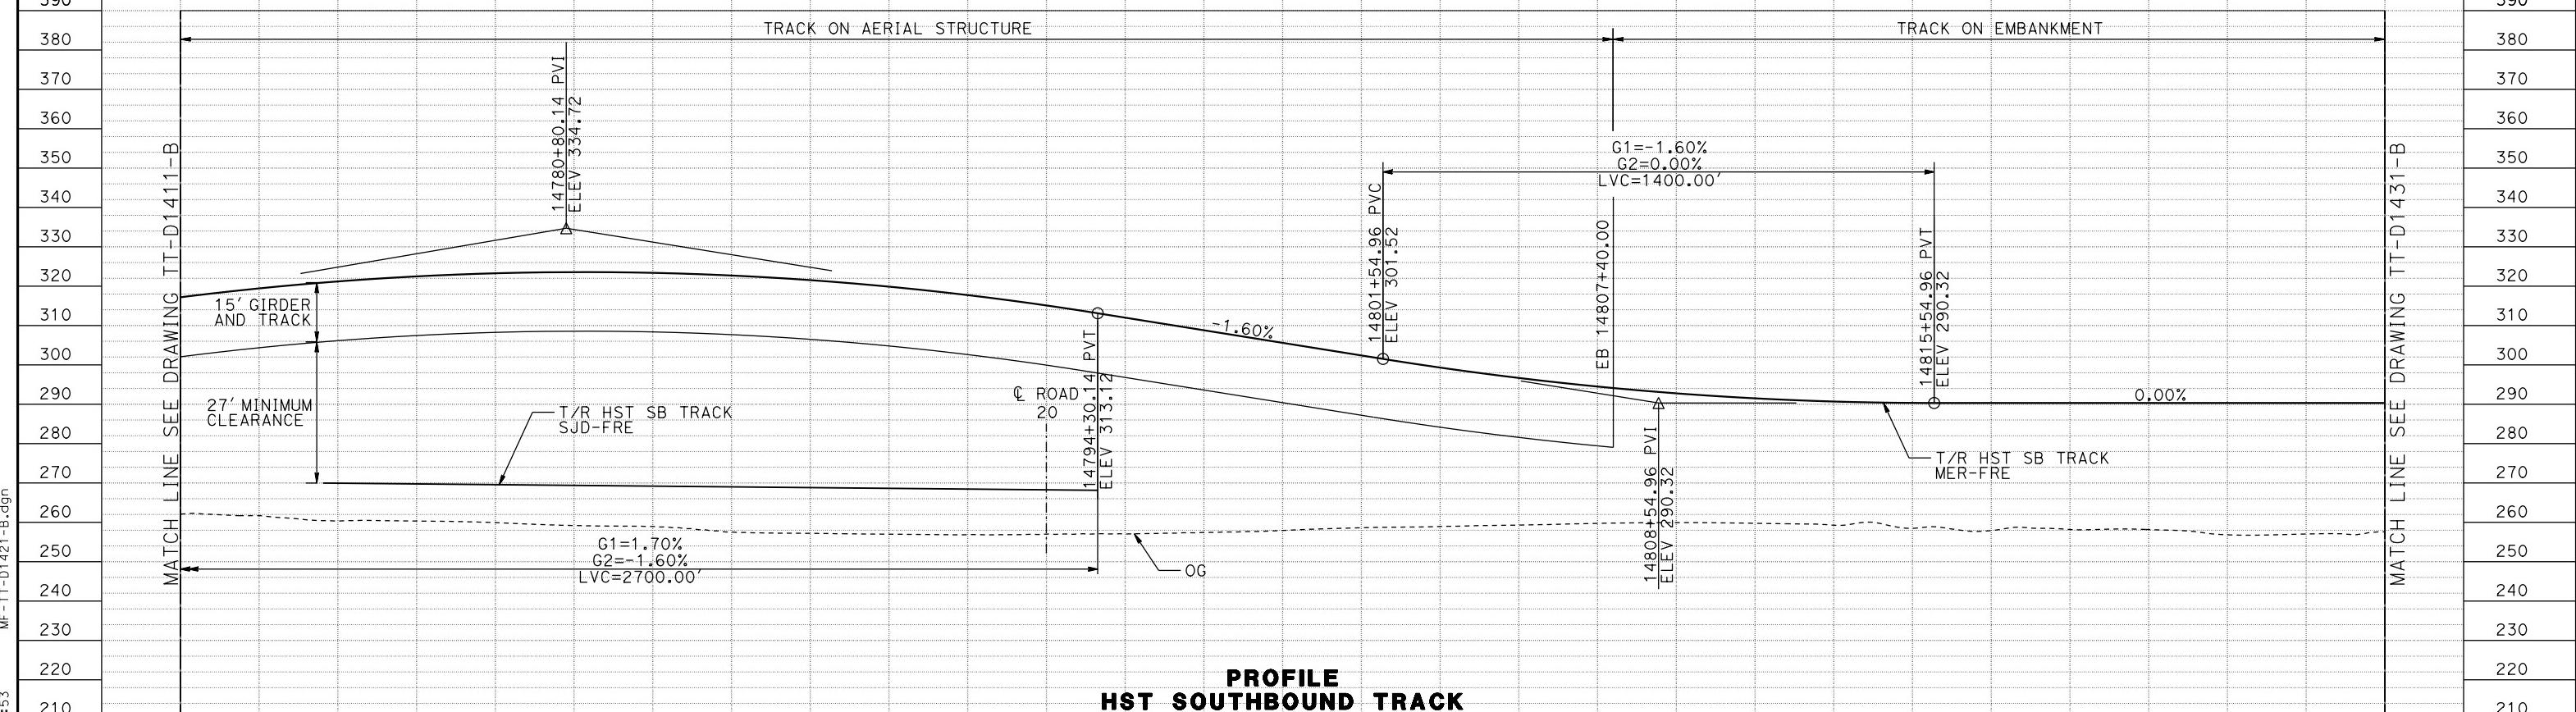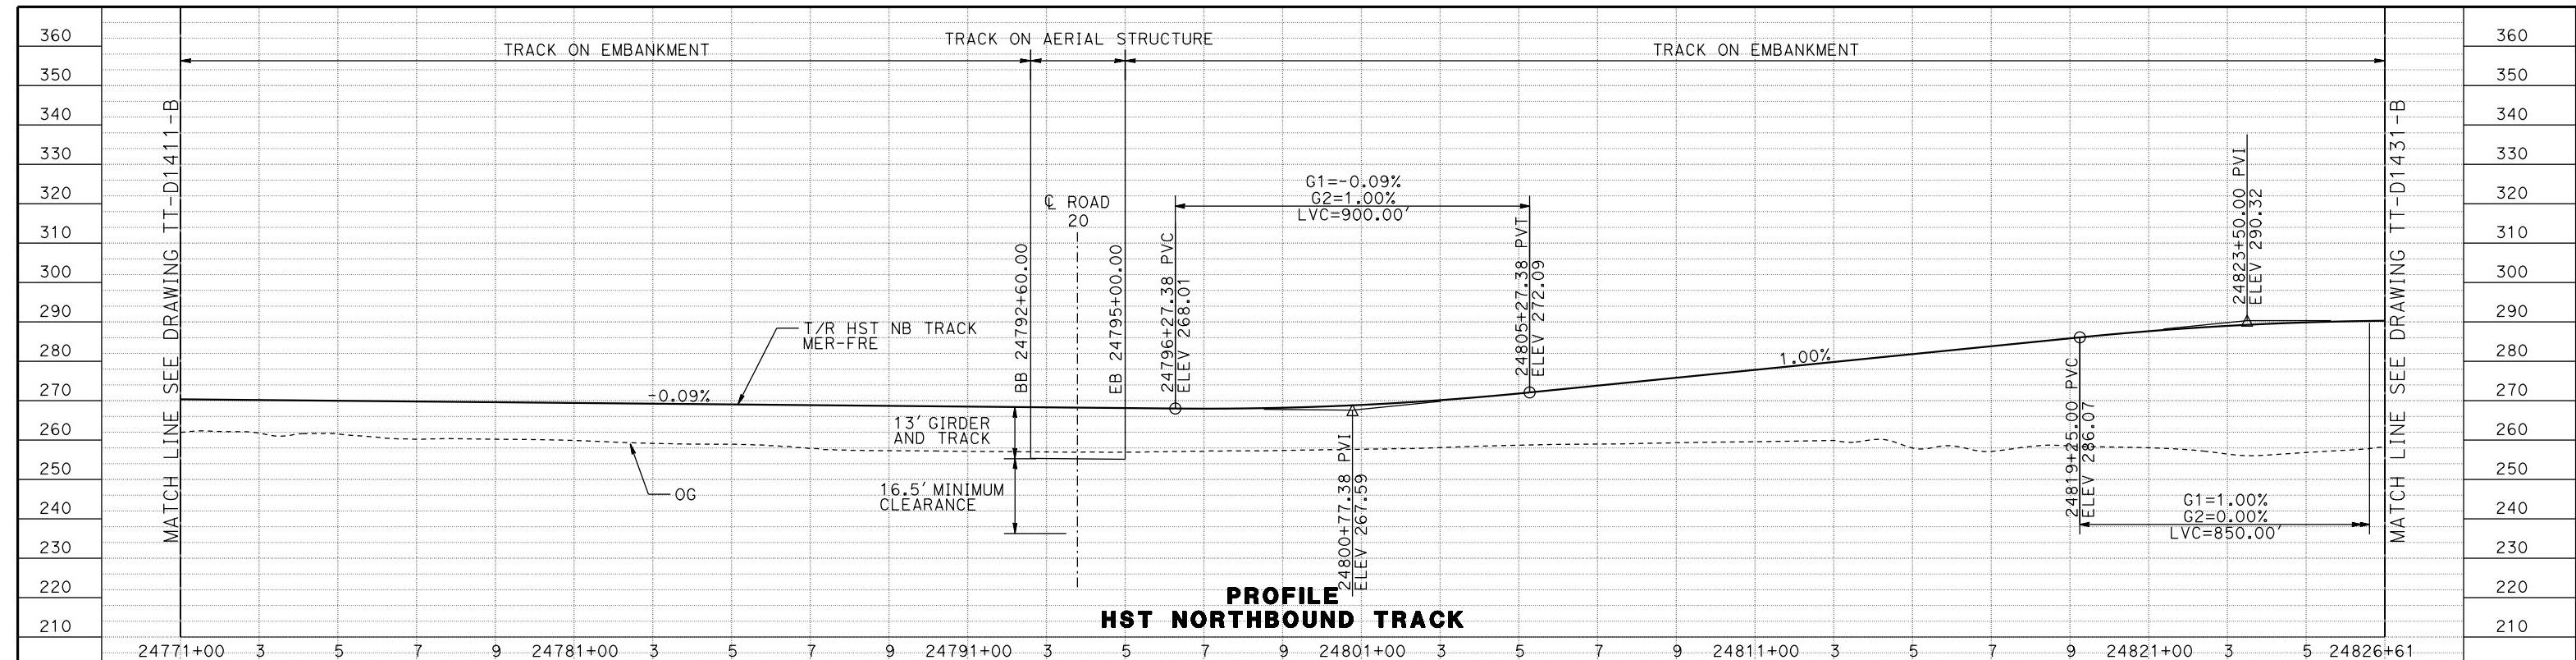

MADERA COUNTY

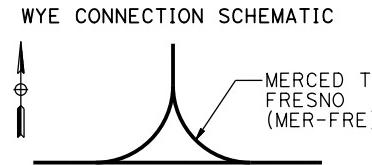


MATCH LINE SEE DRAWING TT-D1430-B

AVENUE 23 1/2

CURVE MER-FRE 1 SB
V = 150 mph
R = 10300.00
LS = 1200'
EA/EU= 6.00/2.74
MINIMUM

TRAIN CONTROL SITE D4
ALTERNATE SITE 1
(SEE TPF, INTERLOCKING
AND RADIO SITE PLANS;
DRAWING TC-F1430-B)

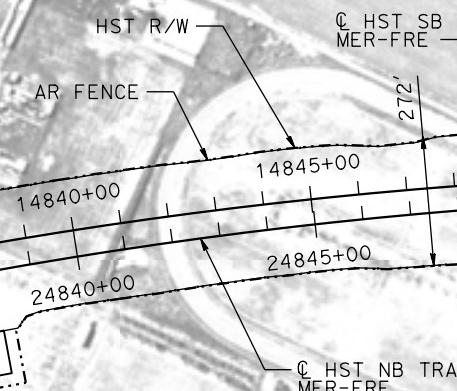

CURVE MER-FRE 1 NB
V = 150 mph
R = 10300.00
LS = 1200'
EA/EU= 6.00/2.74
MINIMUM

SWITCHING STATION E
ALTERNATE SITE 2
(SEE TPF, INTERLOCKING
AND RADIO SITE PLANS;
DRAWING TP-01430-B)

MADISON ROAD
(AVENUE 23 1/2)
UNDERPASS (SEE
STRUCTURE, VIADUCT
AND TUNNEL PLANS;
DRAWING ST-K1430-B)

PLAN

MF-TT-D1430-B.dwg

10-MAR-2016 6:13

P0042226

REV	DATE	BY	CHK	APP	DESCRIPTION
					03/18/2016

DESIGNED BY D. OLIVETI
DRAWN BY S. WILSON
CHECKED BY N. OUM
IN CHARGE C. LEMLEY
DATE 03/18/2016

RECORD SET
1% DESIGN
SUBMITTAL
**NOT FOR
CONSTRUCTION**





CALIFORNIA
HIGH-SPEED RAIL AUTHORITY

CALIFORNIA HIGH-SPEED TRAIN PROJECT MERCED TO FRESNO SECTION

CENTRAL VALLEY WYE
SR 152 (NORTH) TO ROAD 19 WYE ALTERNATIVE
TRACK PLAN
MER-FRE 14827+00 TO 14883+00

CONTRACT NO.
HSR08-05
DRAWING NO.
TT-D1430-B
SCALE
AS SHOWN
SHEET NO.

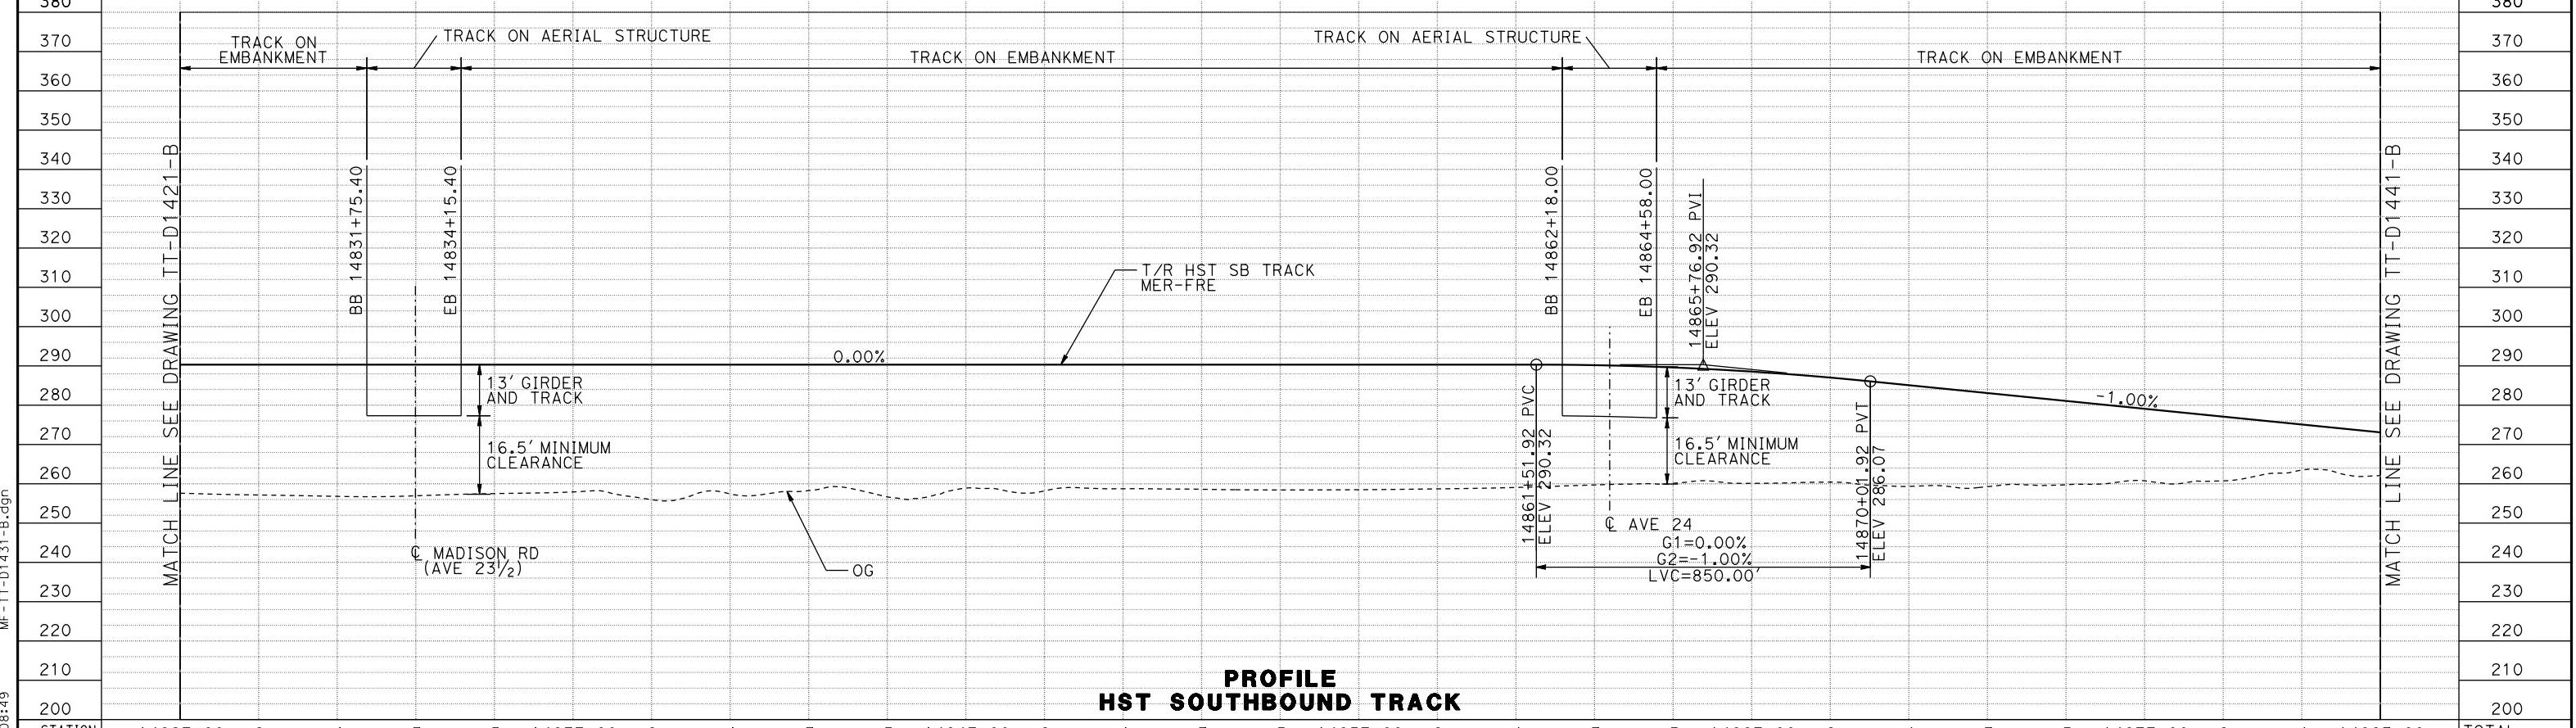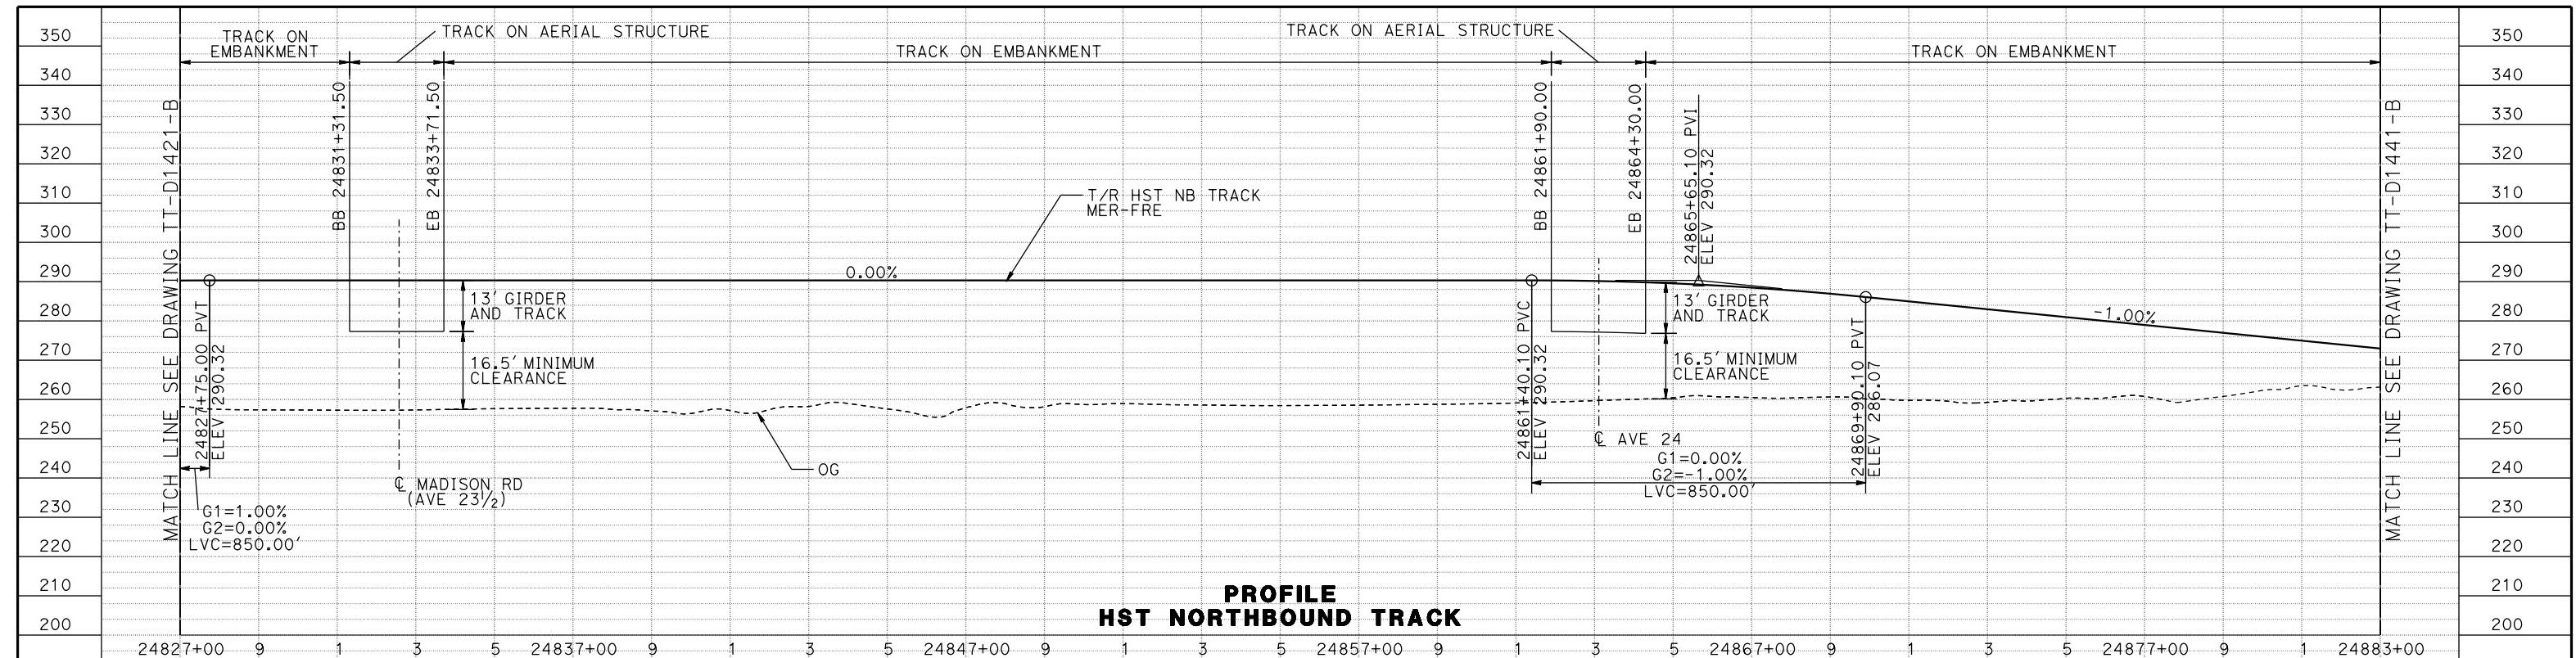

IE = TT = D1131 = B dan

2-MAB-2018-10

00042

	DESIGNED BY D. OLIVET
	DRAWN BY S. WILSON
	CHECKED BY N. OUM
	IN CHARGE C. LEMLEY
	DATE 03/18/20

**RECORD SET
15% DESIGN
SUBMITTAL**

**NOT FOR
CONSTRUCTION**



PARSONS



CALIFORNIA HIGH-SPEED RAIL AUTHORITY

PROFILE HST SOUTHBOUND TRACK


PROFILE HST NORTHBOUND TRACK

CALIFORNIA HIGH-SPEED TRAIN PROJECT MERCED TO FRESNO SECTION

MERGED TO FREIGHT SECTION
CENTRAL VALLEY WYE
SR 152 (NORTH) TO ROAD 19 WYE ALTERNATIVE
TRACK PROFILE
MER-FRE 14827+00 TO 14833+00

TRACT NO.
HSR08-05
AWING NO.
TT-D1431-B
ALE
AS SHOWN
ET NO.

MADERA COUNTY

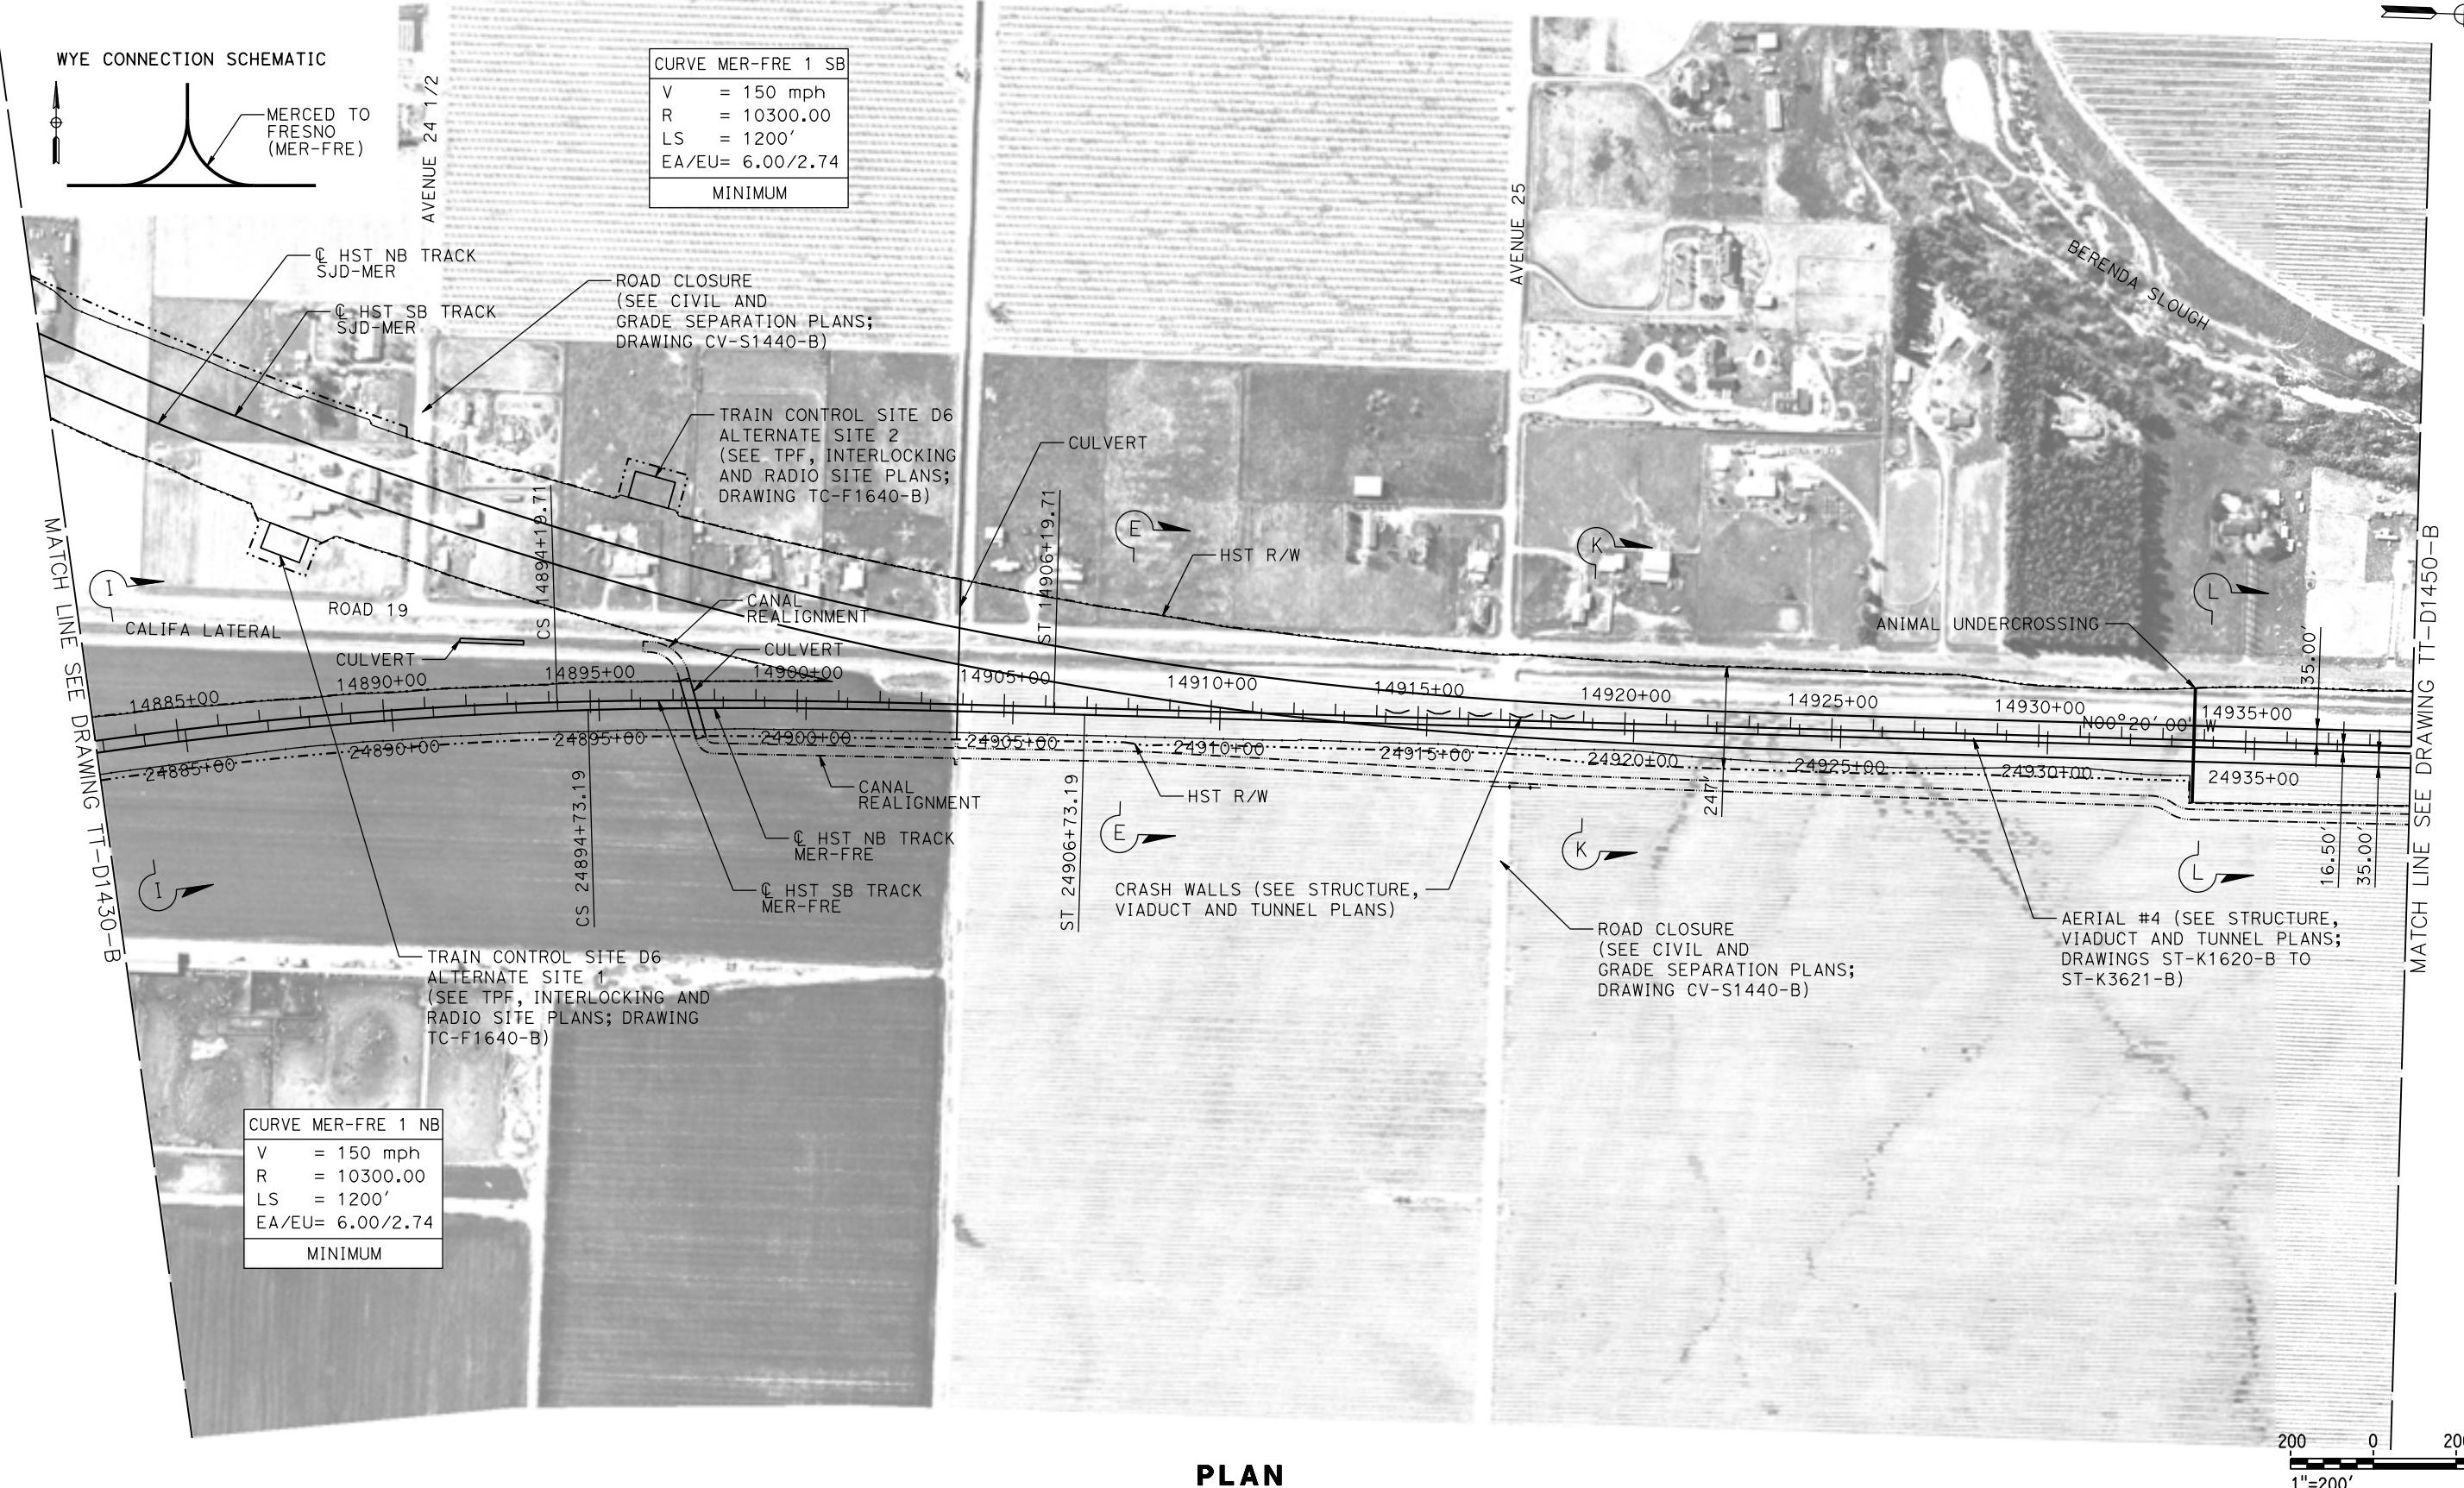

12-MAR-2016 08:49 MF-TT-D1440-B.dwg

REV	DATE	BY	CHK	APP	DESCRIPTION
p0042226					

DESIGNED BY
D. OLIVETI
DRAWN BY
S. WILSON
CHECKED BY
N. OUM
IN CHARGE
C. LEMLEY
DATE
03/18/2016




PARSONS

RECORD SET
15% DESIGN
SUBMITTAL
**NOT FOR
CONSTRUCTION**



CALIFORNIA HIGH-SPEED TRAIN PROJECT
MERCED TO FRESNO SECTION
CENTRAL VALLEY WYE
SR 152 (NORTH) TO ROAD 19 WYE ALTERNATIVE
TRACK PLAN
MER-FRE 14883+00 TO 14939+00

CONTRACT NO.
HSR08-05
DRAWING NO.
TT-D1440-B
SCALE
AS SHOWN
SHEET NO.

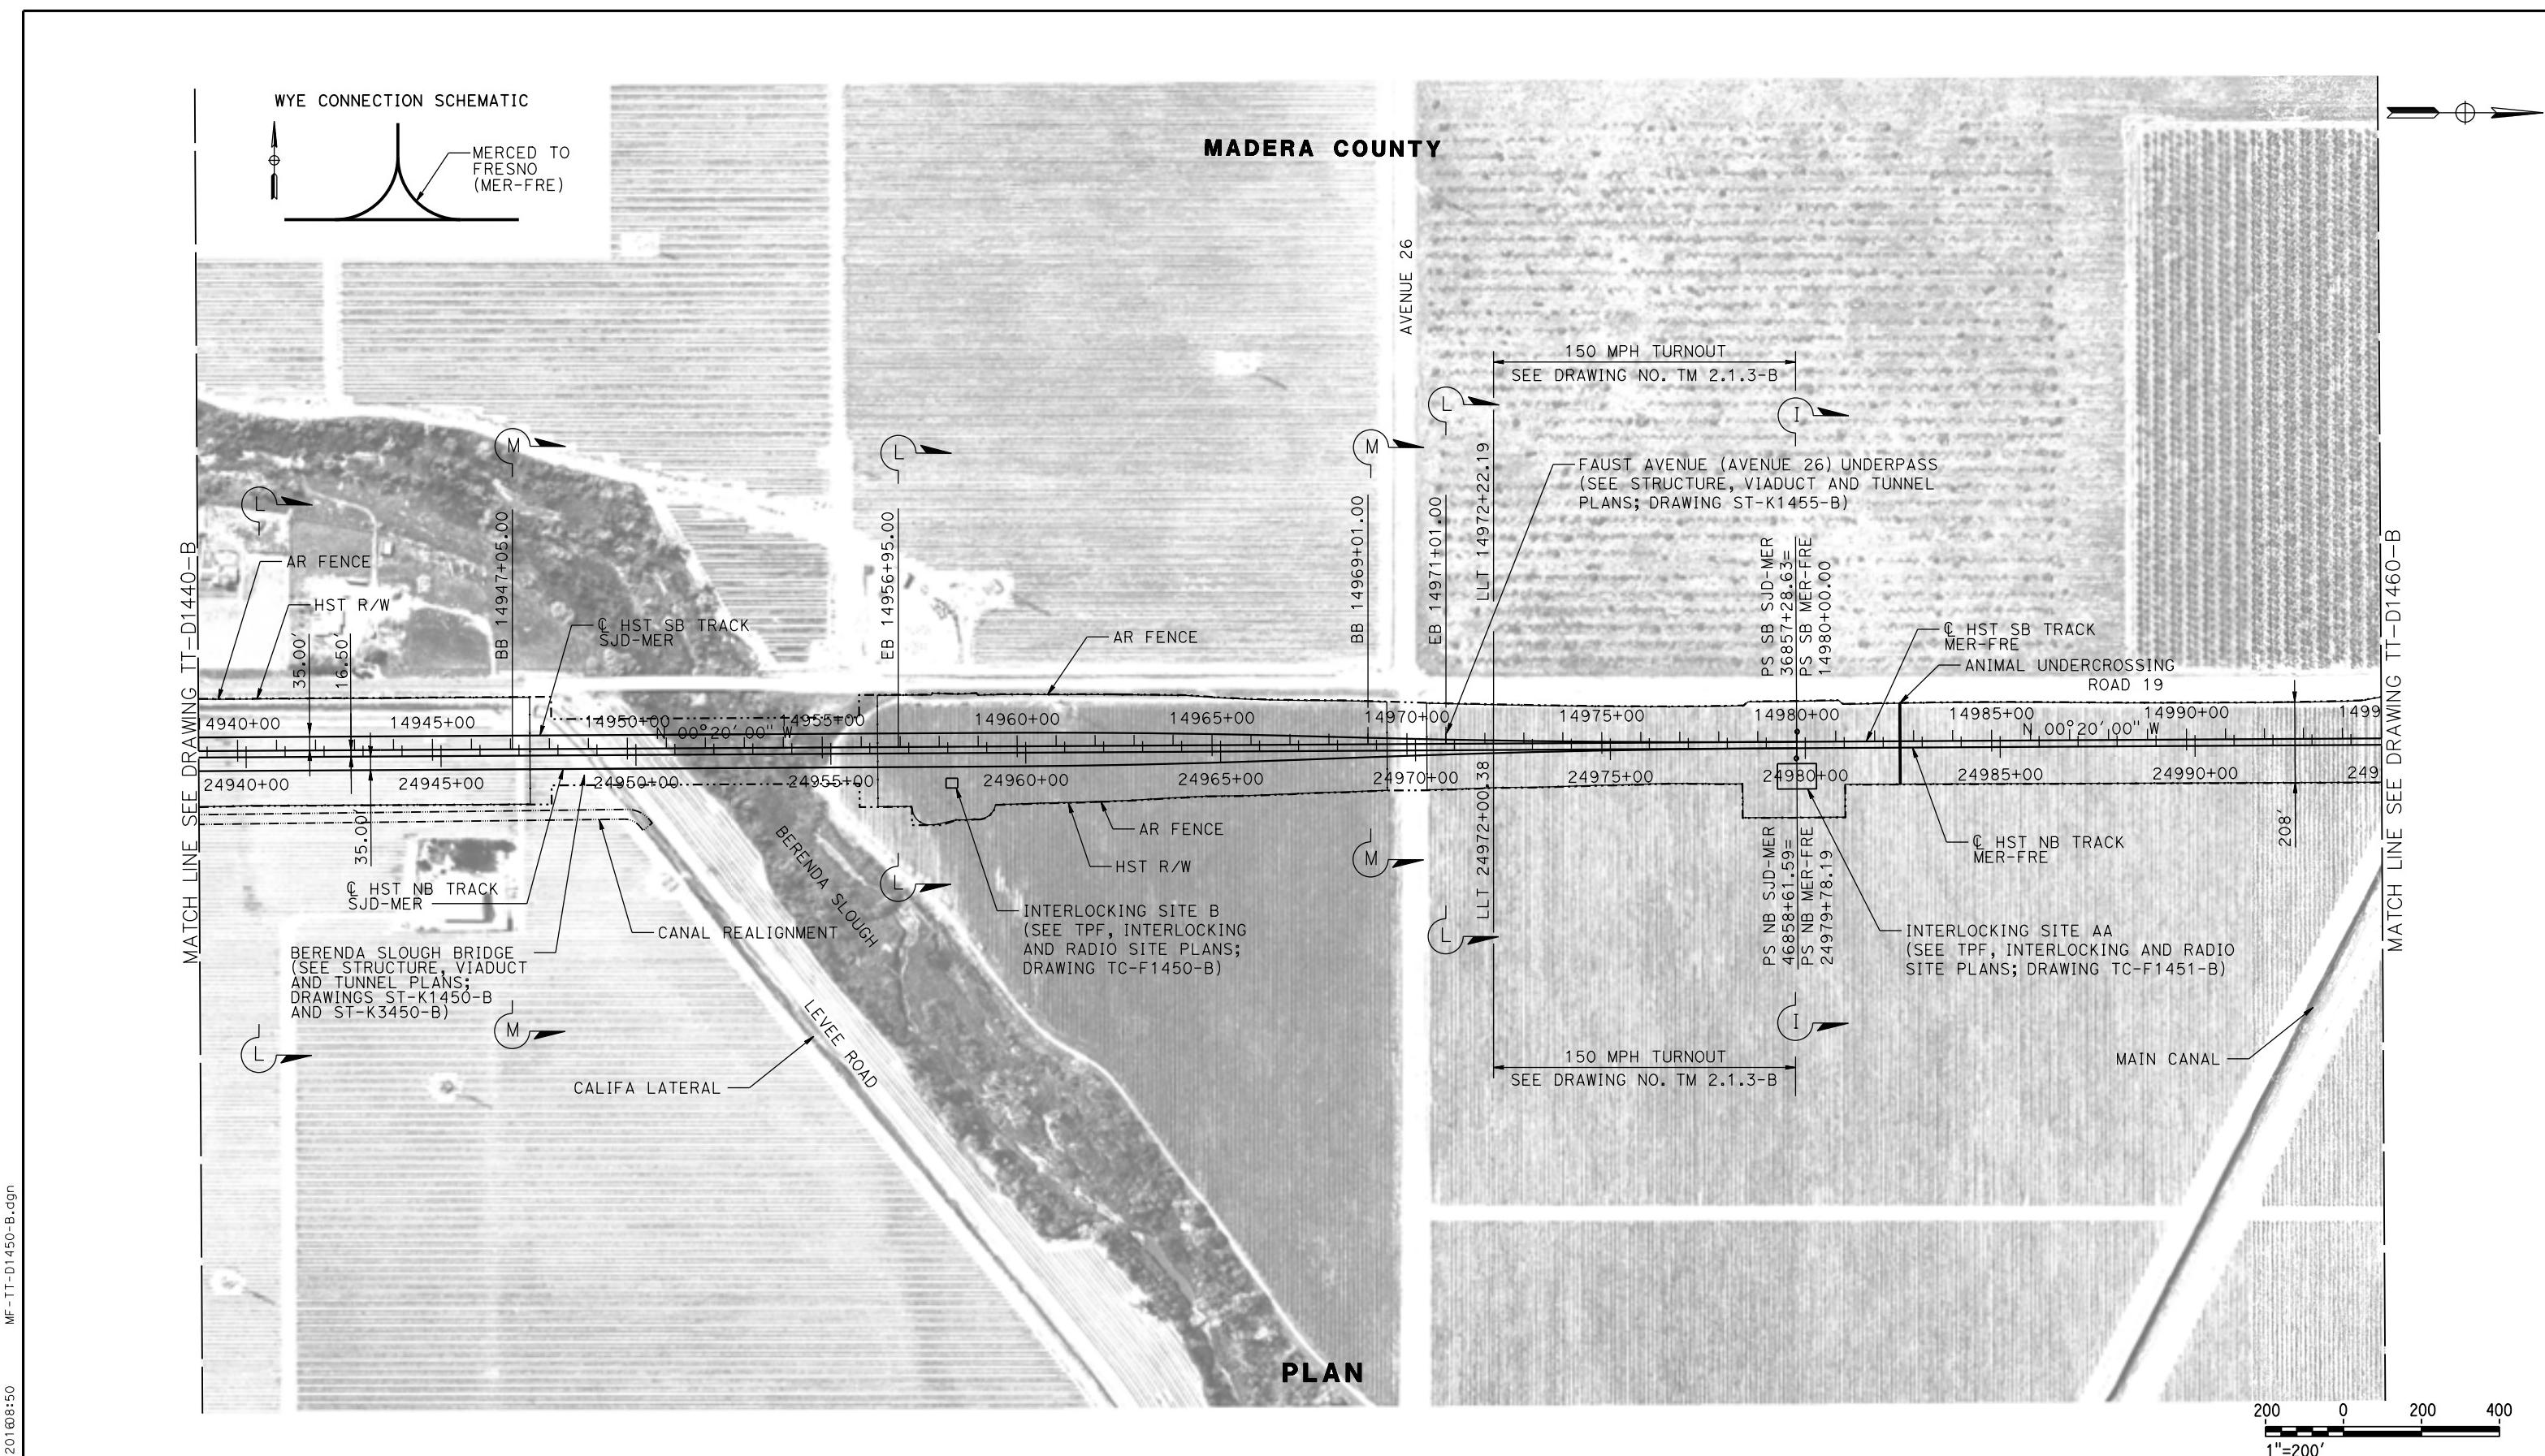

REV	DATE	BY	CHK	APP	DESCRIPTION
p004226					03/18/2016

DESIGNED BY
D. OLIVETI
DRAWN BY
S. WILSON
CHECKED BY
N. OUM
IN CHARGE
C. LEMLEY
DATE
03/18/2016



PARSONS


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SUBMITTAL
**NOT FOR
CONSTRUCTION**




CALIFORNIA
HIGH-SPEED RAIL AUTHORITY

**CALIFORNIA HIGH-SPEED TRAIN PROJECT
MERCED TO FRESNO SECTION**
CENTRAL VALLEY WYE
SR 152 (NORTH) TO ROAD 19 WYE ALTERNATIVE
TRACK PLAN
MER-FRE 14939+00 TO 14995+00

CONTRACT NO.
HSR08-05
DRAWING NO.
TT-D1450-B
SCALE
AS SHOWN
SHEET NO.

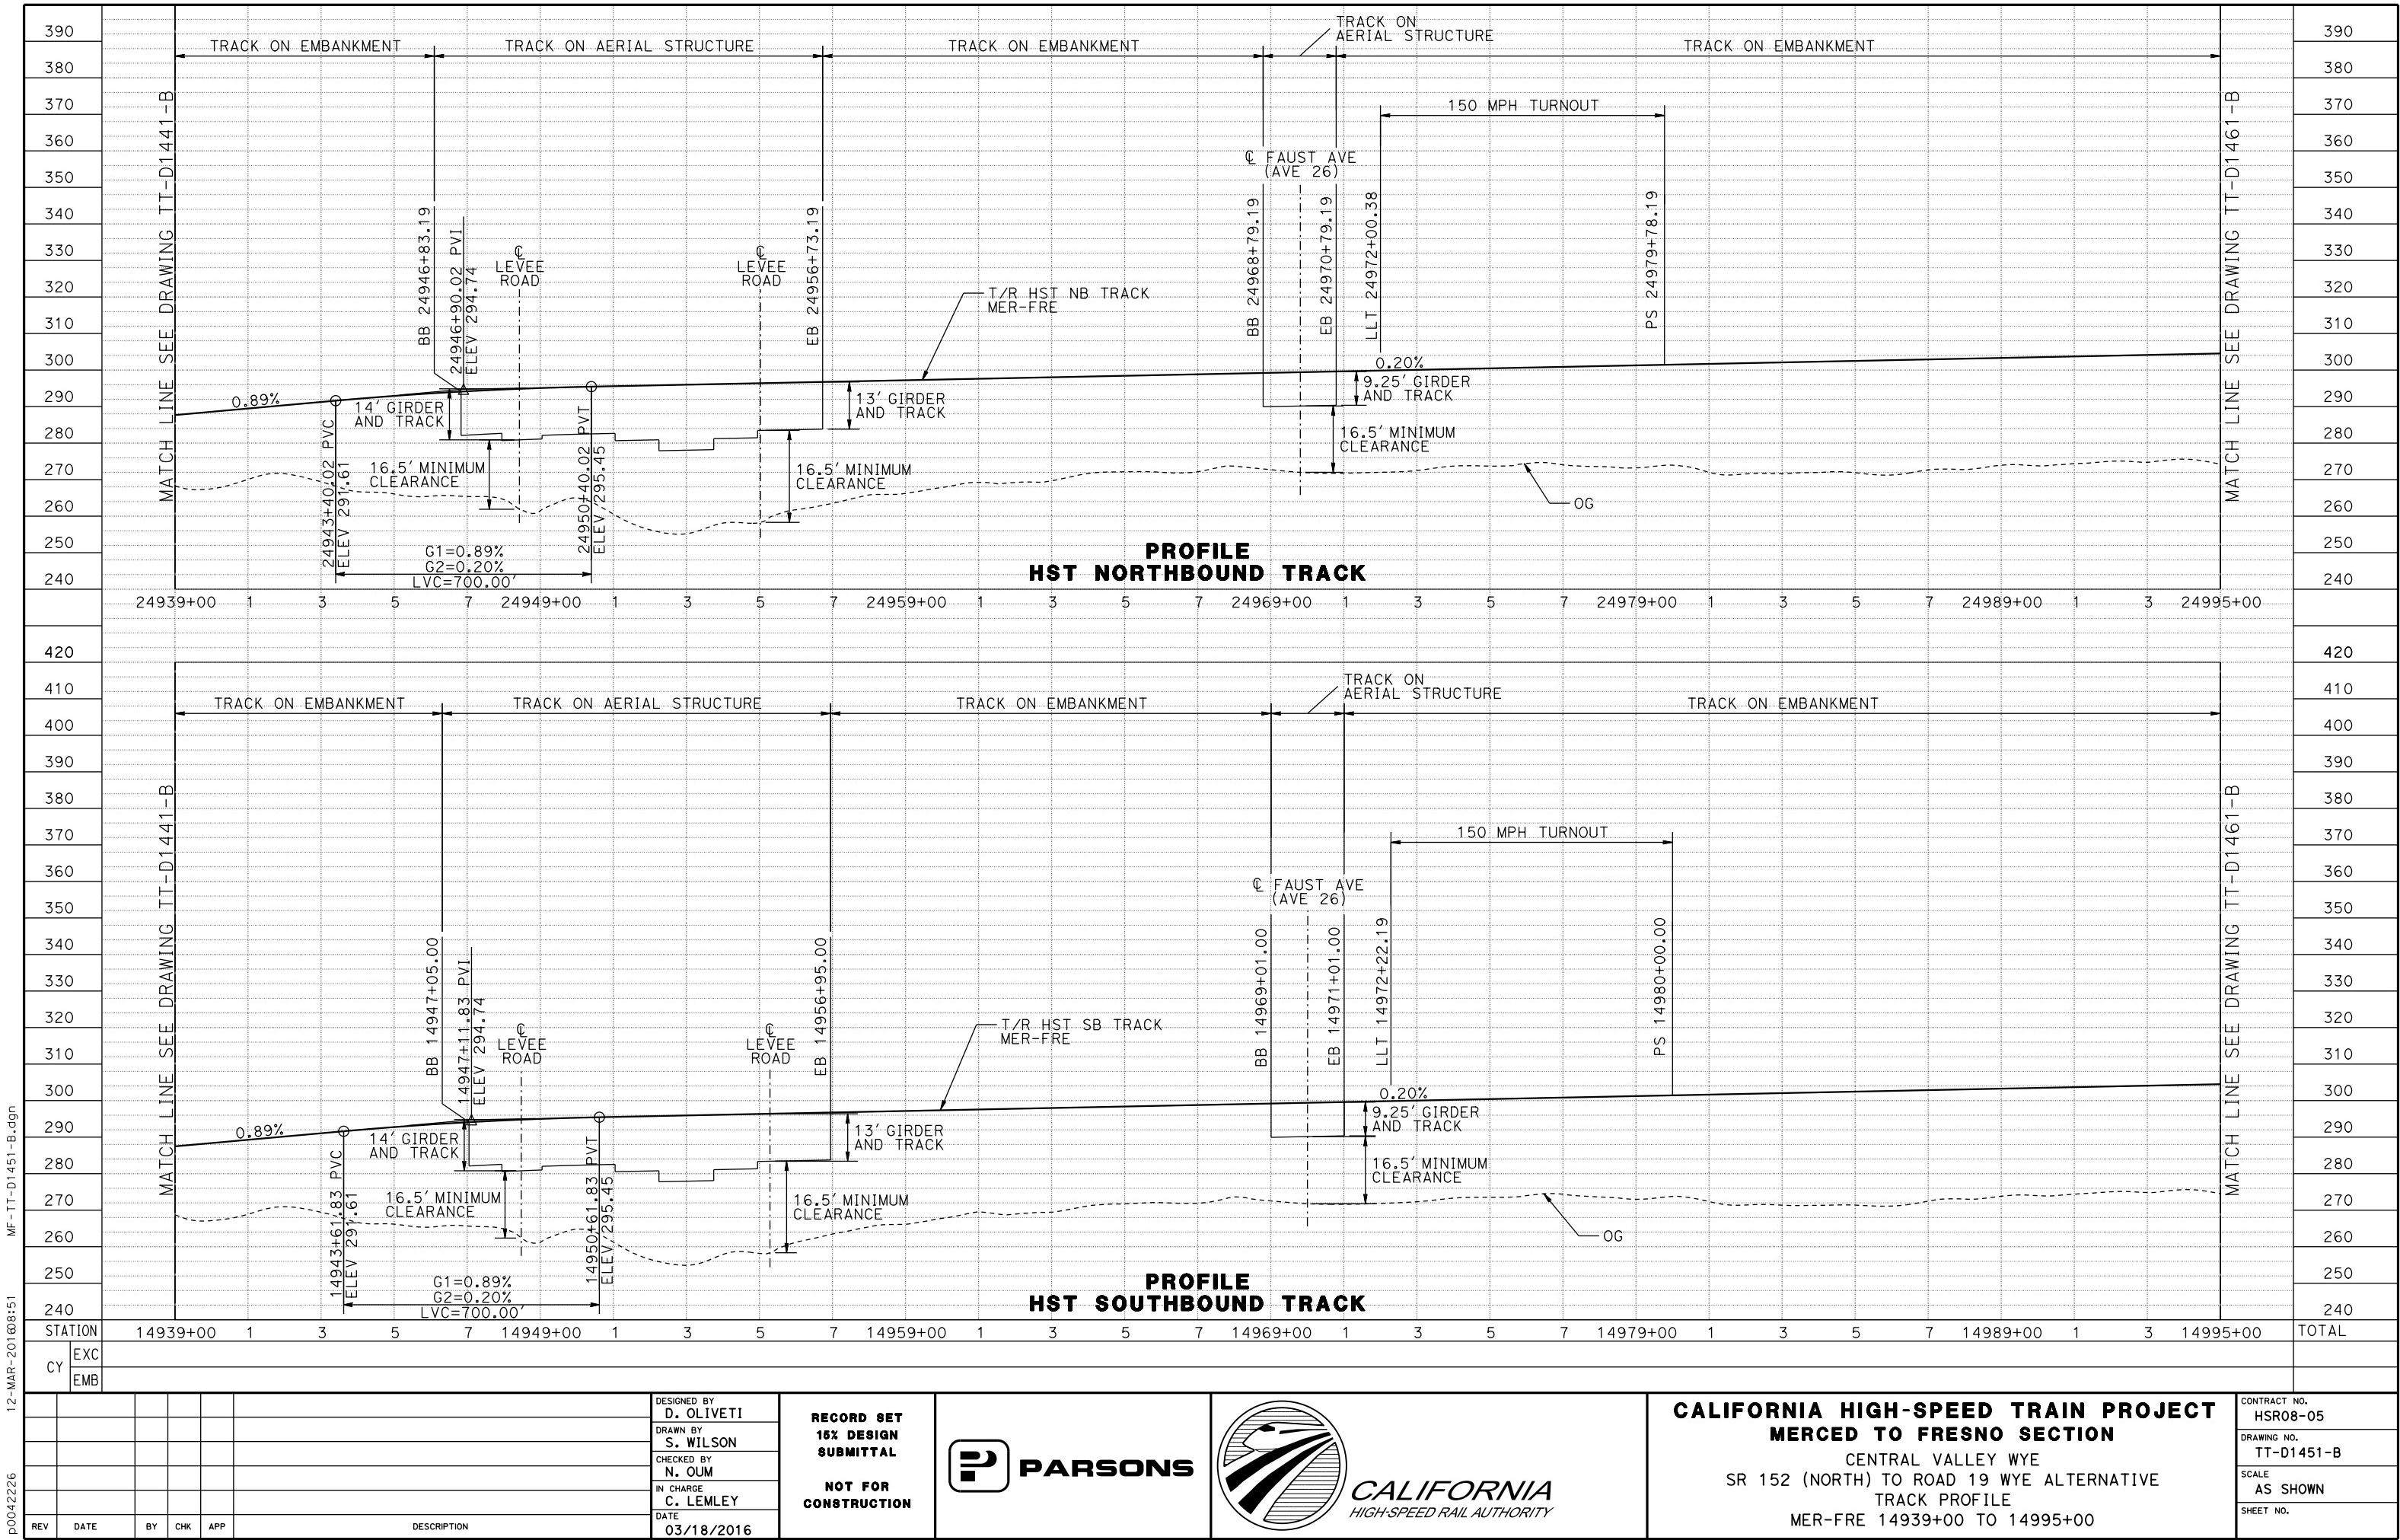

MADERA COUNTY

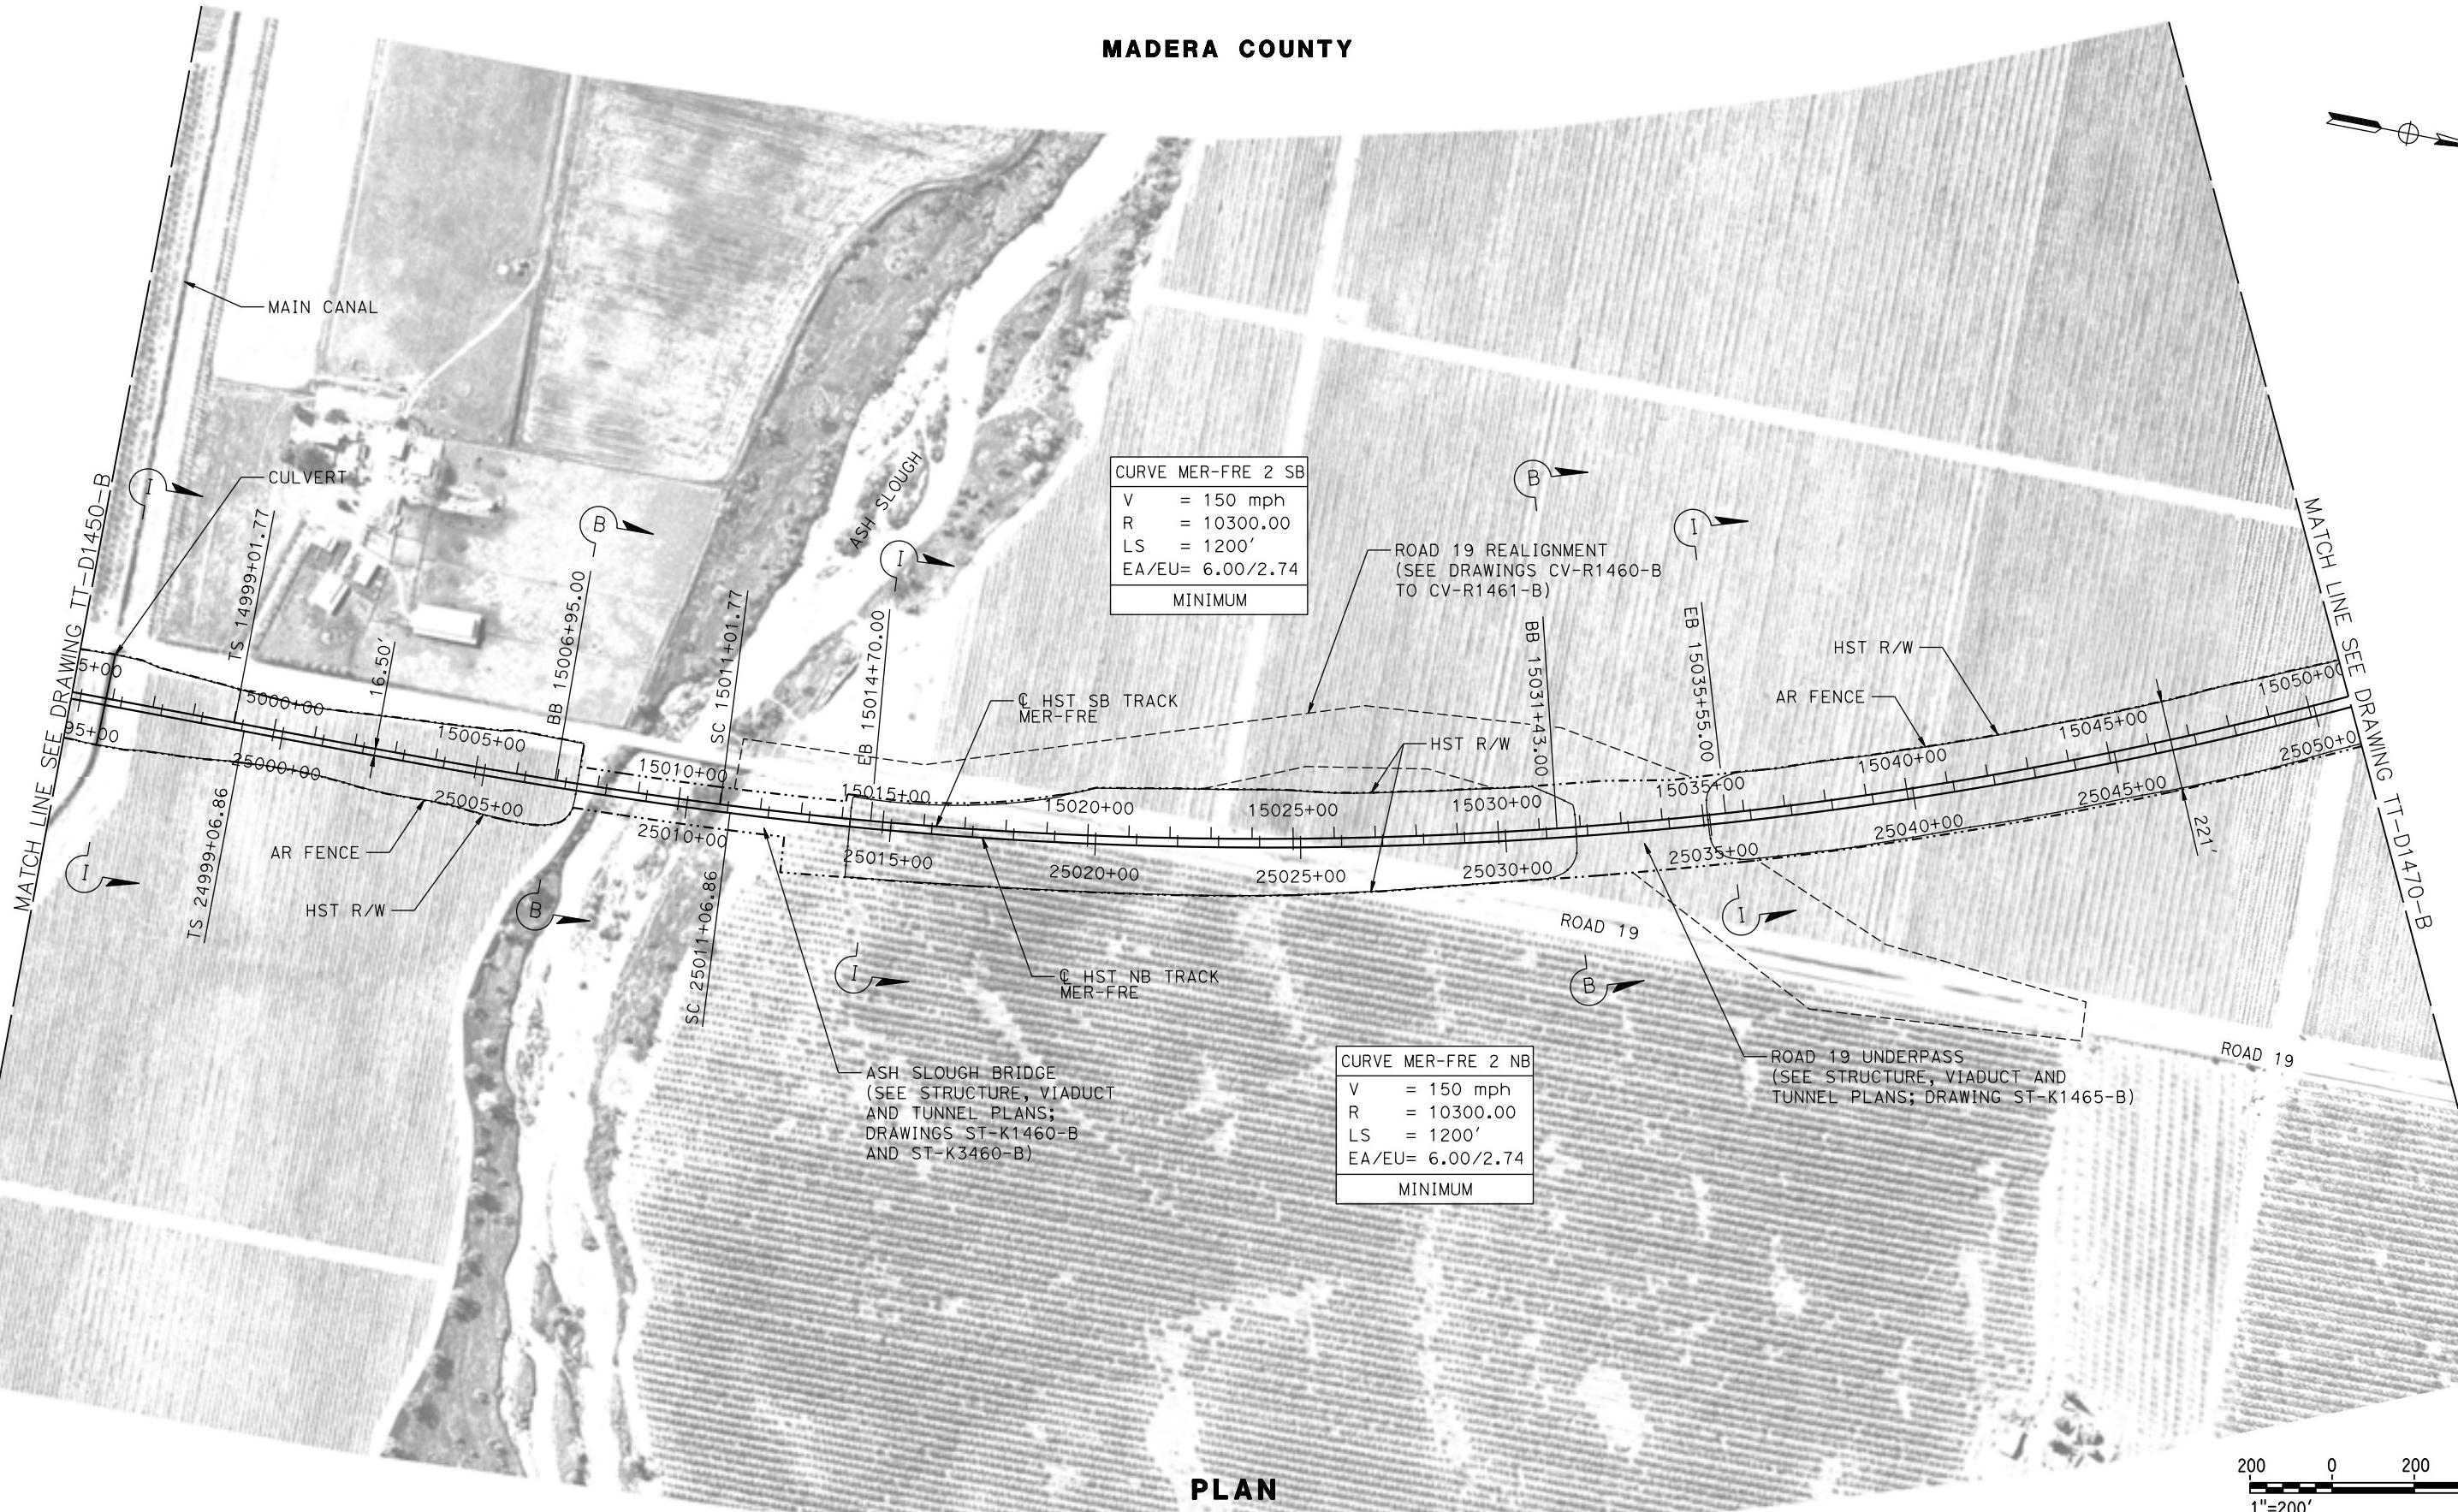

DESIGNED BY D. OLIVETI	RECORD SET 15% DESIGN SUBMITTAL	PARSONS	CALIFORNIA HIGH-SPEED RAIL AUTHORITY	CALIFORNIA HIGH-SPEED TRAIN PROJECT MERCED TO FRESNO SECTION	CONTRACT NO. HSR08-05
DRAWN BY S. WILSON	NOT FOR CONSTRUCTION			CENTRAL VALLEY WYE SR 152 (NORTH) TO ROAD 19 WYE ALTERNATIVE TRACK PLAN	DRAWING NO. TT-D1460-B
CHECKED BY N. OUM				MER-FRE 14995+00 TO 15051+00	SCALE AS SHOWN
IN CHARGE C. LEMLEY					SHEET NO.
DATE 03/18/2016					
REV DATE BY CHK APP	DESCRIPTION				

0004226

RECORD SET
15% DESIGN
SUBMITTAL

NOT FOR
CONSTRUCTION



CALIFORNIA
HIGH-SPEED RAIL AUTHORITY

CALIFORNIA HIGH-SPEED TRAIN PROJECT
MERCED TO FRESNO SECTION

CENTRAL VALLEY WYE
SR 152 (NORTH) TO ROAD 19 WYE ALTERNATIVE
TRACK PLAN


MER-FRE 14995+00 TO 15051+00

CONTRACT NO.
HSR08-05


DRAWING NO.
TT-D1460-B

SCALE
AS SHOWN

SHEET NO.

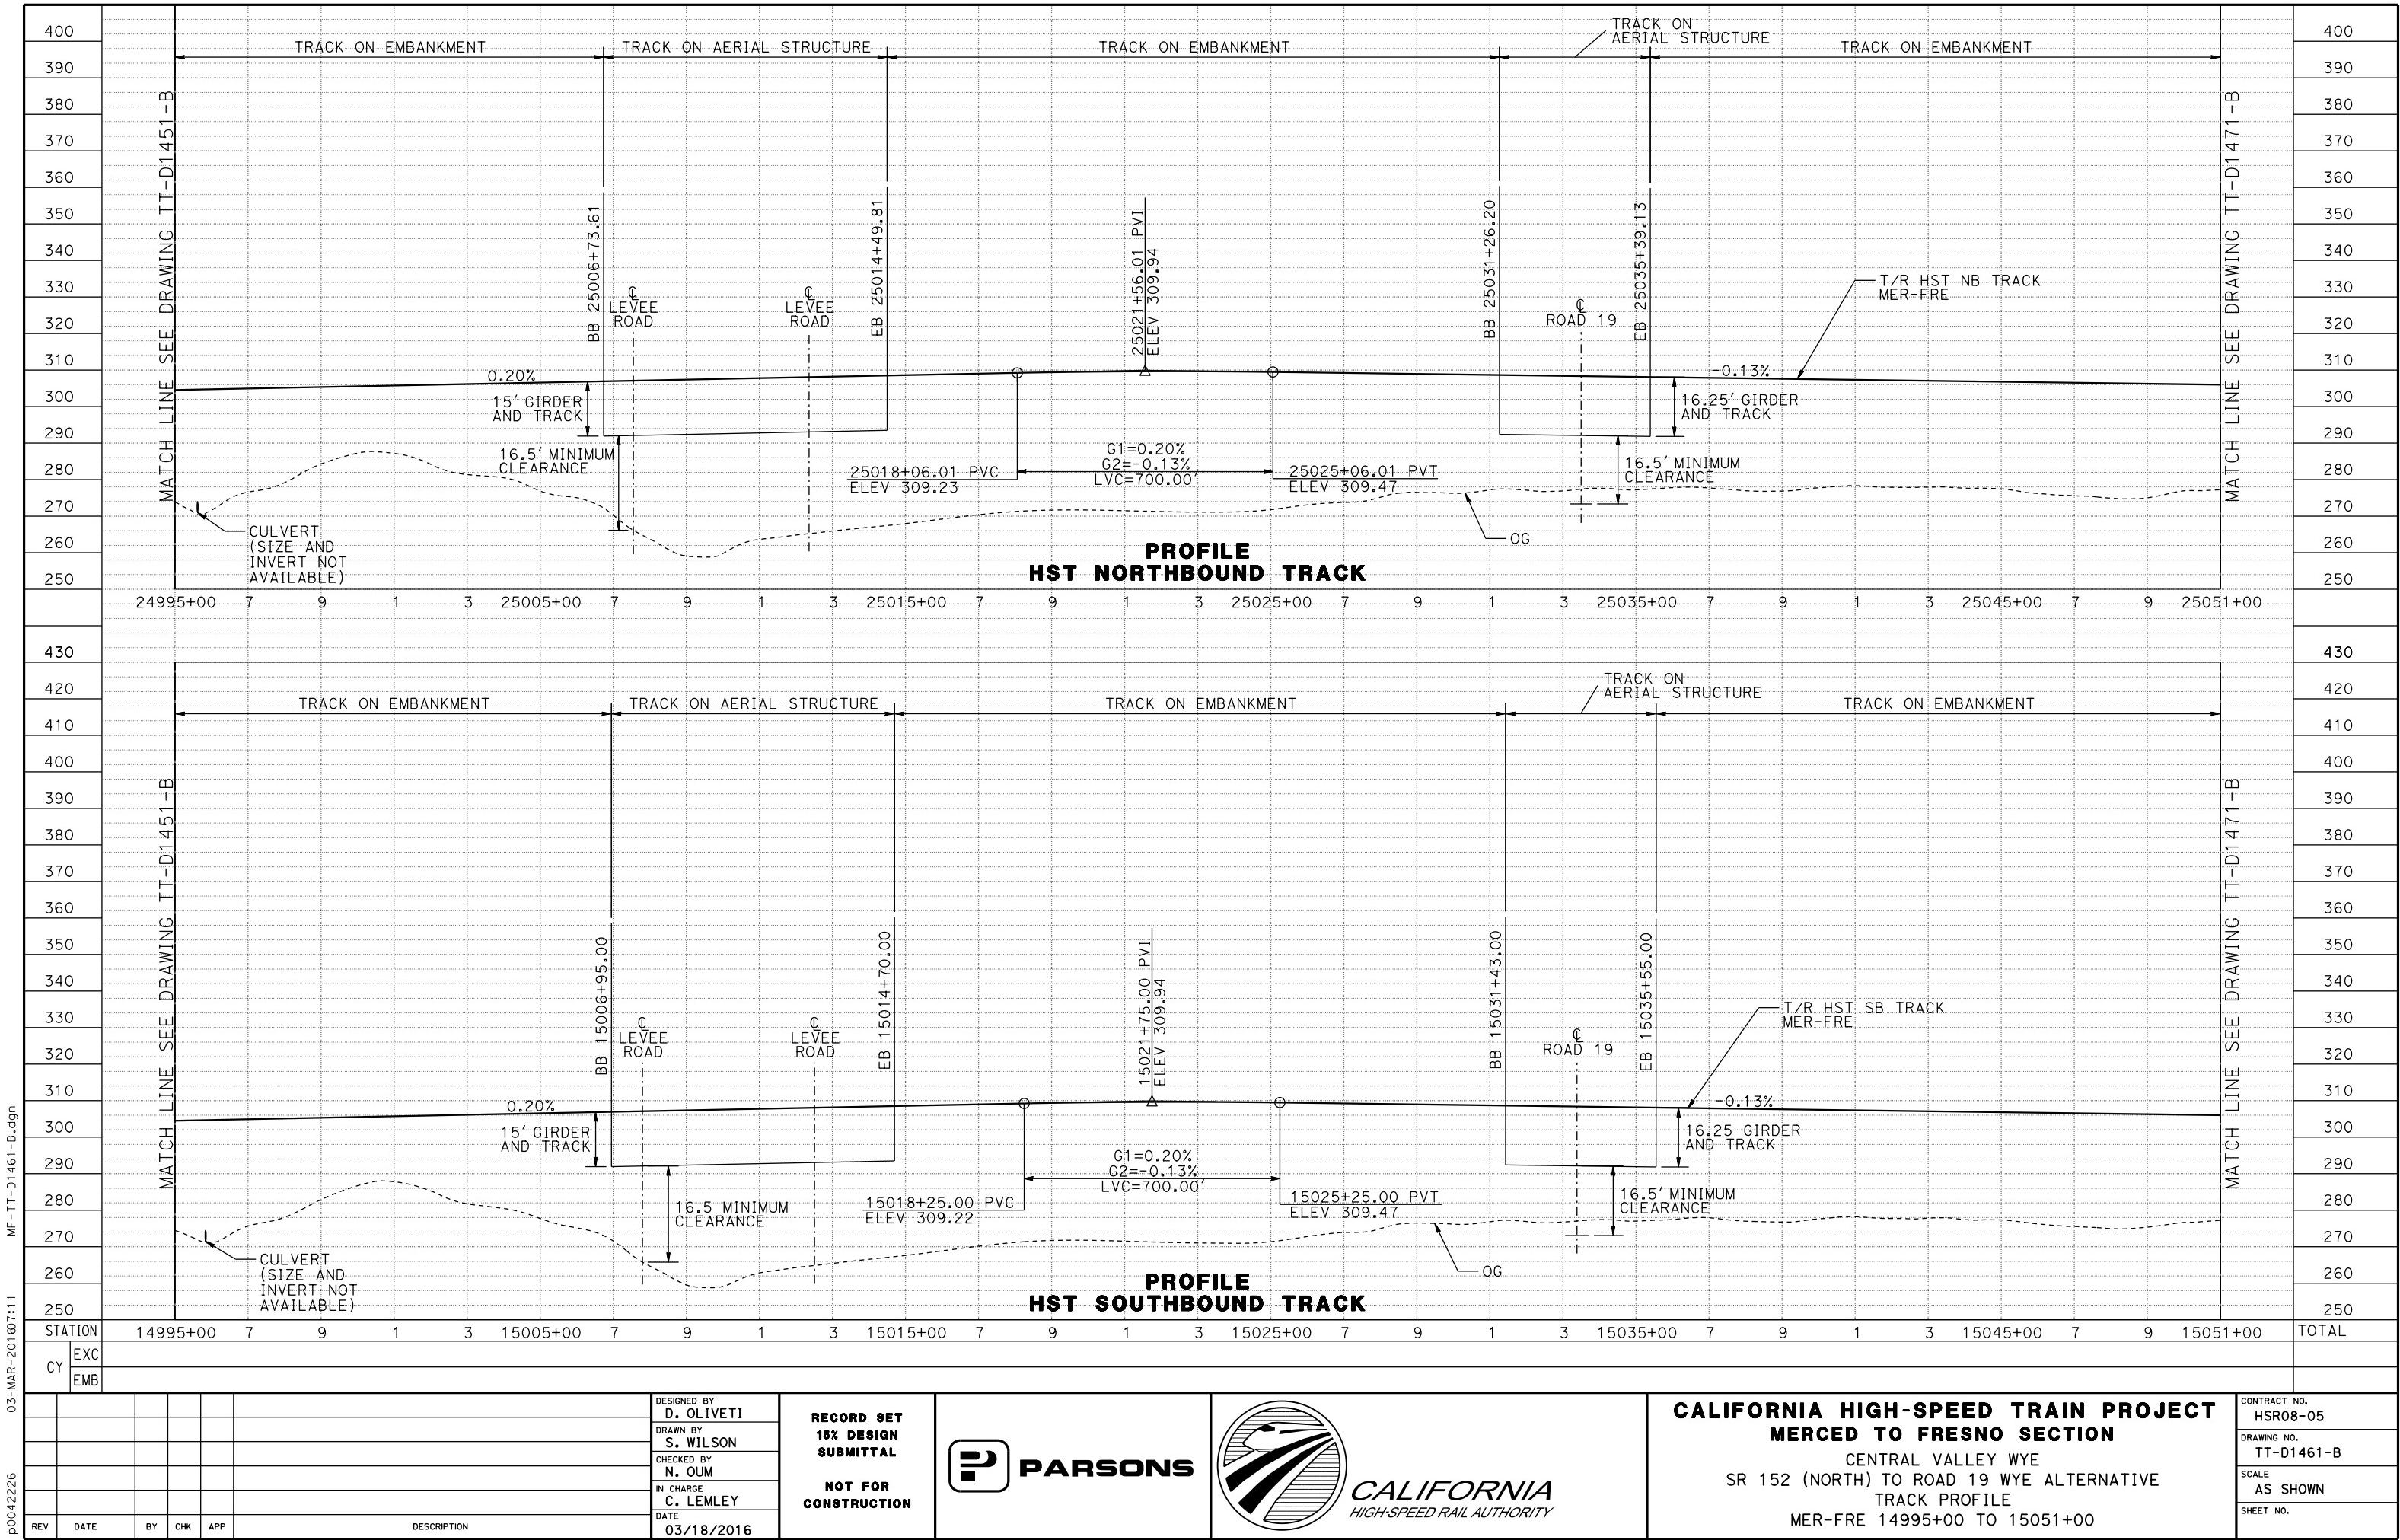

MADERA COUNTY

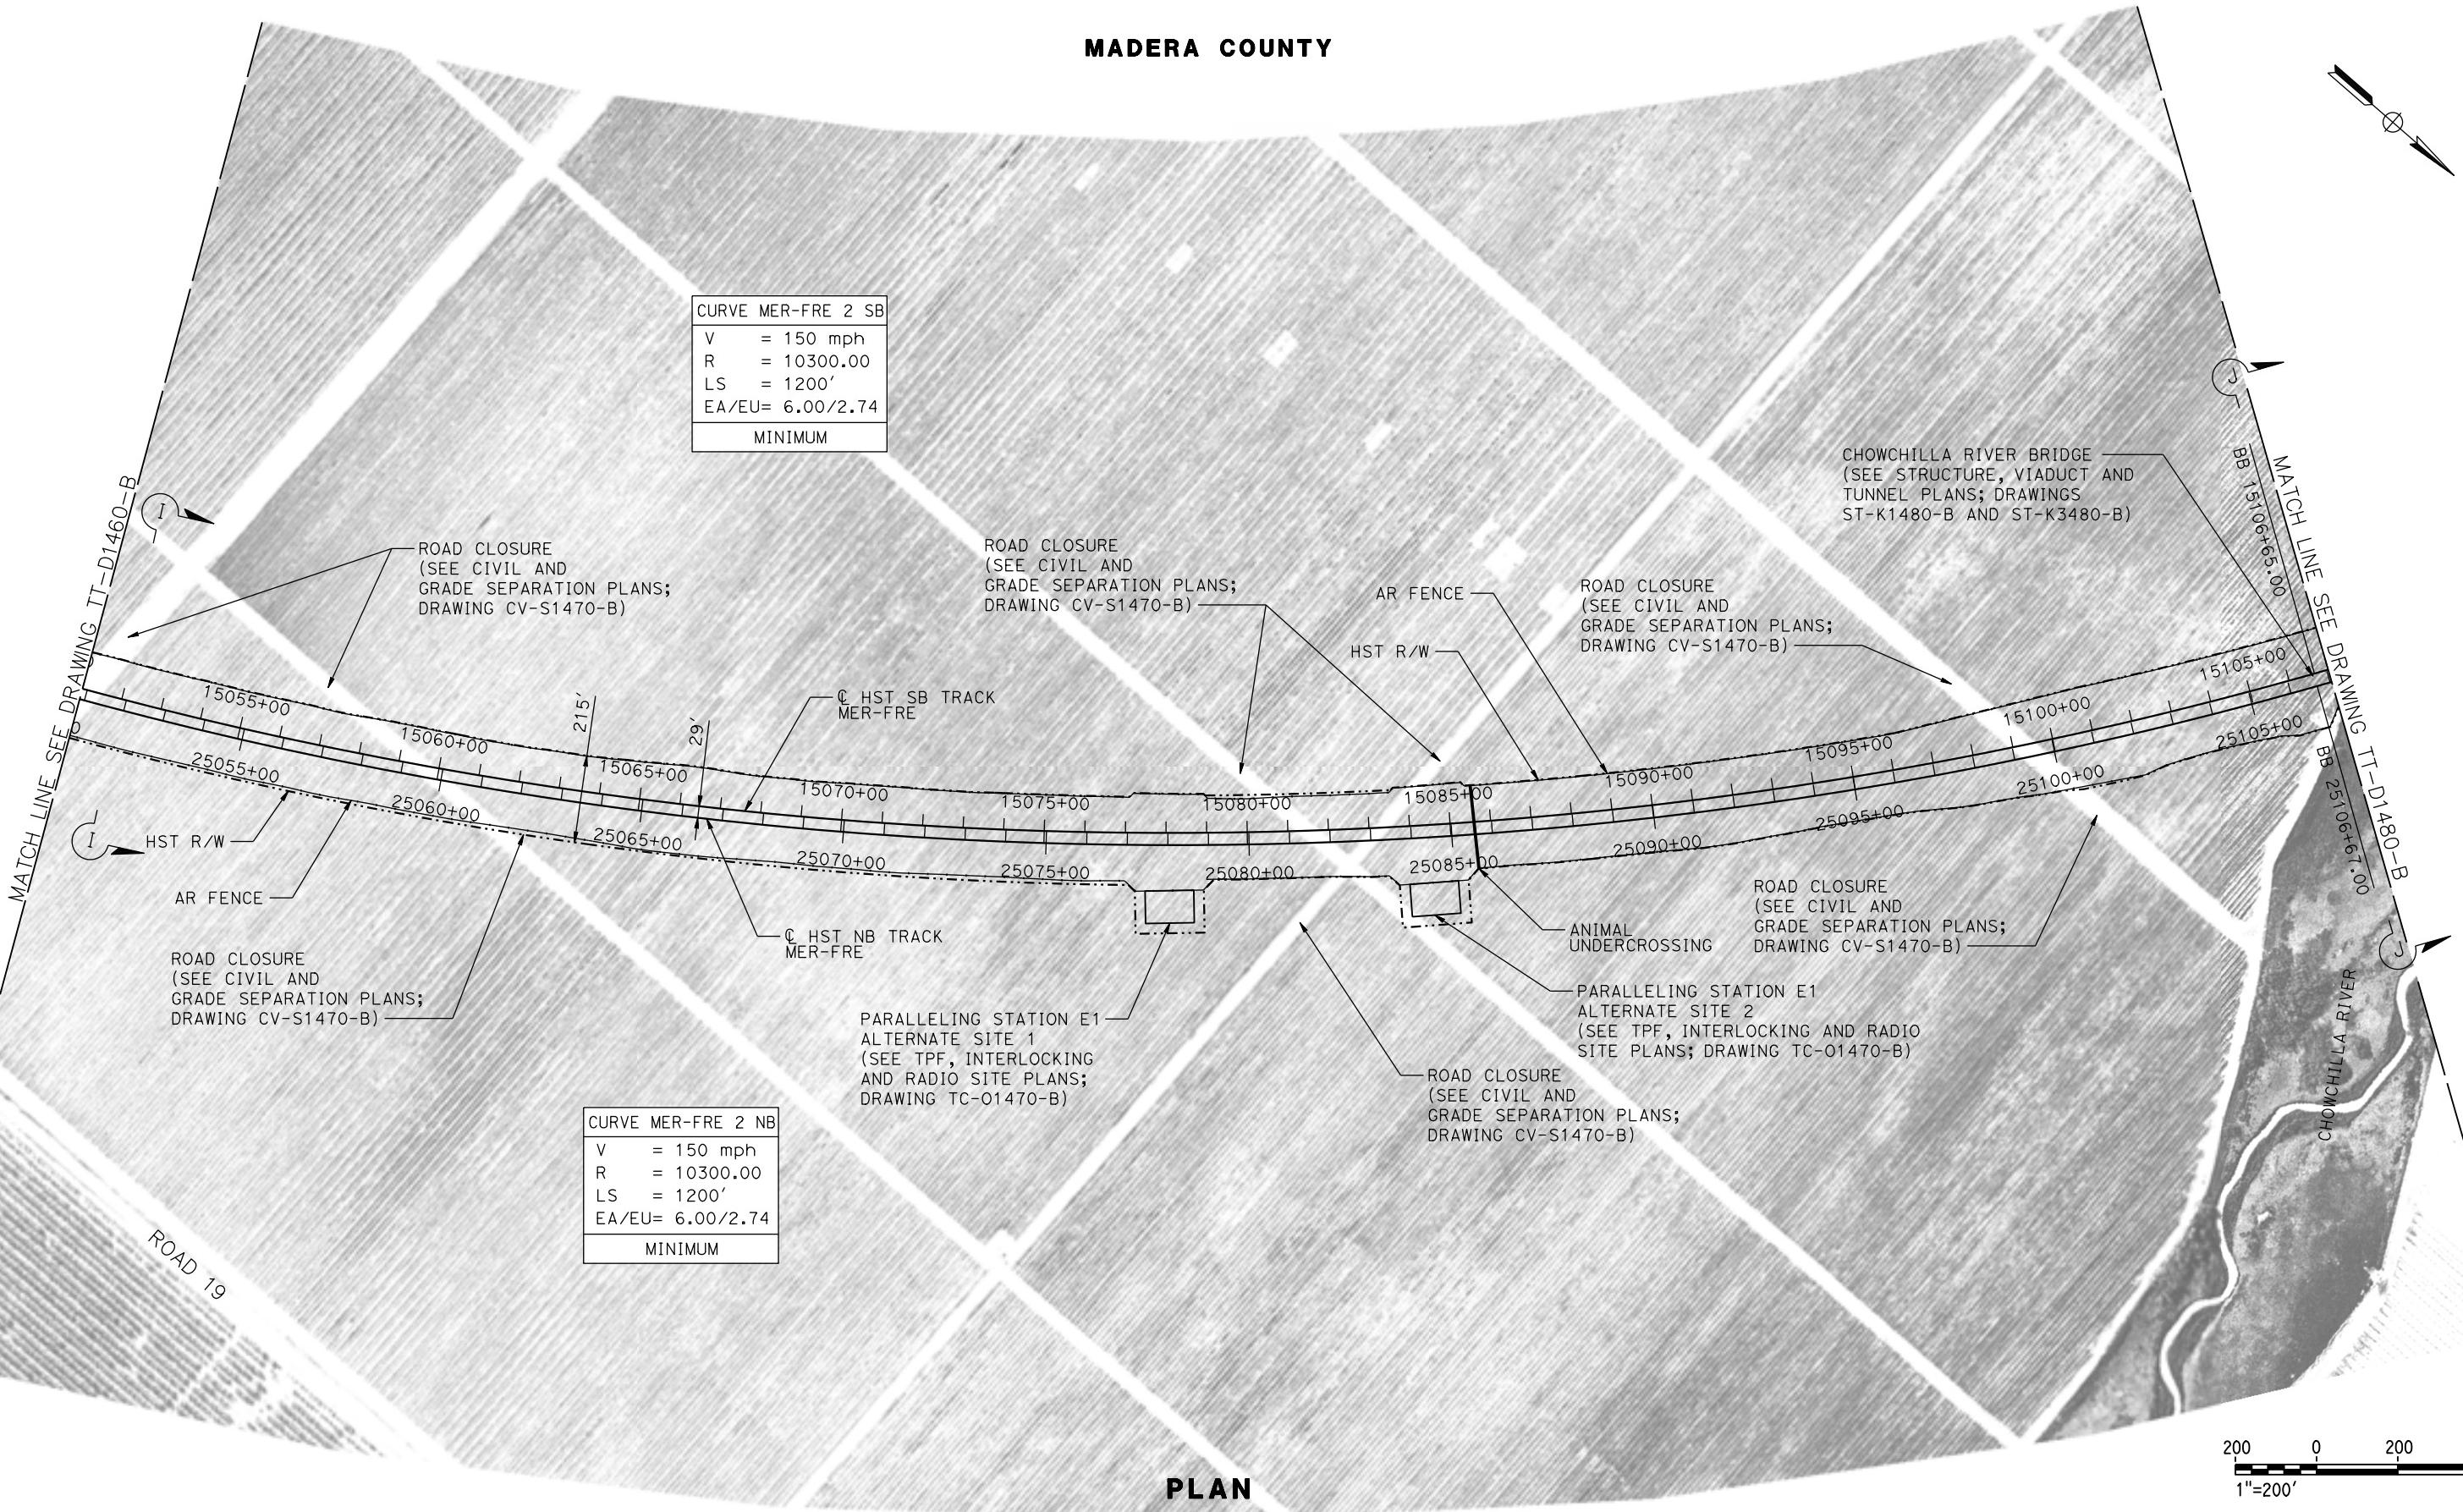

08-MAR-2016 2:56	MF-TT-D1470-B.dgn
p0042226	

REV	DATE	BY	CHK	APP	DESCRIPTION
					03/18/2016

DESIGNED BY
D. OLIVETI
DRAWN BY
S. WILSON
CHECKED BY
N. OUM
IN CHARGE
C. LEMLEY
DATE
03/18/2016

RECORD SET
15% DESIGN
SUBMITTAL
**NOT FOR
CONSTRUCTION**




PARSONS



CALIFORNIA
HIGH-SPEED RAIL AUTHORITY

**CALIFORNIA HIGH-SPEED TRAIN PROJECT
MERCED TO FRESNO SECTION**
CENTRAL VALLEY WYE
SR 152 (NORTH) TO ROAD 19 WYE ALTERNATIVE
TRACK PLAN
MER-FRE 15051+00 TO 15107+00

CONTRACT NO.
HSR08-05
DRAWING NO.
TT-D1470-B
SCALE
AS SHOWN
SHEET NO.

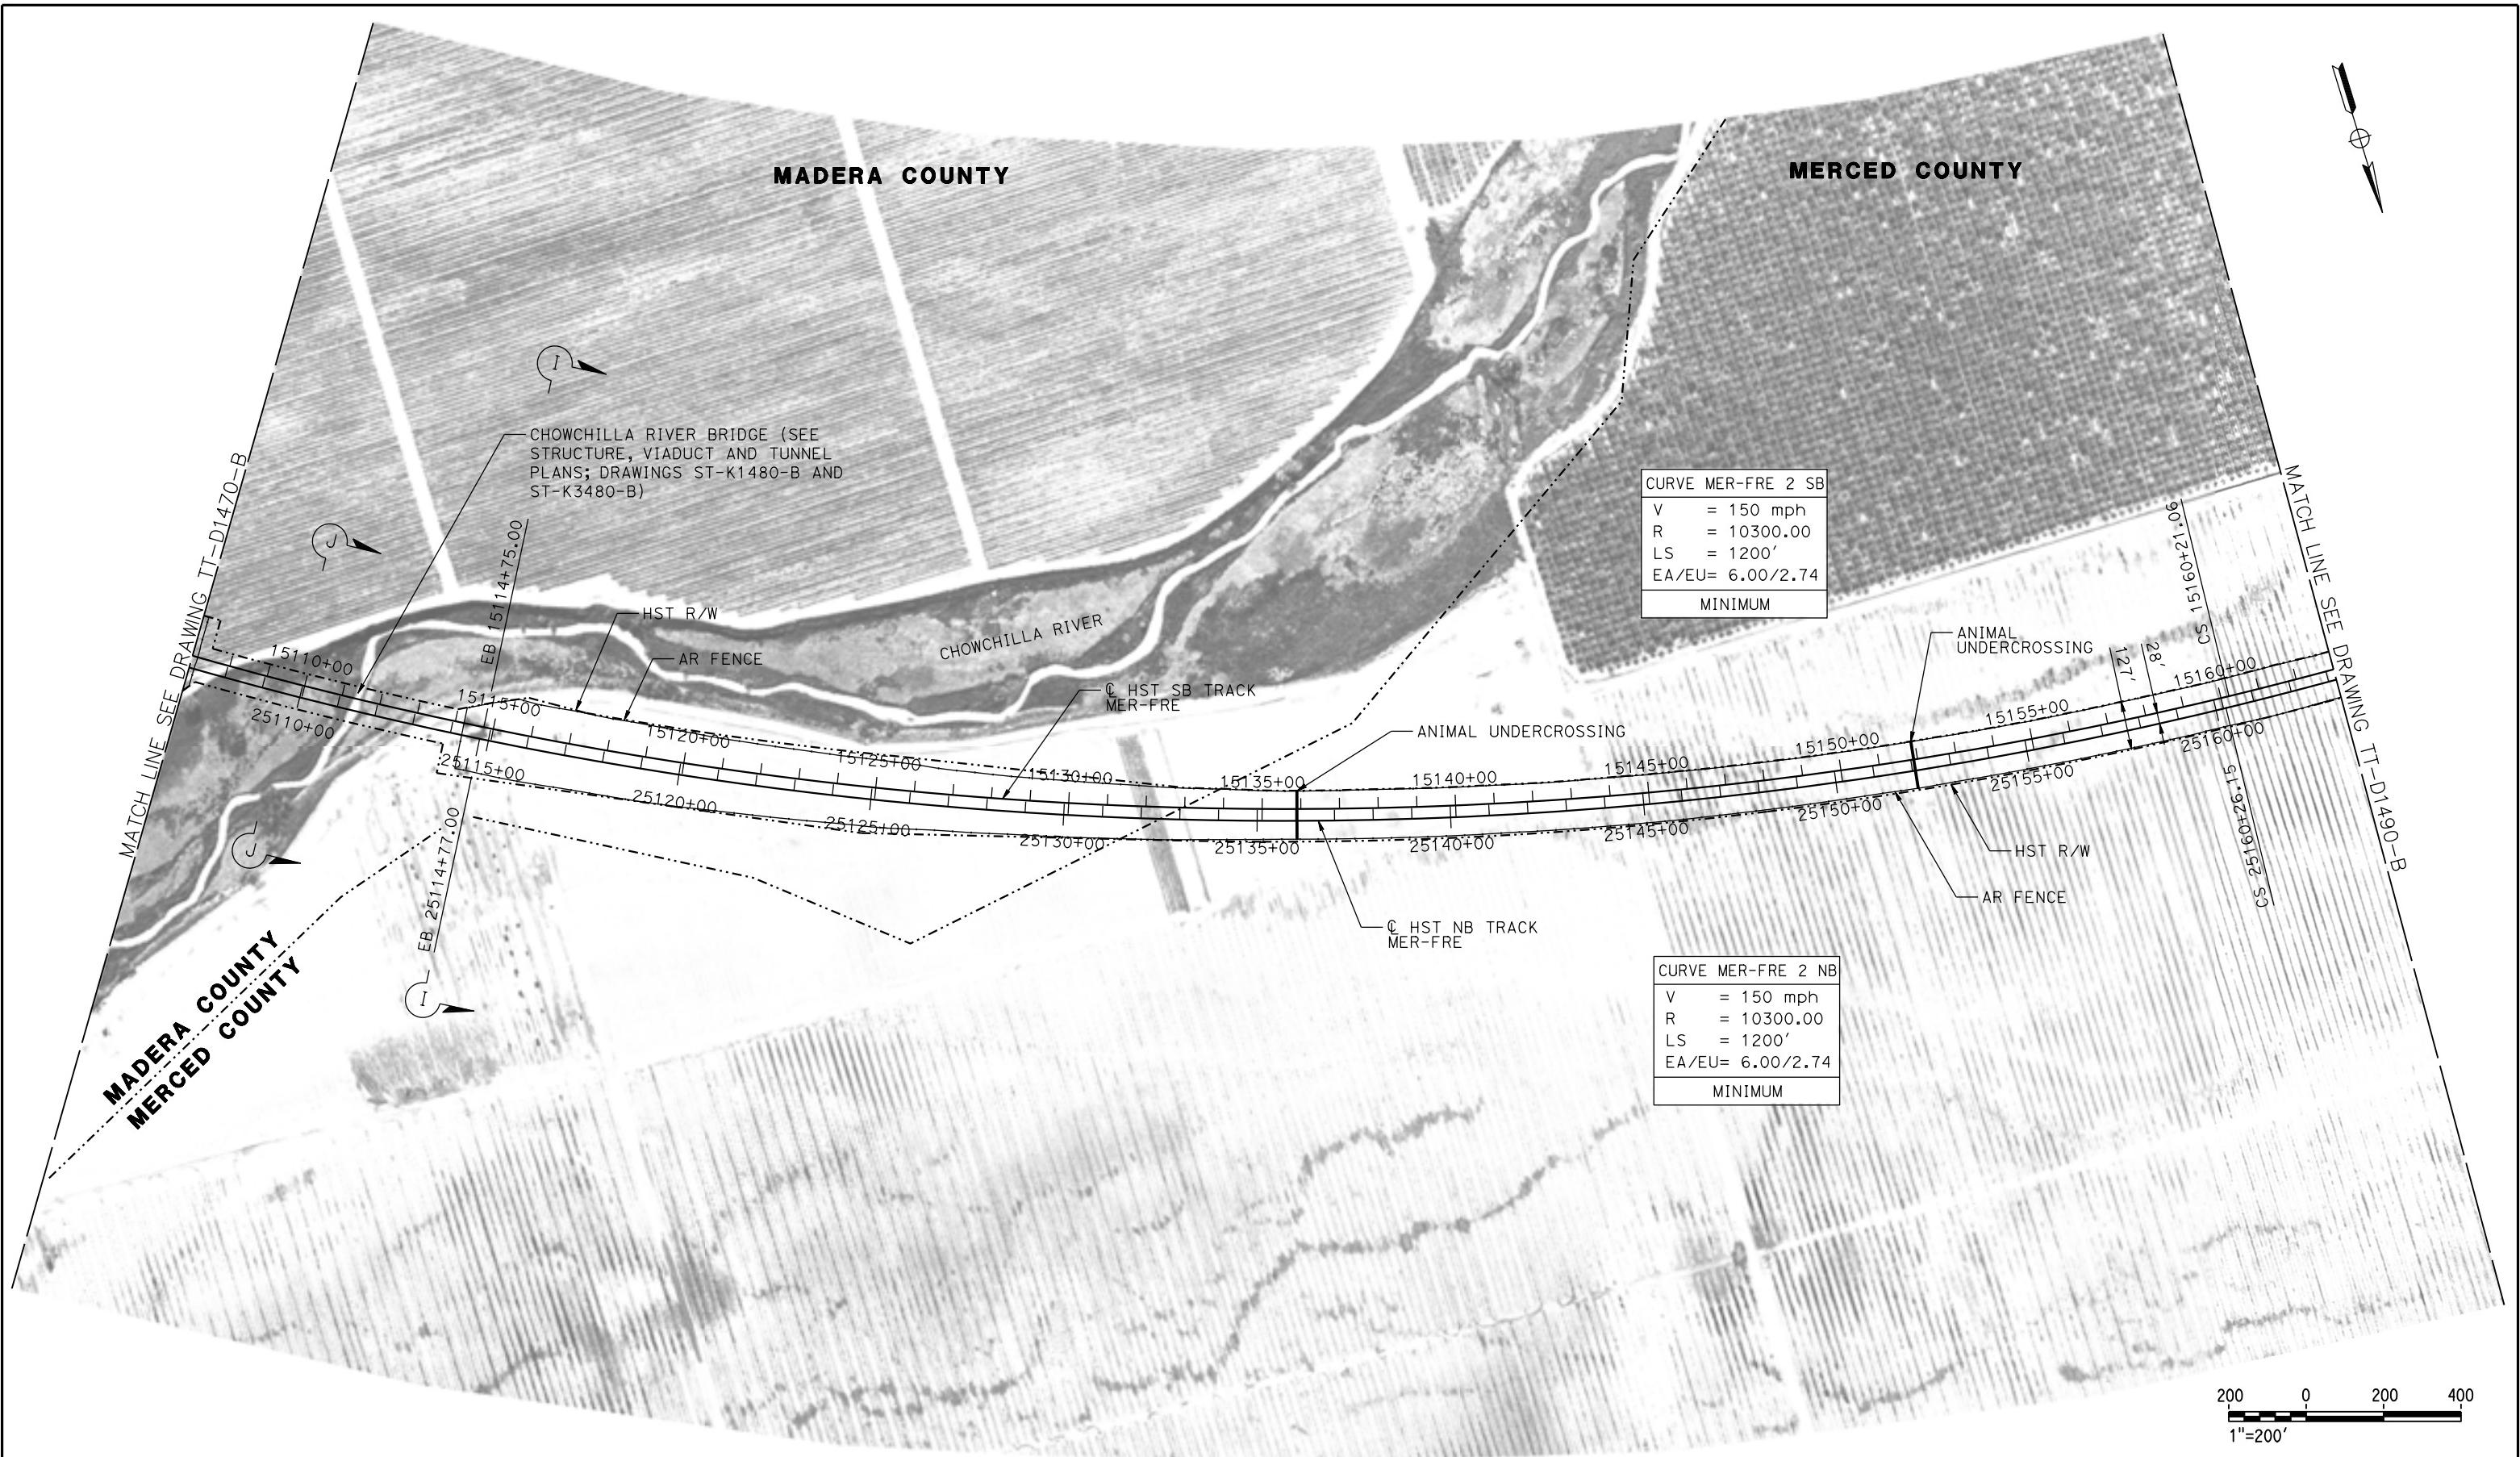

REV	DATE	BY	CHK	APP	DESCRIPTION
					03/18/2016

DESIGNED BY
D. OLIVETI
DRAWN BY
S. WILSON
CHECKED BY
N. OUM
IN CHARGE
C. LEMLEY
DATE
03/18/2016

RECORD SET
15% DESIGN
SUBMITTAL


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CONSTRUCTION




CALIFORNIA HIGH-SPEED TRAIN PROJECT MERCED TO FRESNO SECTION

CENTRAL VALLEY WYE
SR 152 (NORTH) TO ROAD 19 WYE ALTERNATIVE
TRACK PLAN
MER-FRE STA 15107+00.00 TO 15163+00.00

CONTRACT NO.
HSR08-05
DRAWING NO.
TT-D1480-B
SCALE
AS SHOWN
SHEET NO.

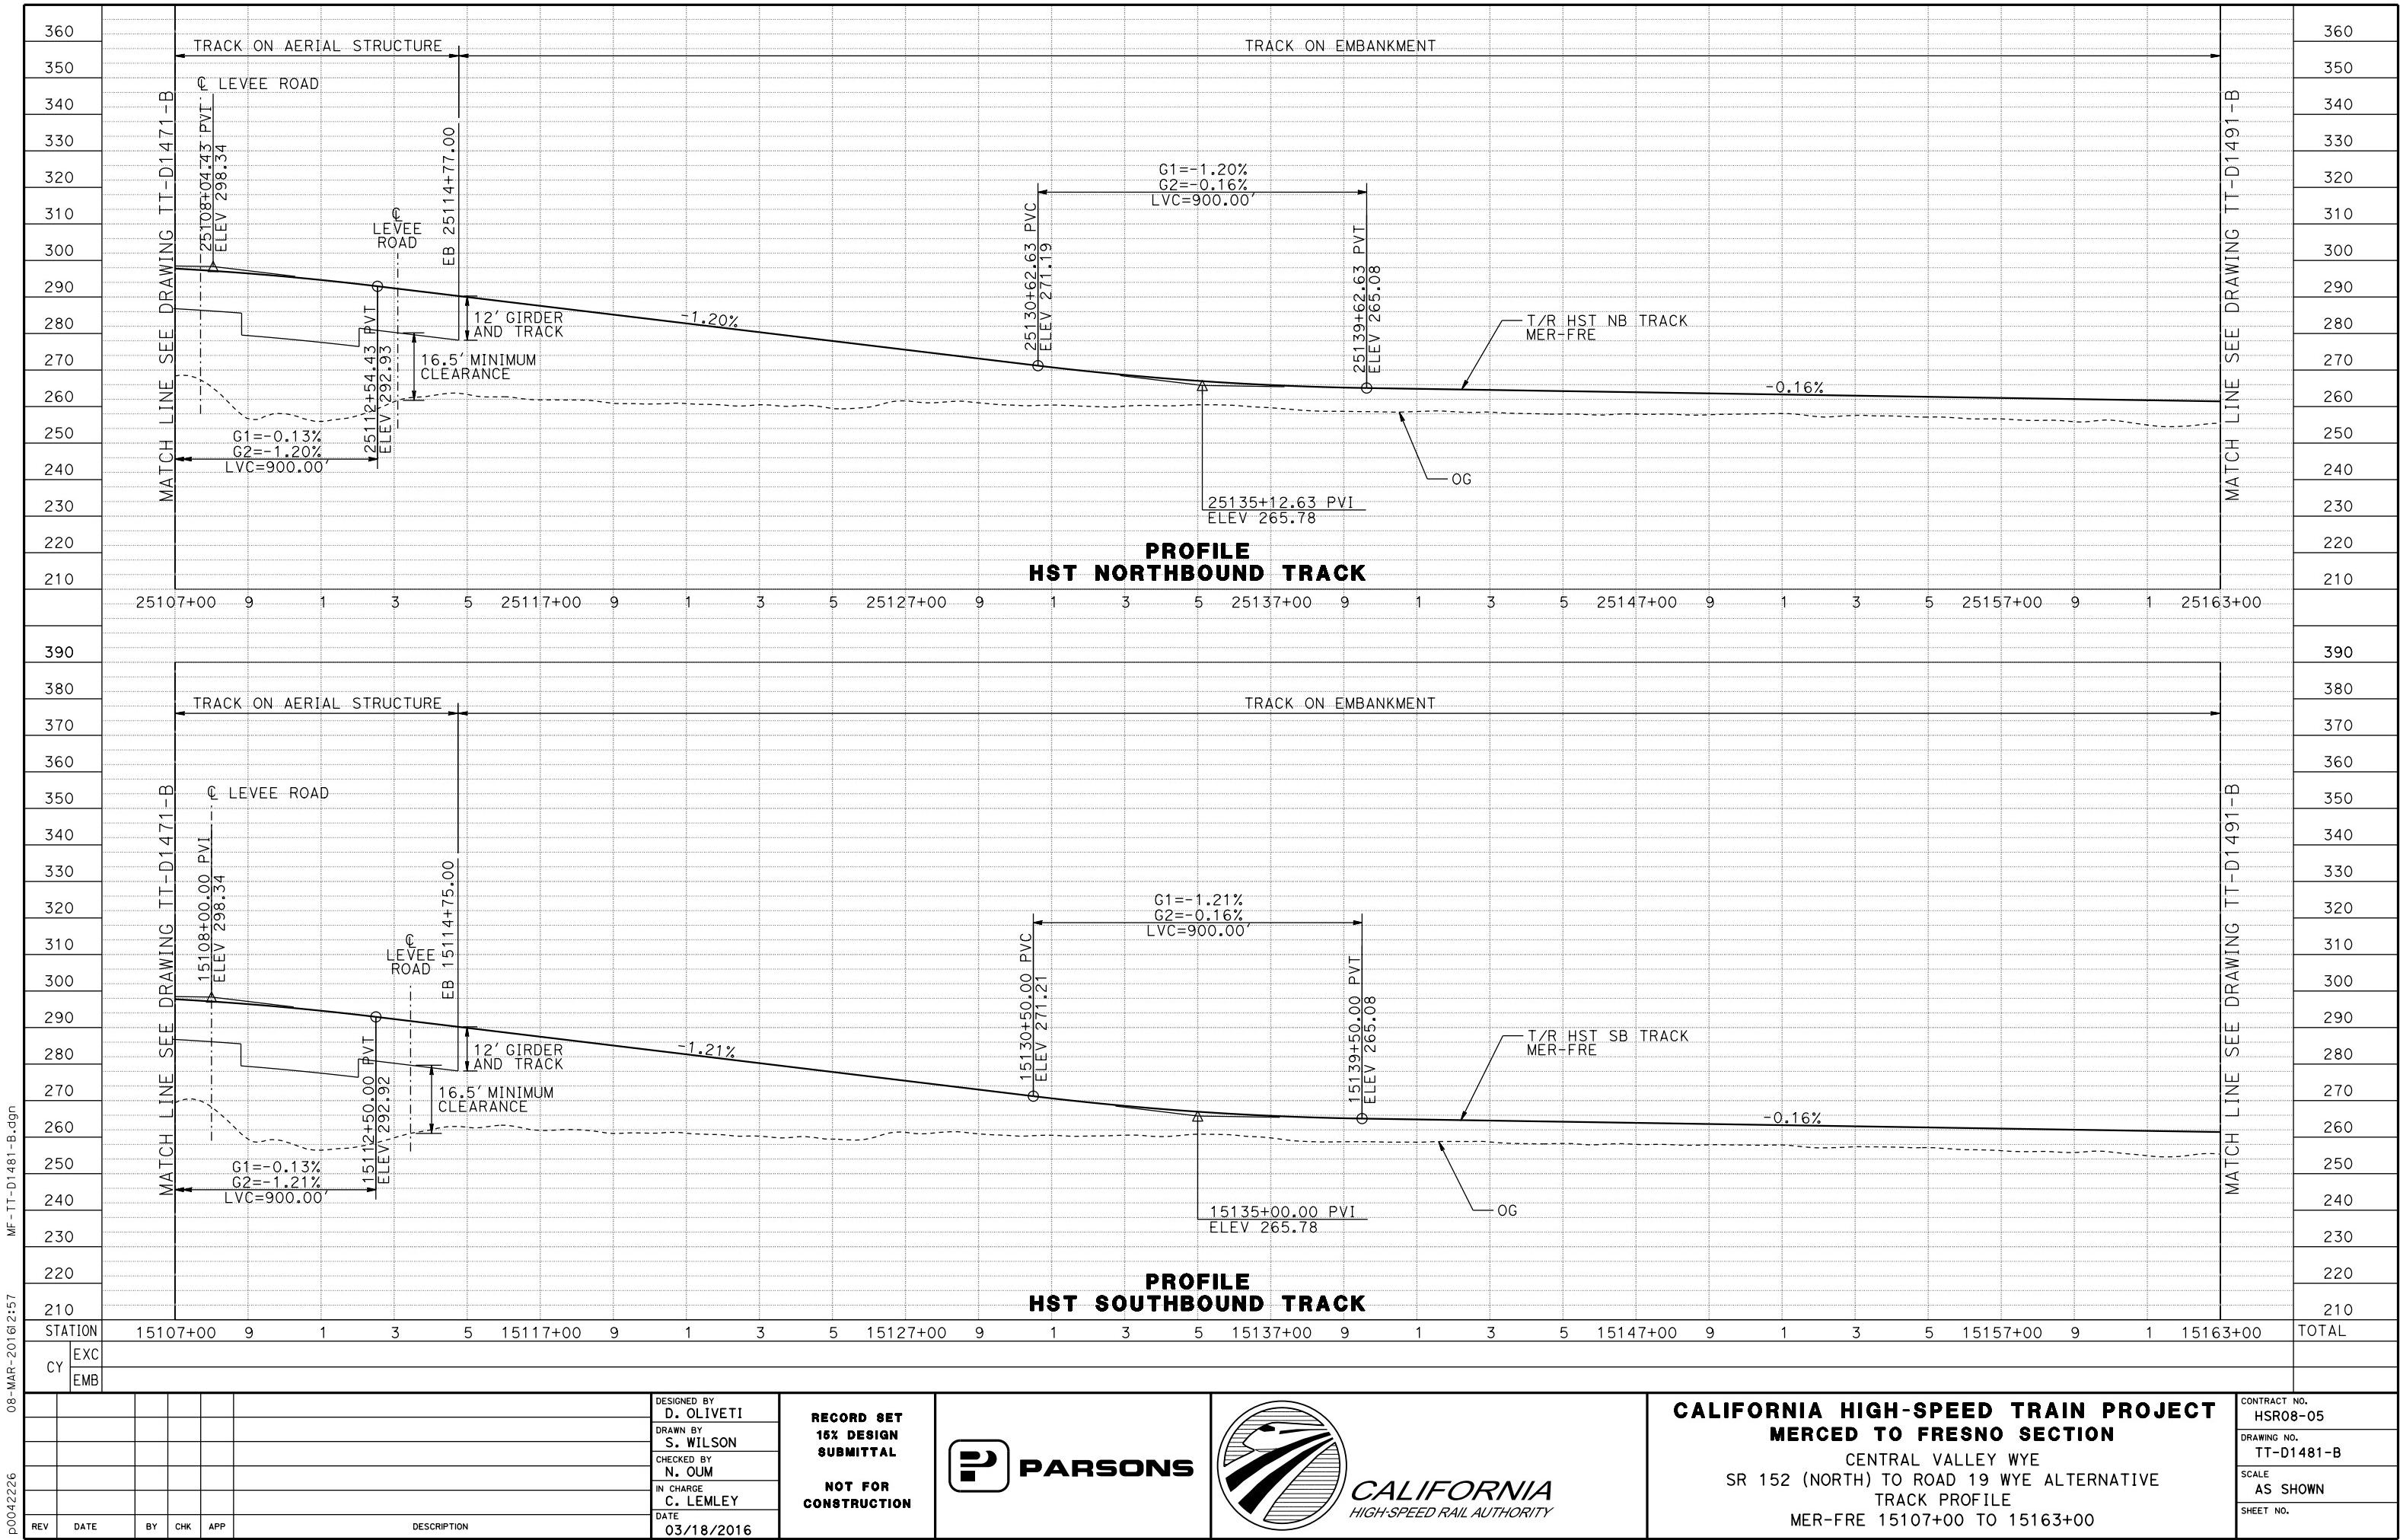

MERCED COUNTY

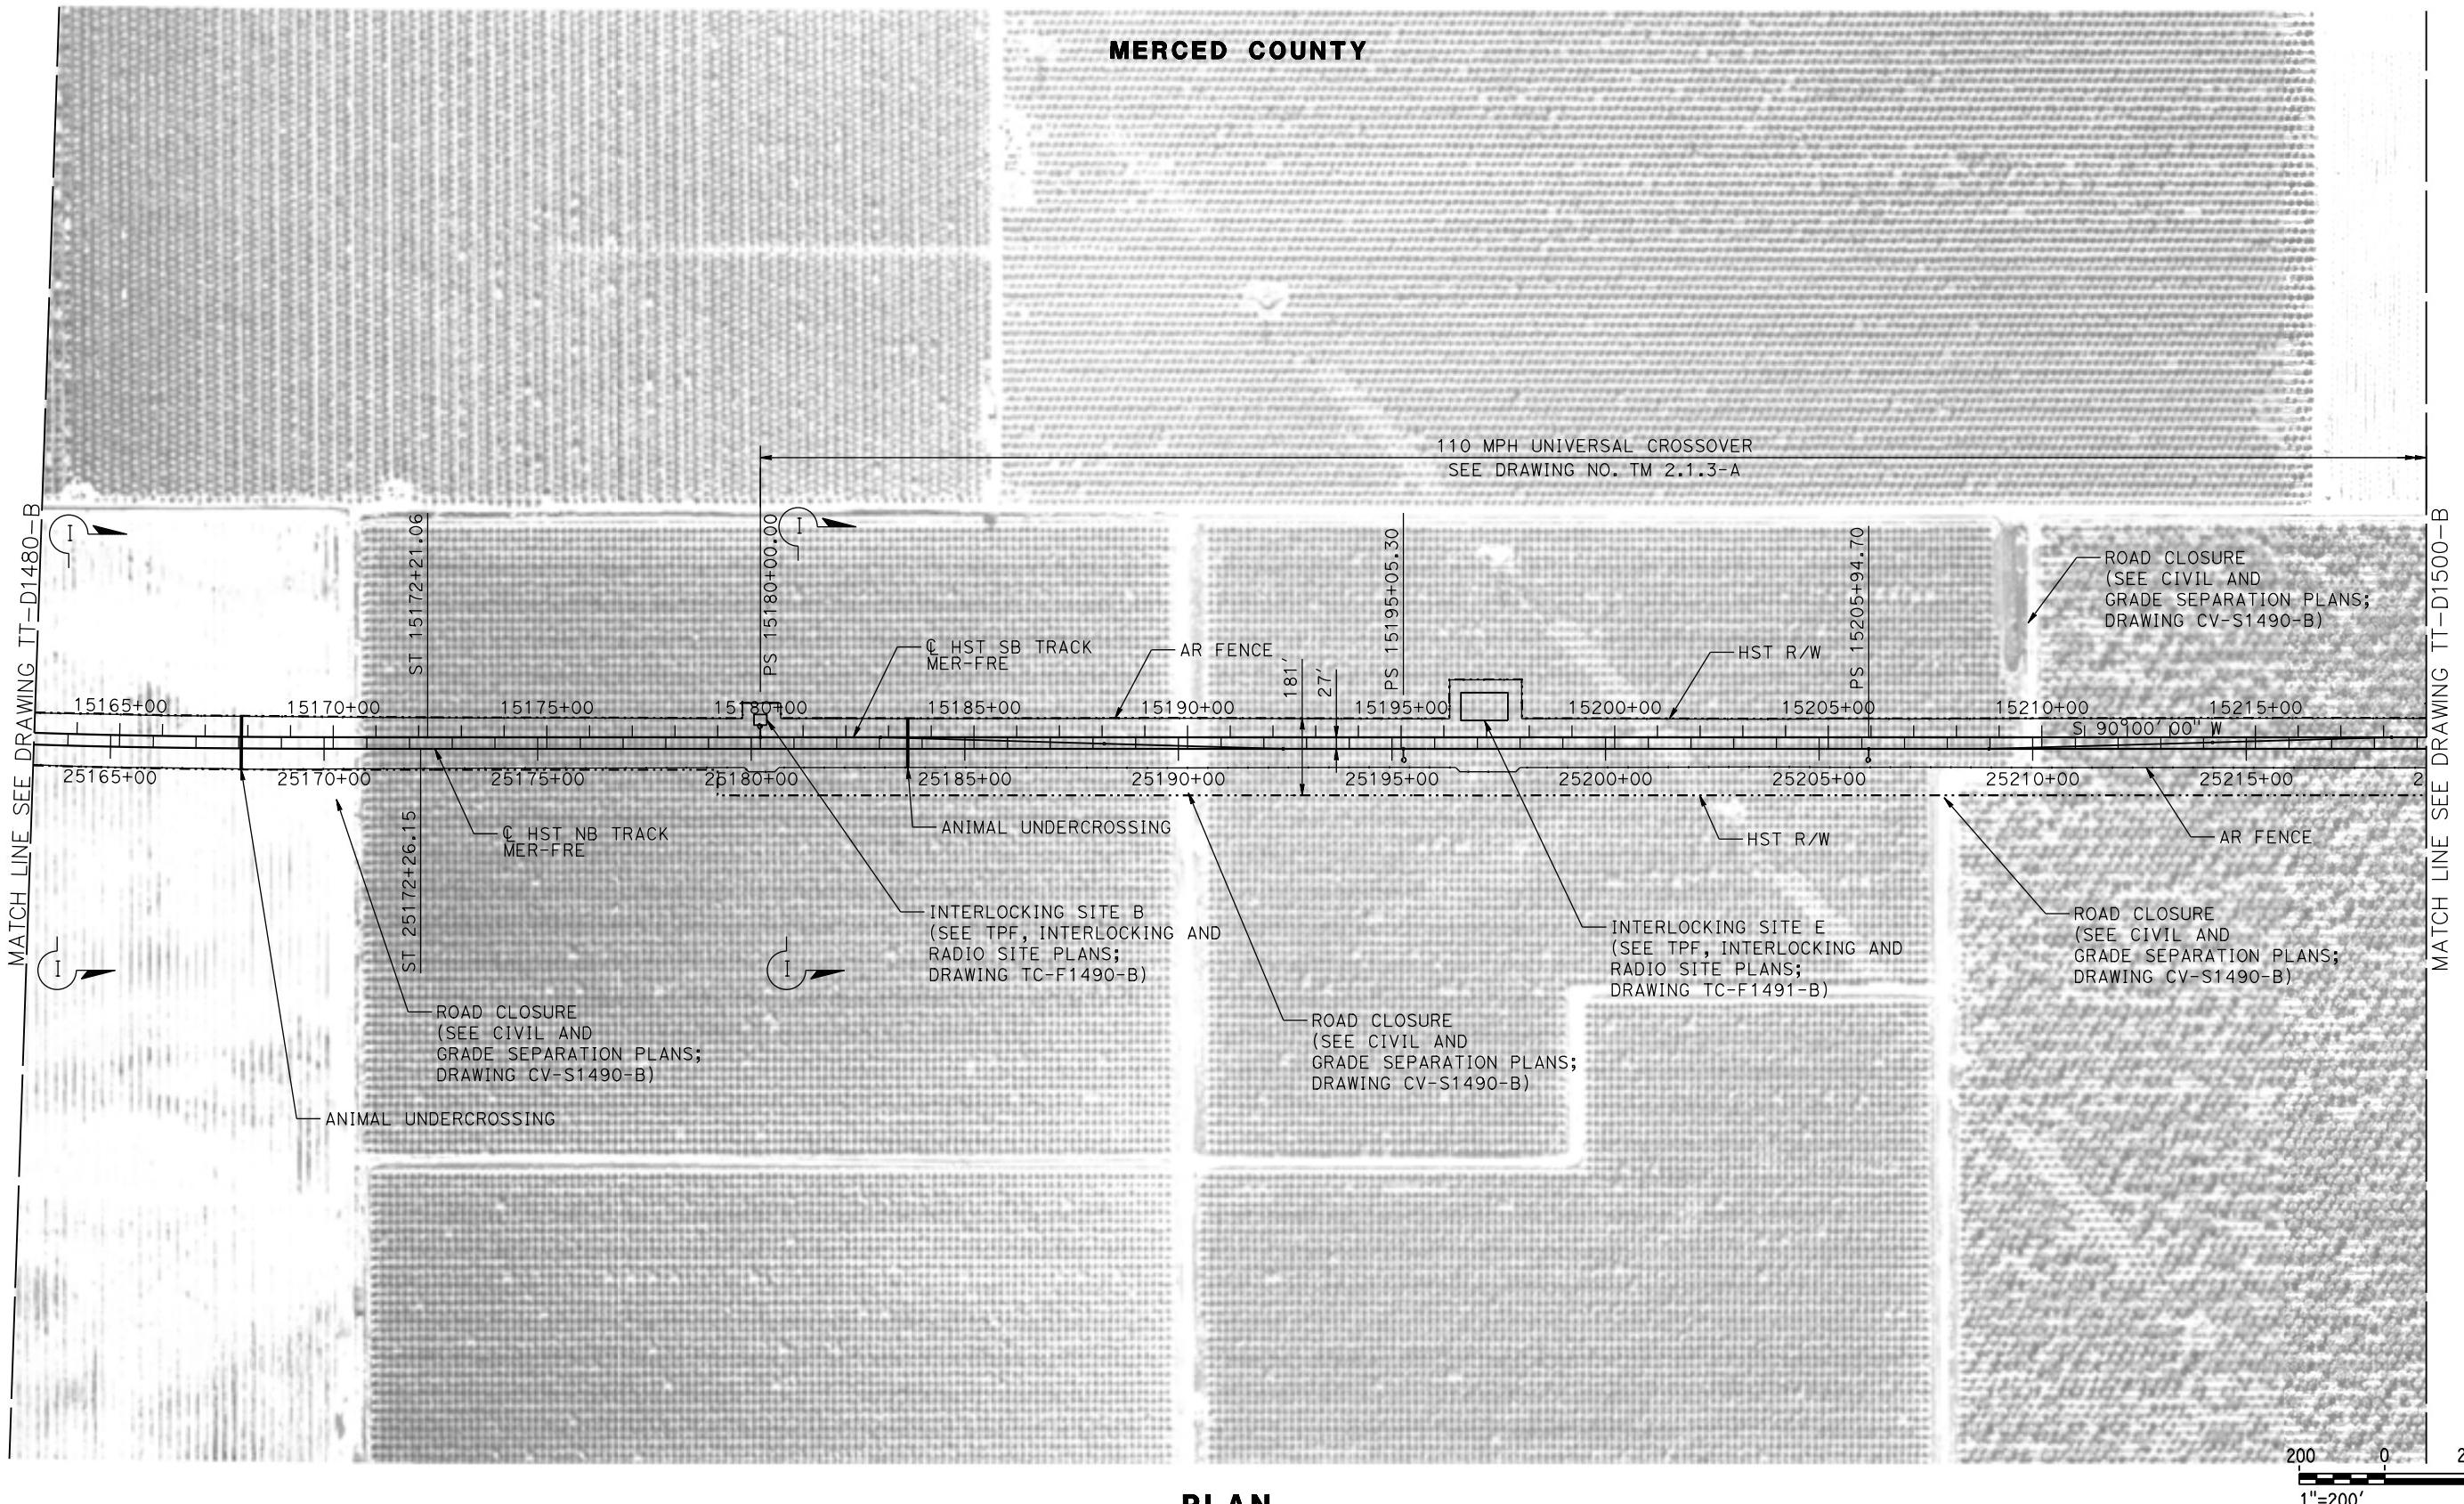

12-MAR-2016 08:51 MF-TT-D1490-B.dgn


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					DRAWN BY S. WILSON
					CHECKED BY N. OUM
					IN CHARGE C. LEMLEY
					DATE 03/18/2016
REV	DATE	BY	CHK	APP	DESCRIPTION

RECORD SET
15% DESIGN
SUBMITTAL
**NOT FOR
CONSTRUCTION**




**CALIFORNIA HIGH-SPEED TRAIN PROJECT
MERCED TO FRESNO SECTION**
CENTRAL VALLEY WYE
SR 152 (NORTH) TO ROAD 19 WYE ALTERNATIVE
TRACK PLAN
MER-FRE STA 15163+00.00 TO 15219+00.00

CONTRACT NO.
HSR08-05
DRAWING NO.
TT-D1490-B
SCALE
AS SHOWN
SHEET NO.

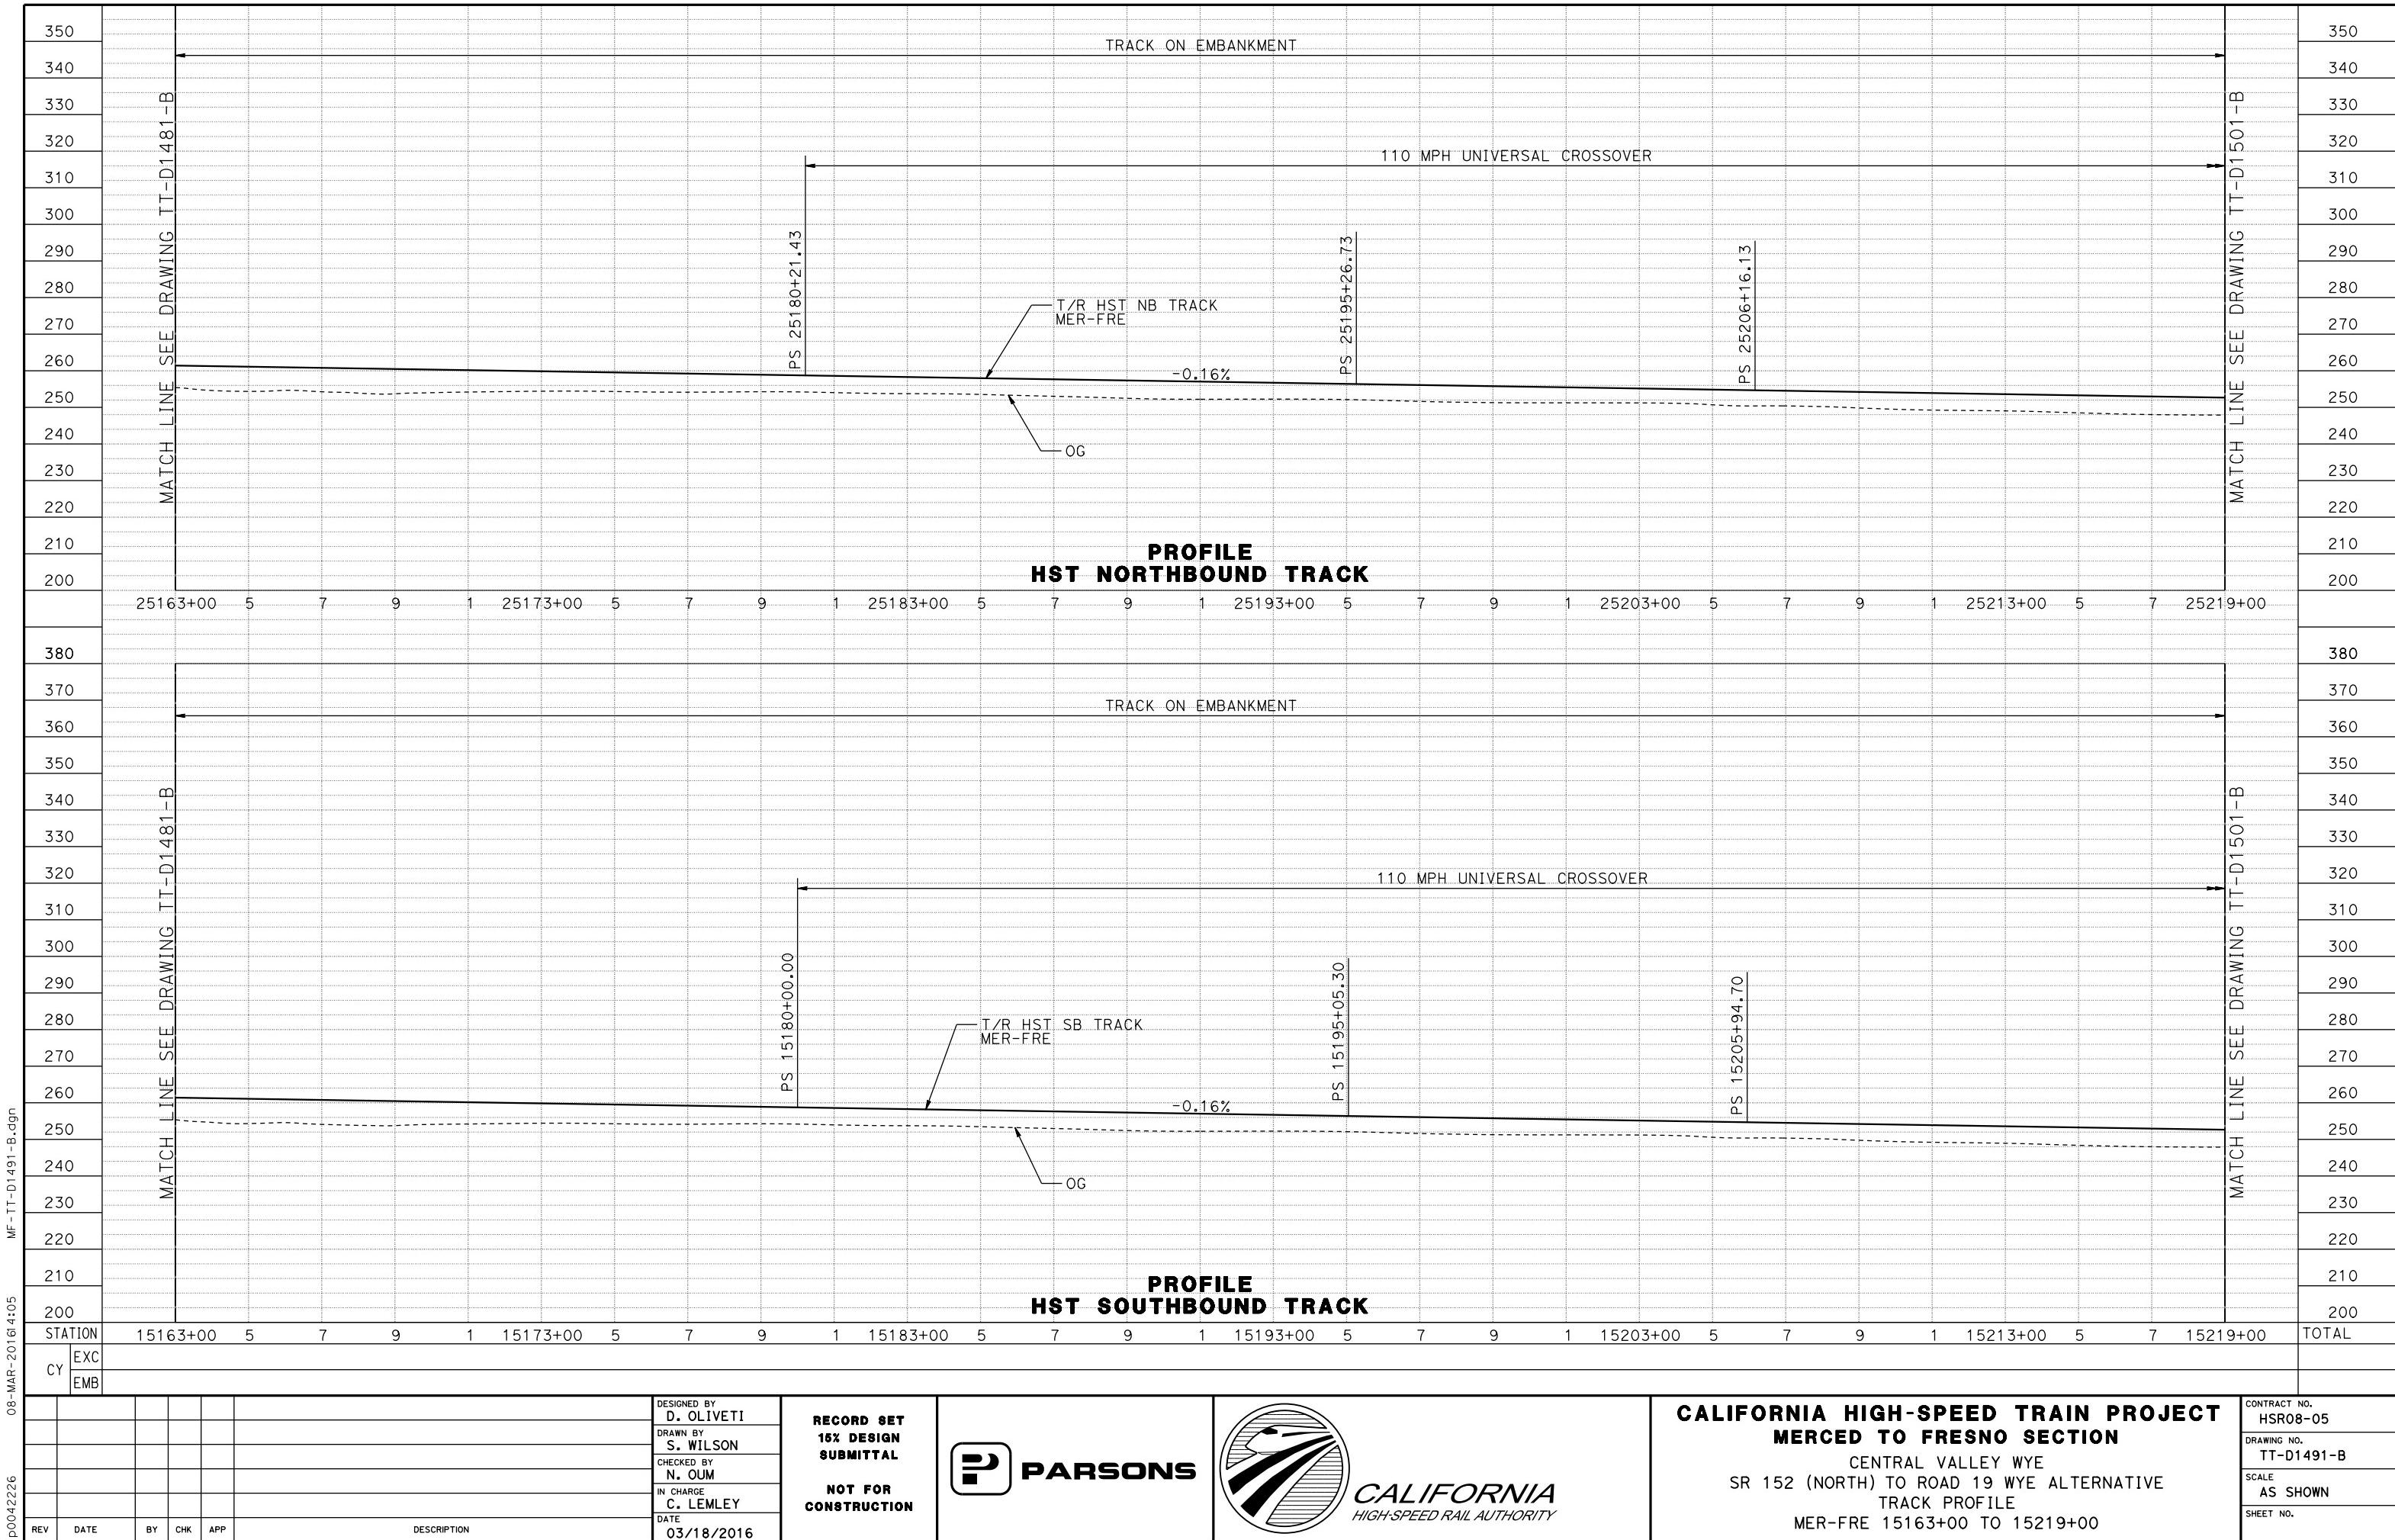

MERCED COUNTY

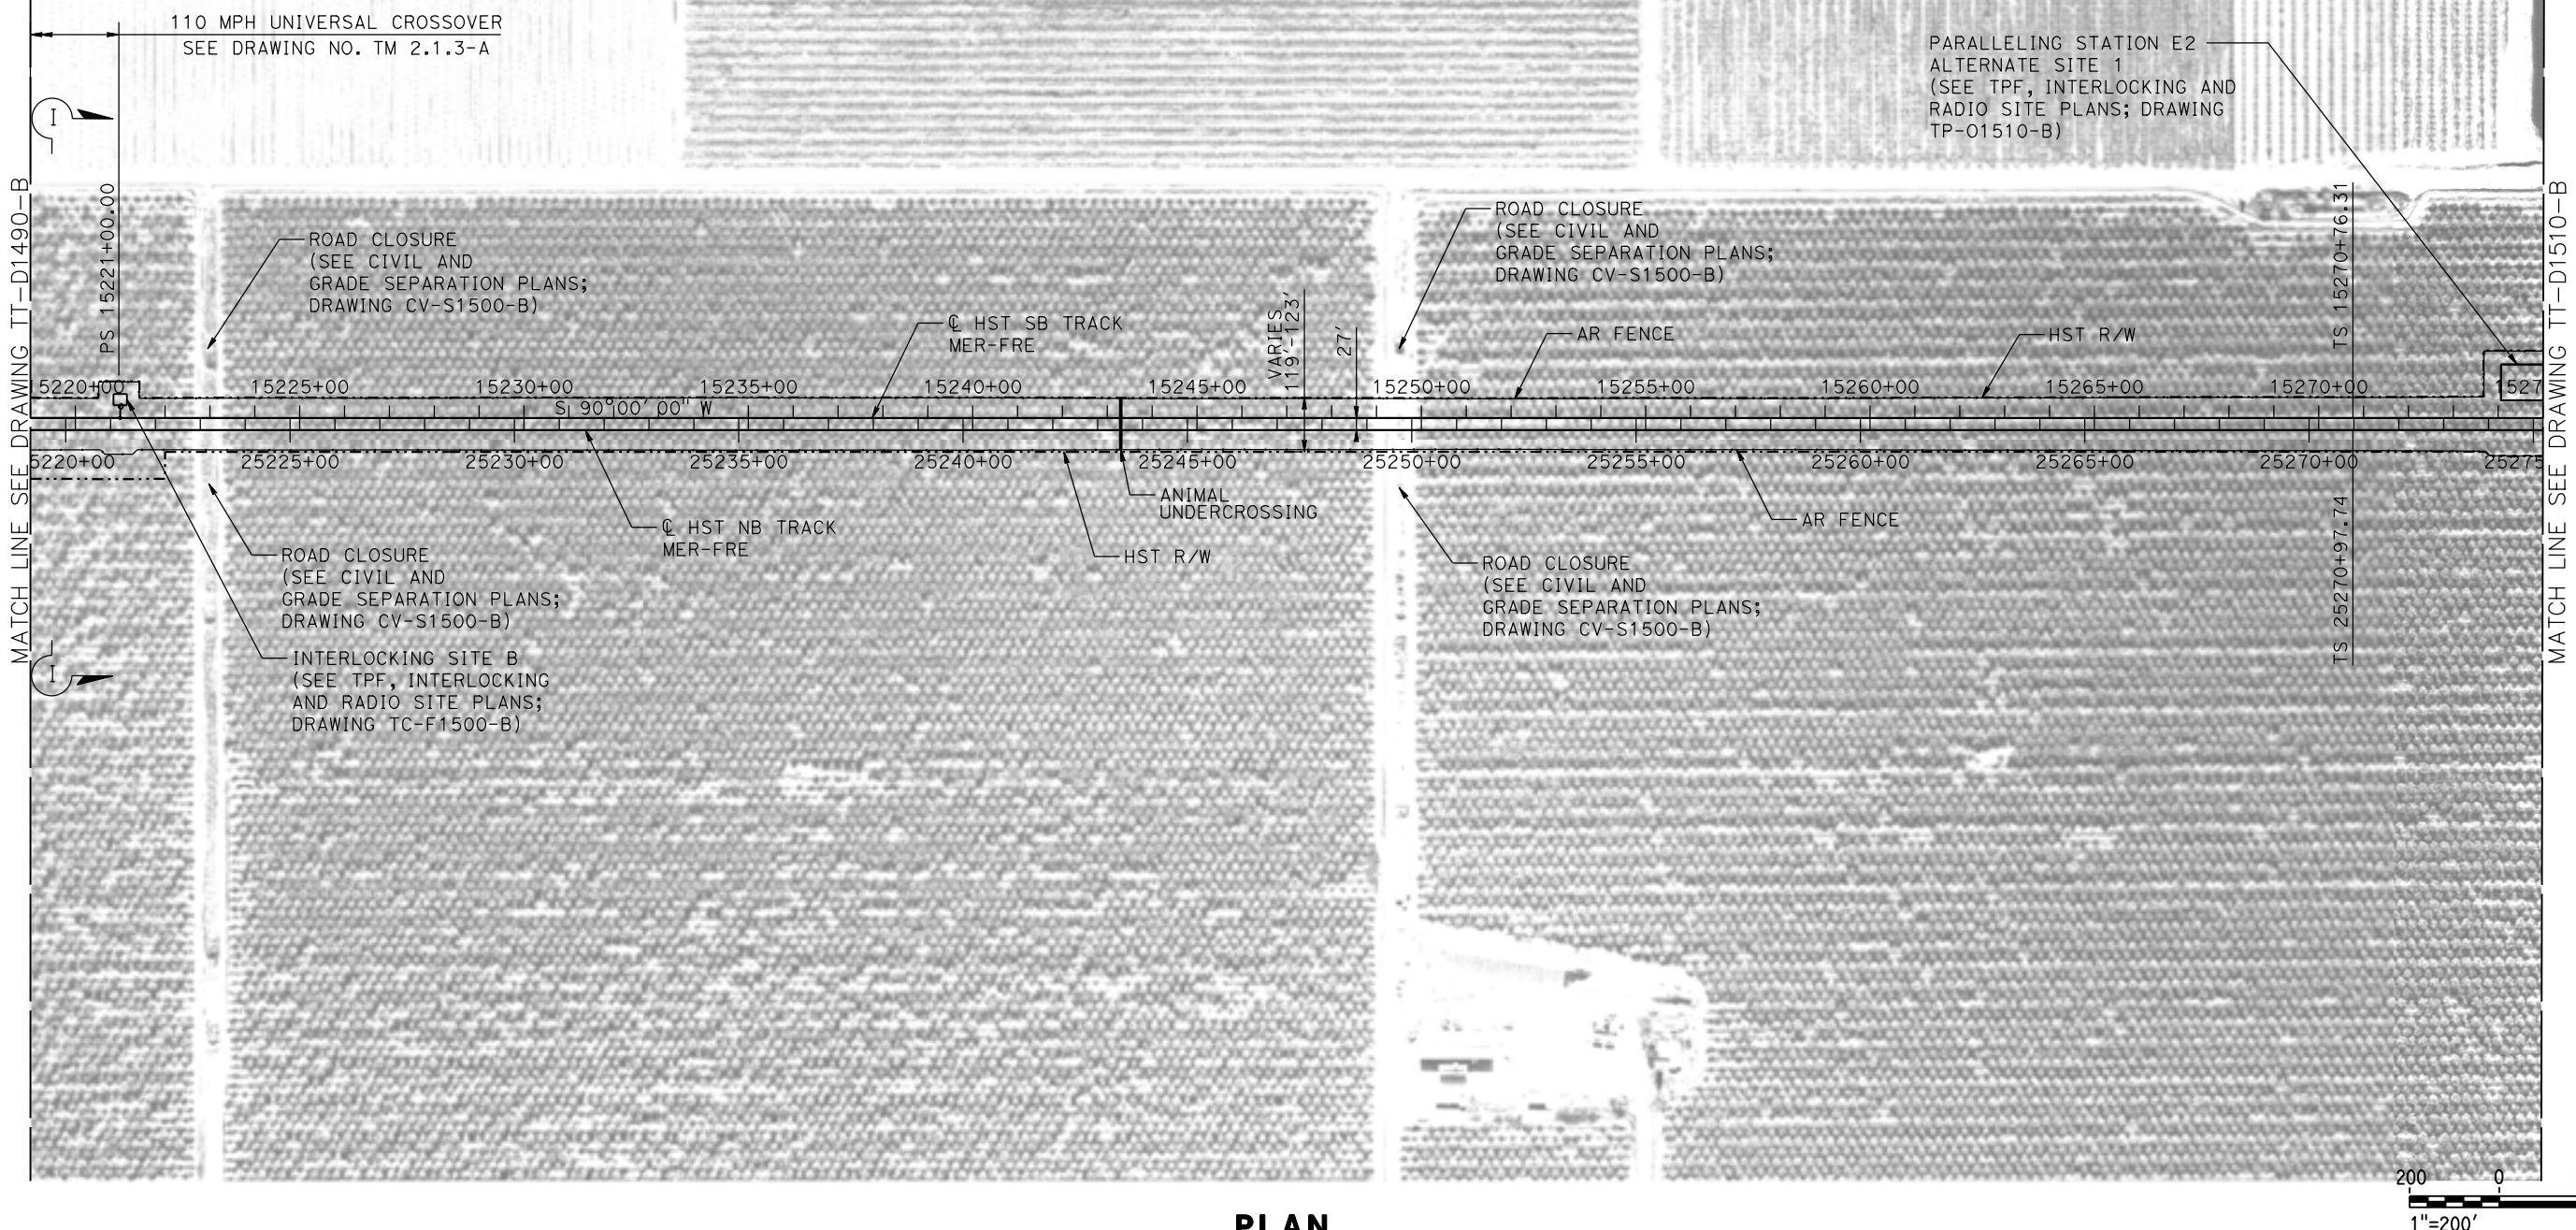

MF-TT-D1500-B.dgn

17-MAR-2016 1:30

p00513A


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					DRAWN BY S. WILSON
					CHECKED BY N. OUM
					IN CHARGE C. LEMLEY
					DATE 03/18/2016
REV	DATE	BY	CHK	APP	DESCRIPTION

RECORD SET
15% DESIGN
SUBMITTAL
**NOT FOR
CONSTRUCTION**




**CALIFORNIA HIGH-SPEED TRAIN PROJECT
MERCED TO FRESNO SECTION**
CENTRAL VALLEY WYE
SR 152 (NORTH) TO ROAD 19 WYE ALTERNATIVE
TRACK PLAN
MER-FRE 15219+00 TO 15275+00

CONTRACT NO.
HSR08-05
DRAWING NO.
TT-D1500-B
SCALE
AS SHOWN
SHEET NO.

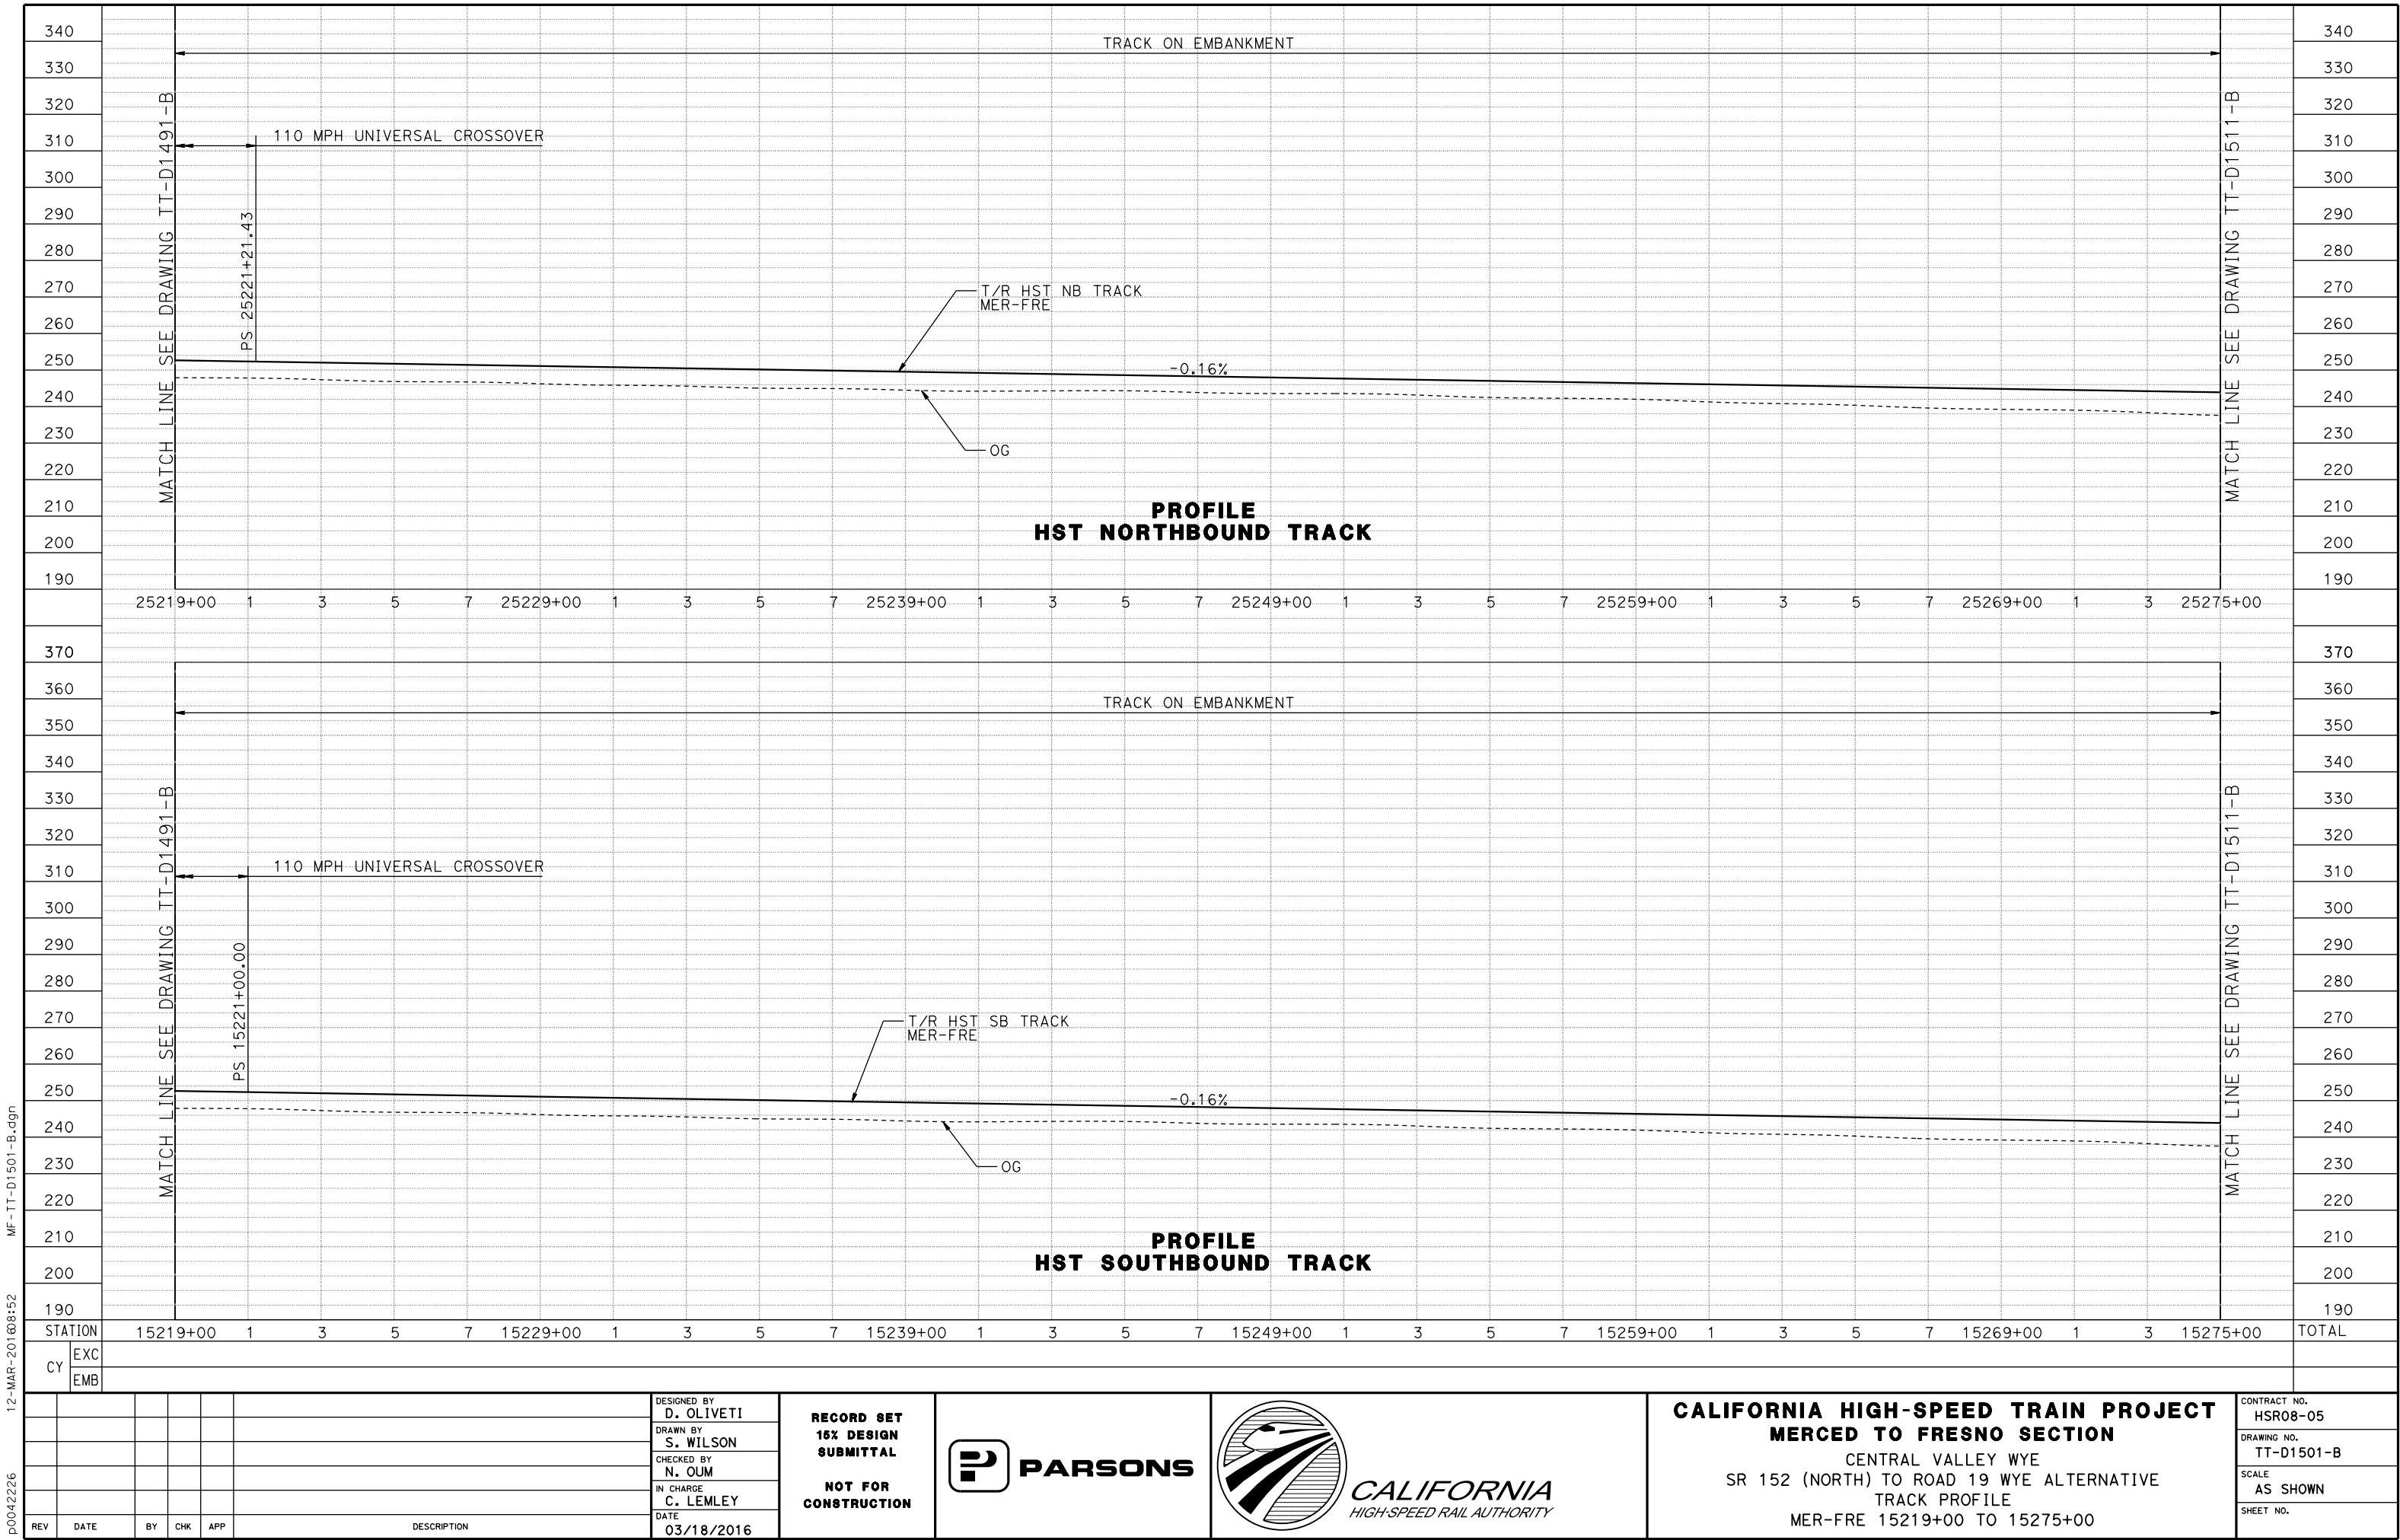

MERCED COUNTY

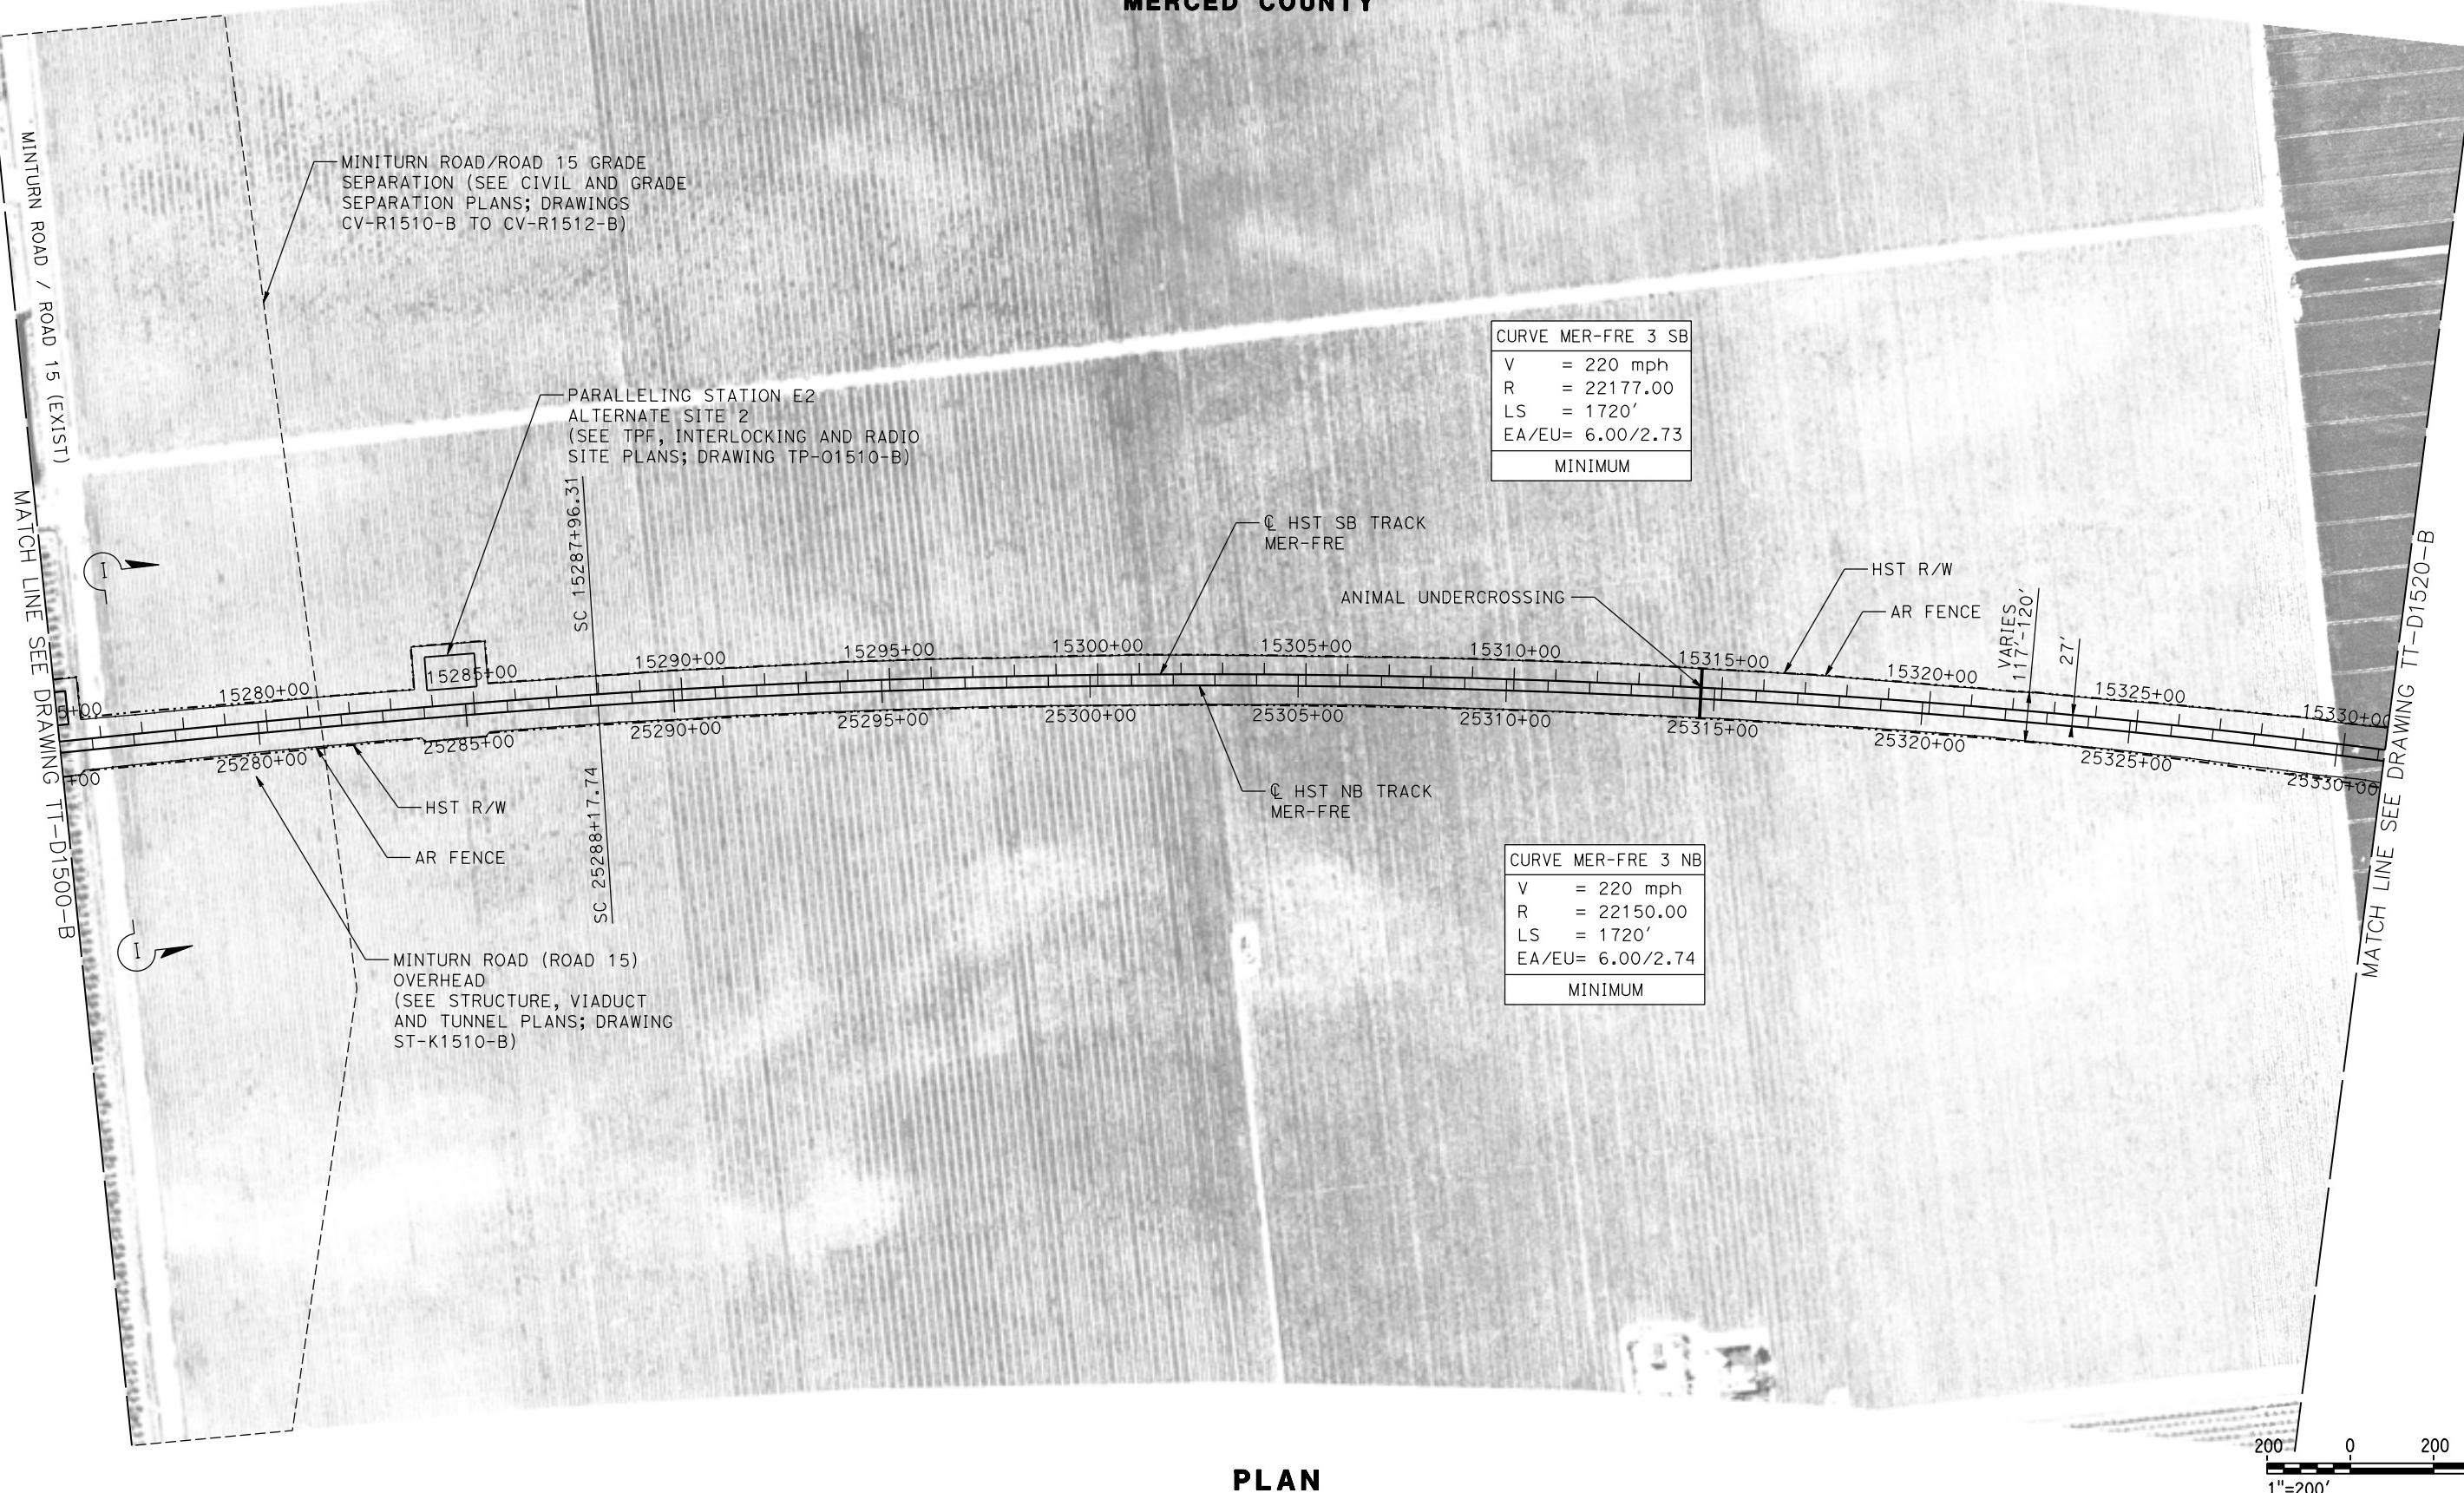

17-MAR-2016 1:31 MF-TT-D1510-B.dwg

REV	DATE	BY	CHK	APP	DESCRIPTION
					03/18/2016

DESIGNED BY
D. OLIVETI
DRAWN BY
S. WILSON
CHECKED BY
N. OUM
IN CHARGE
C. LEMLEY
DATE
03/18/2016


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15% DESIGN
SUBMITTAL


NOT FOR
CONSTRUCTION



CALIFORNIA HIGH-SPEED TRAIN PROJECT
MERCED TO FRESNO SECTION
CENTRAL VALLEY WYE
SR 152 (NORTH) TO ROAD 19 WYE ALTERNATIVE
TRACK PLAN
MER-FRE STA 15275+00.00 TO 15331+00.00

CONTRACT NO.
HSR08-05
DRAWING NO.
TT-D1510-B
SCALE
AS SHOWN
SHEET NO.

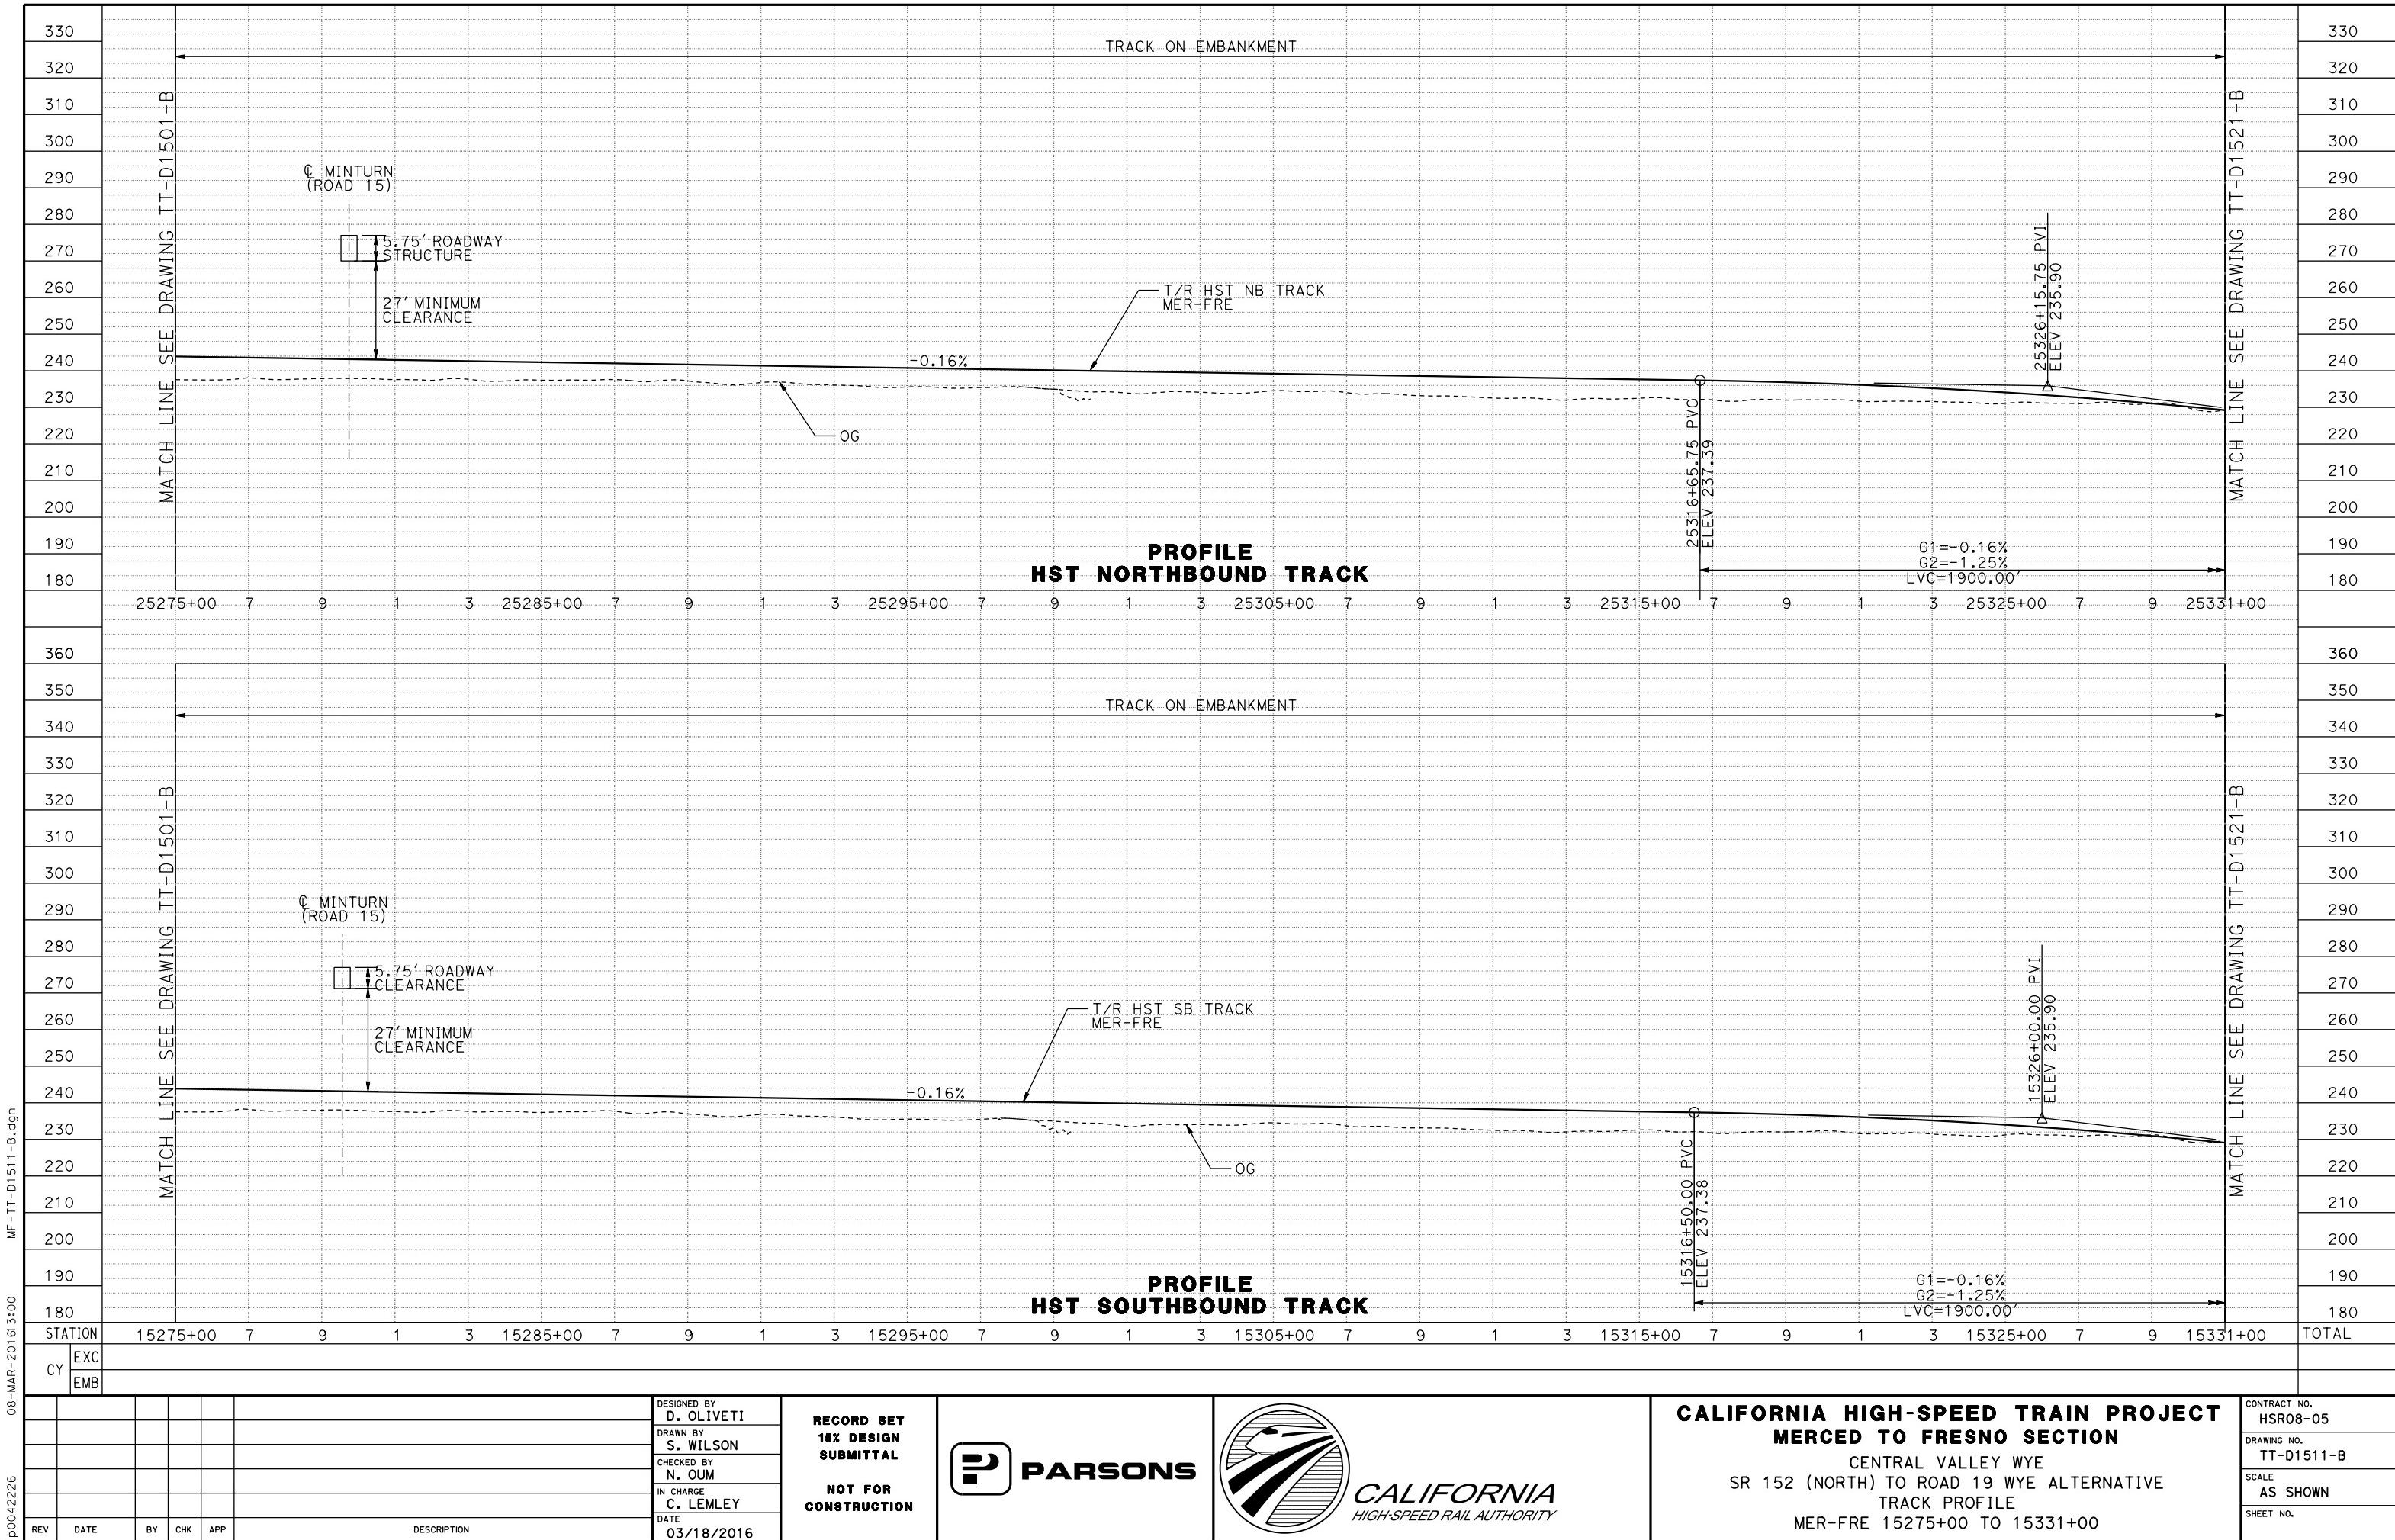

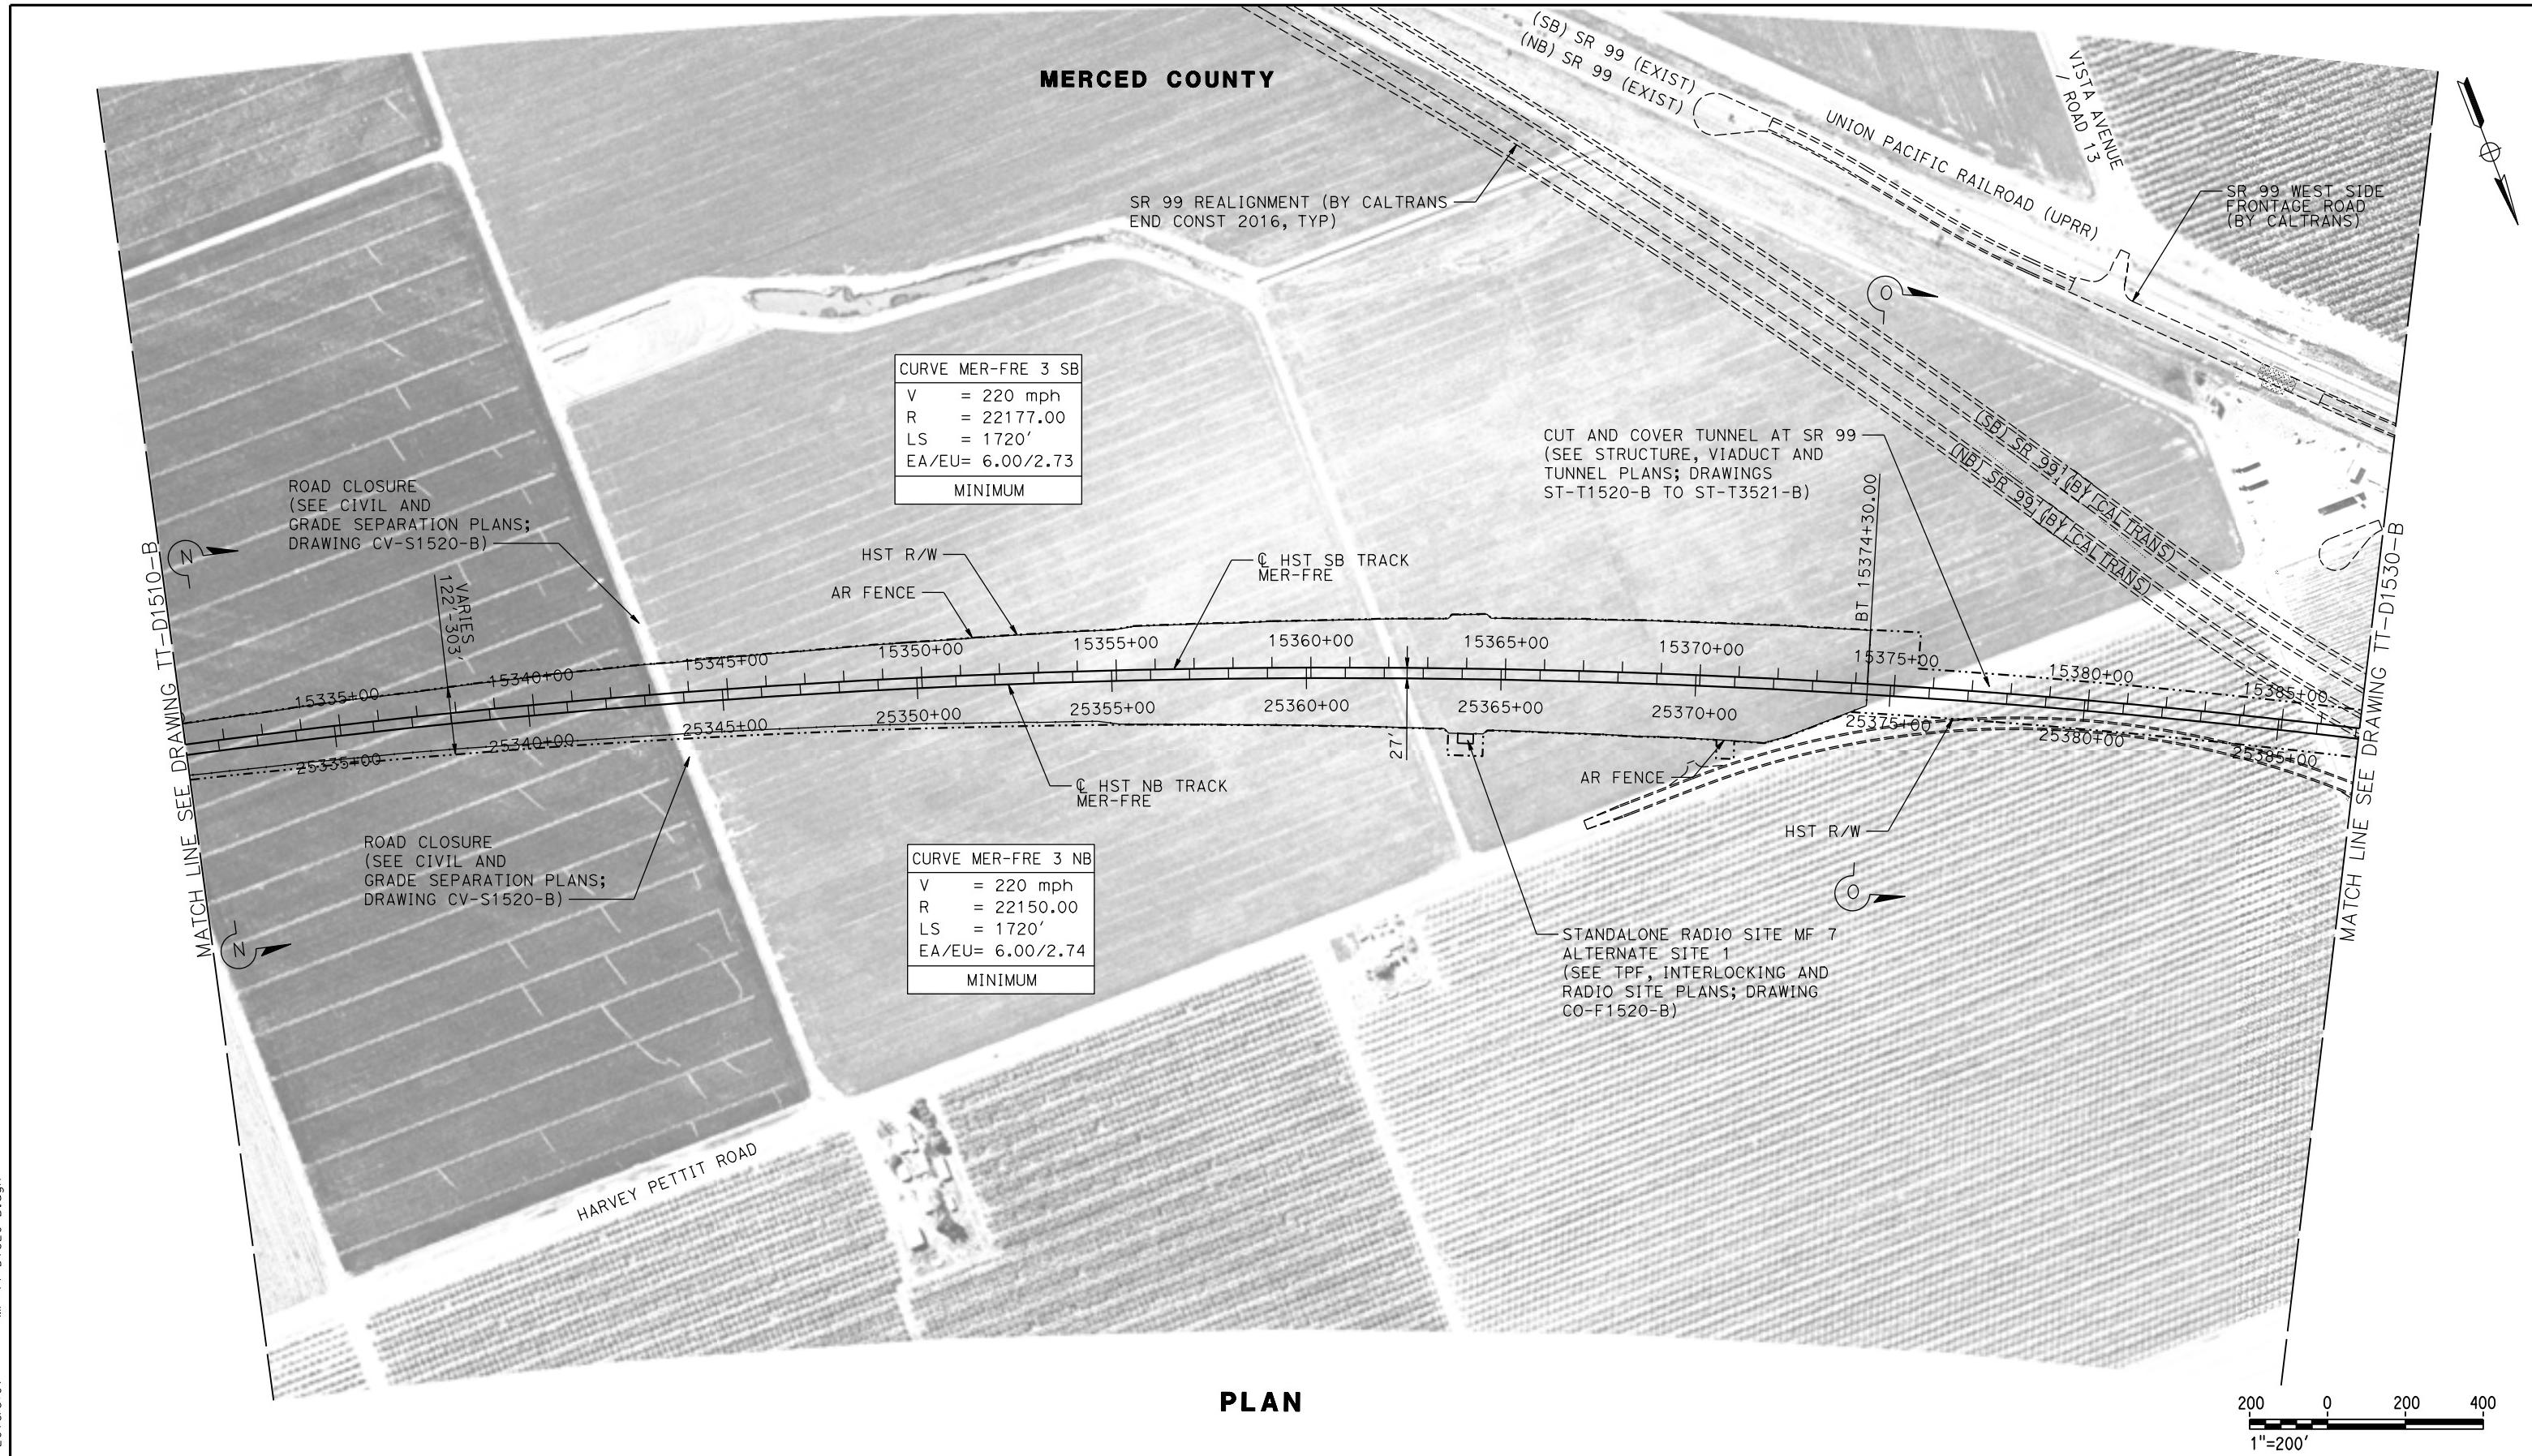

					DESIGNED BY D. OLIVETI
					DRAWN BY S. WILSON
					CHECKED BY N. OUM
					IN CHARGE C. LEMLEY
					DATE 03/18/2016
REV	DATE	BY	CHK	APP	DESCRIPTION

RECORD SET
15% DESIGN
SUBMITTAL
**NOT FOR
CONSTRUCTION**




PARSONS



CALIFORNIA
HIGH-SPEED RAIL AUTHORITY

**CALIFORNIA HIGH-SPEED TRAIN PROJECT
MERCED TO FRESNO SECTION**
CENTRAL VALLEY WYE
SR 152 (NORTH) TO ROAD 19 WYE ALTERNATIVE
TRACK PLAN
MER-FRE15331+00 - 15387+00

CONTRACT NO.
HSR08-05
DRAWING NO.
TT-D1520-B
SCALE
AS SHOWN
SHEET NO.

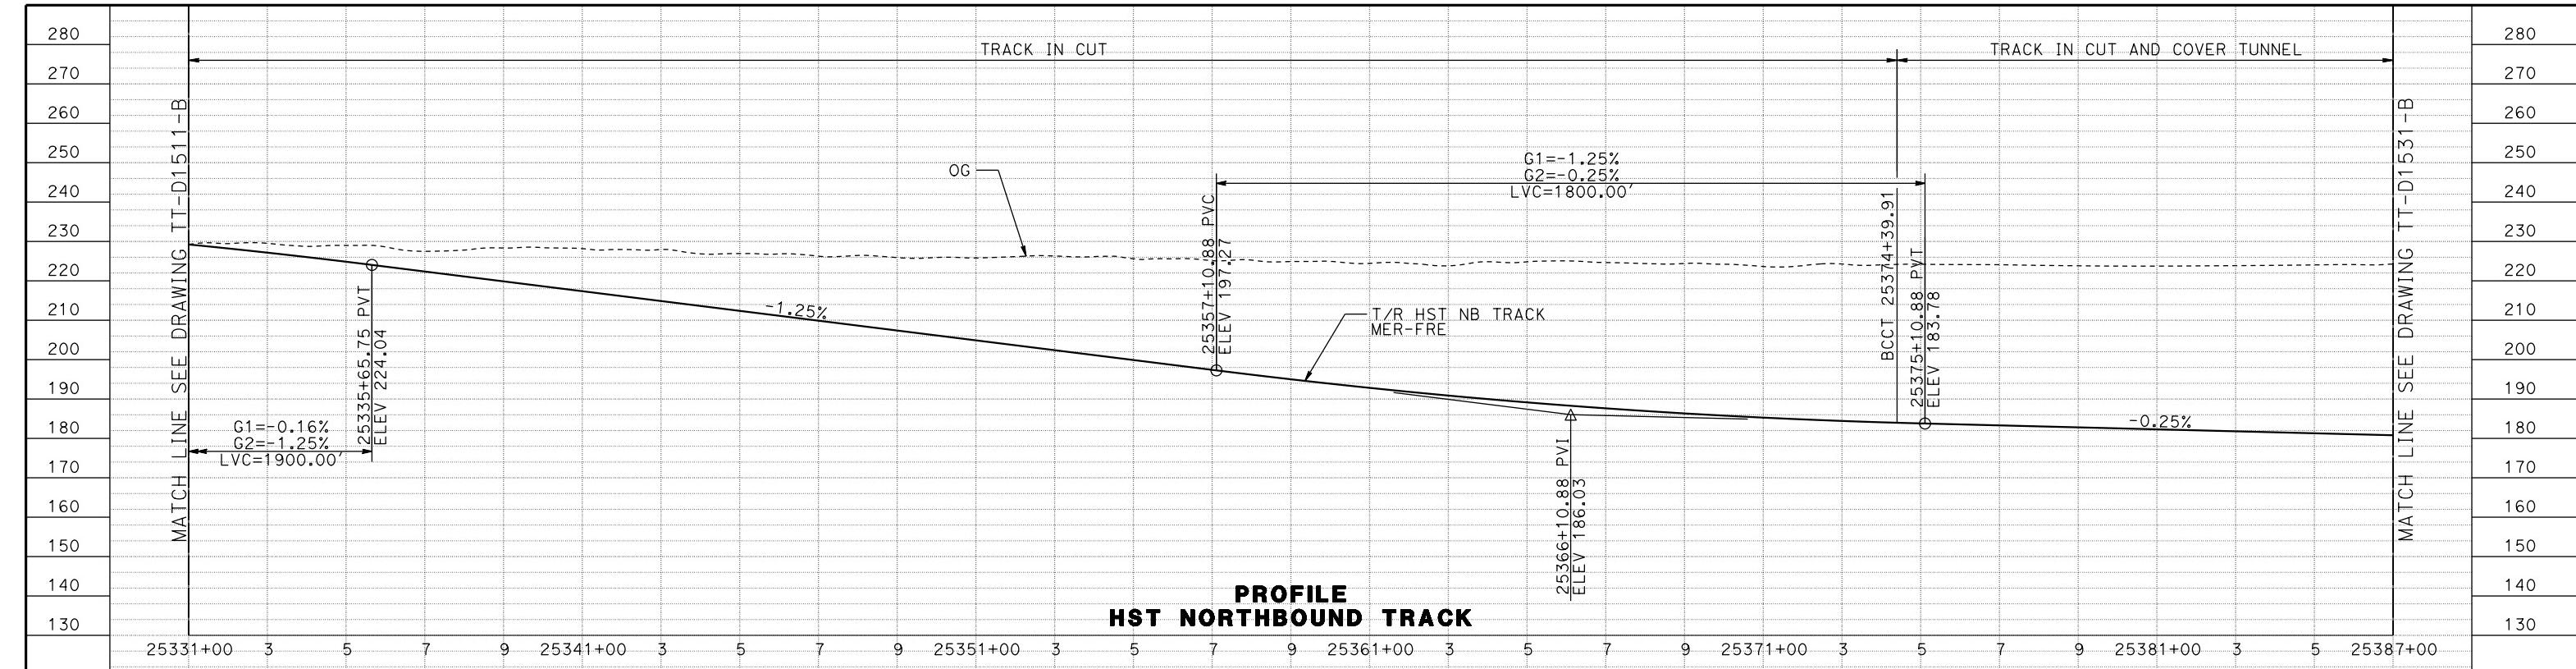

MF - TT-01521-B.dwg

08-MAR-2016 3:01

p004226

REV

DATE

BY

CHK



APP

DESCRIPTION

DESIGNED BY
D. OLIVETI
DRAWN BY
S. WILSON
CHECKED BY
N. OUM
IN CHARGE
C. LEMLEY
DATE
03/18/2016RECORD SET
15% DESIGN
SUBMITTAL
NOT FOR
CONSTRUCTION

CALIFORNIA HIGH-SPEED TRAIN PROJECT
MERCED TO FRESNO SECTION
CENTRAL VALLEY WYE
SR 152 (NORTH) TO ROAD 19 WYE ALTERNATIVE
TRACK PROFILE
MER-FRE 15331+00 TO 15387+00

CONTRACT NO.
HSR08-05
DRAWING NO.
TT-D1521-B
SCALE
AS SHOWN
SHEET NO.

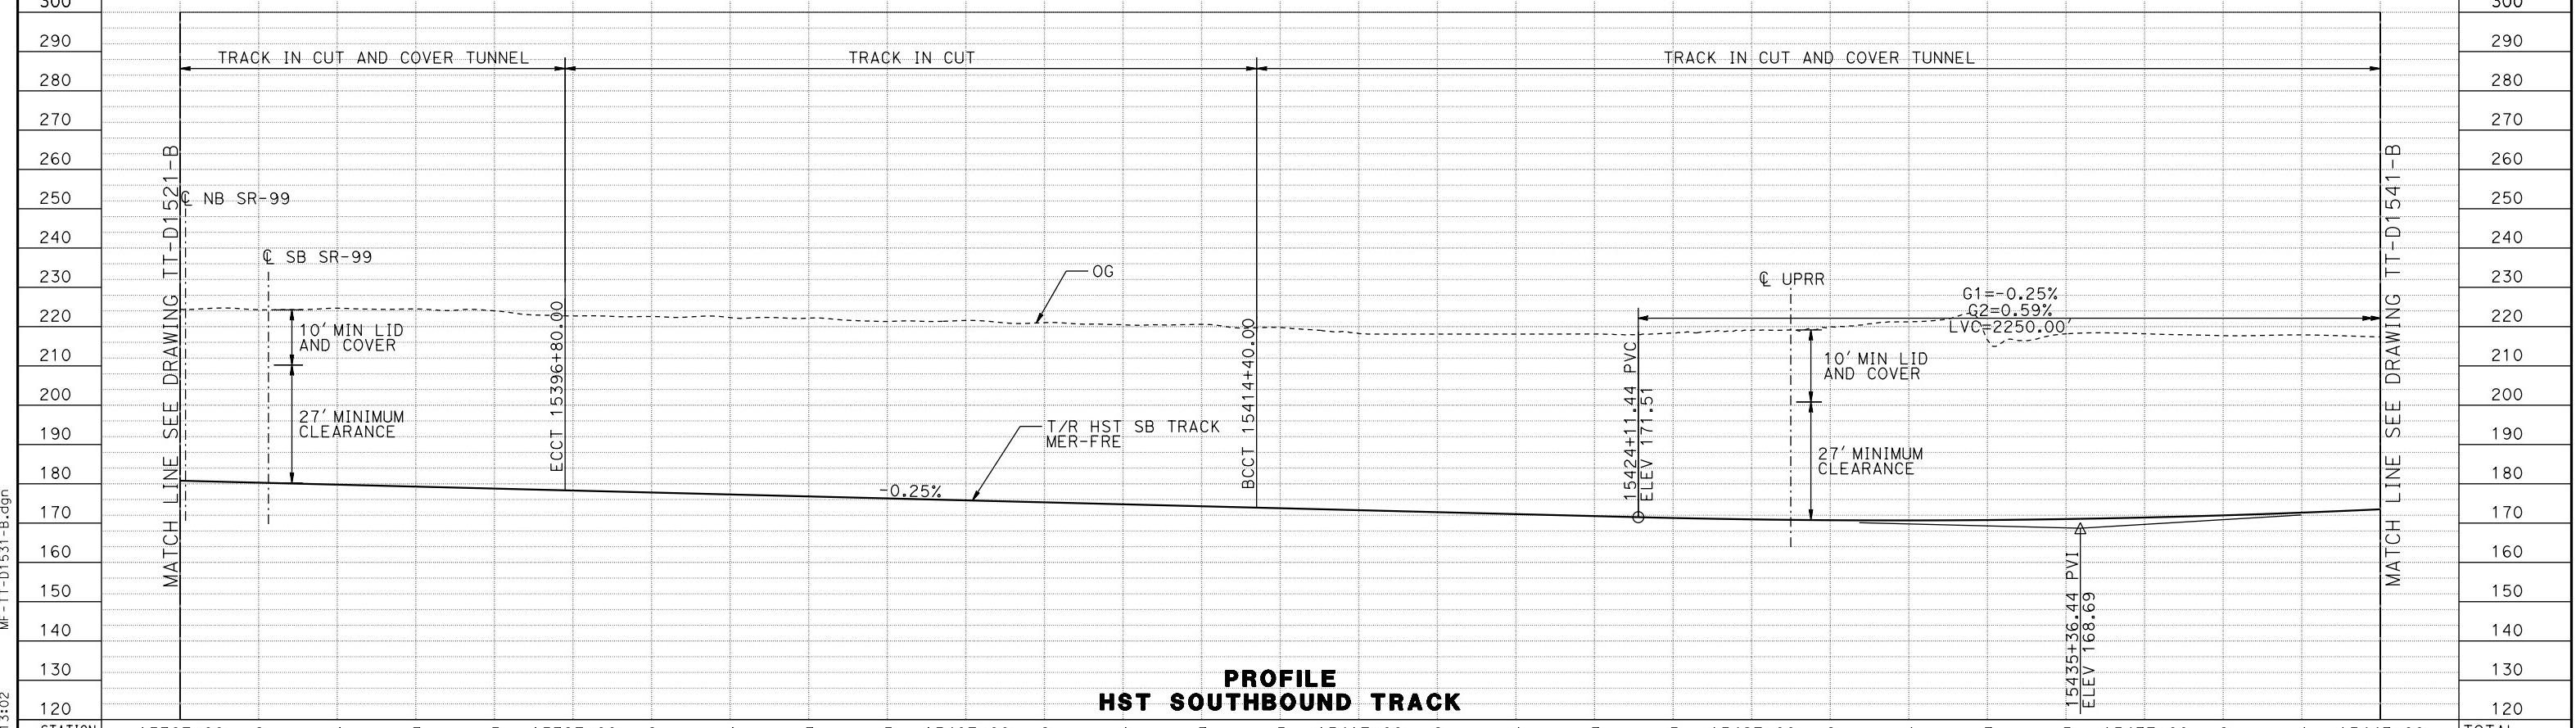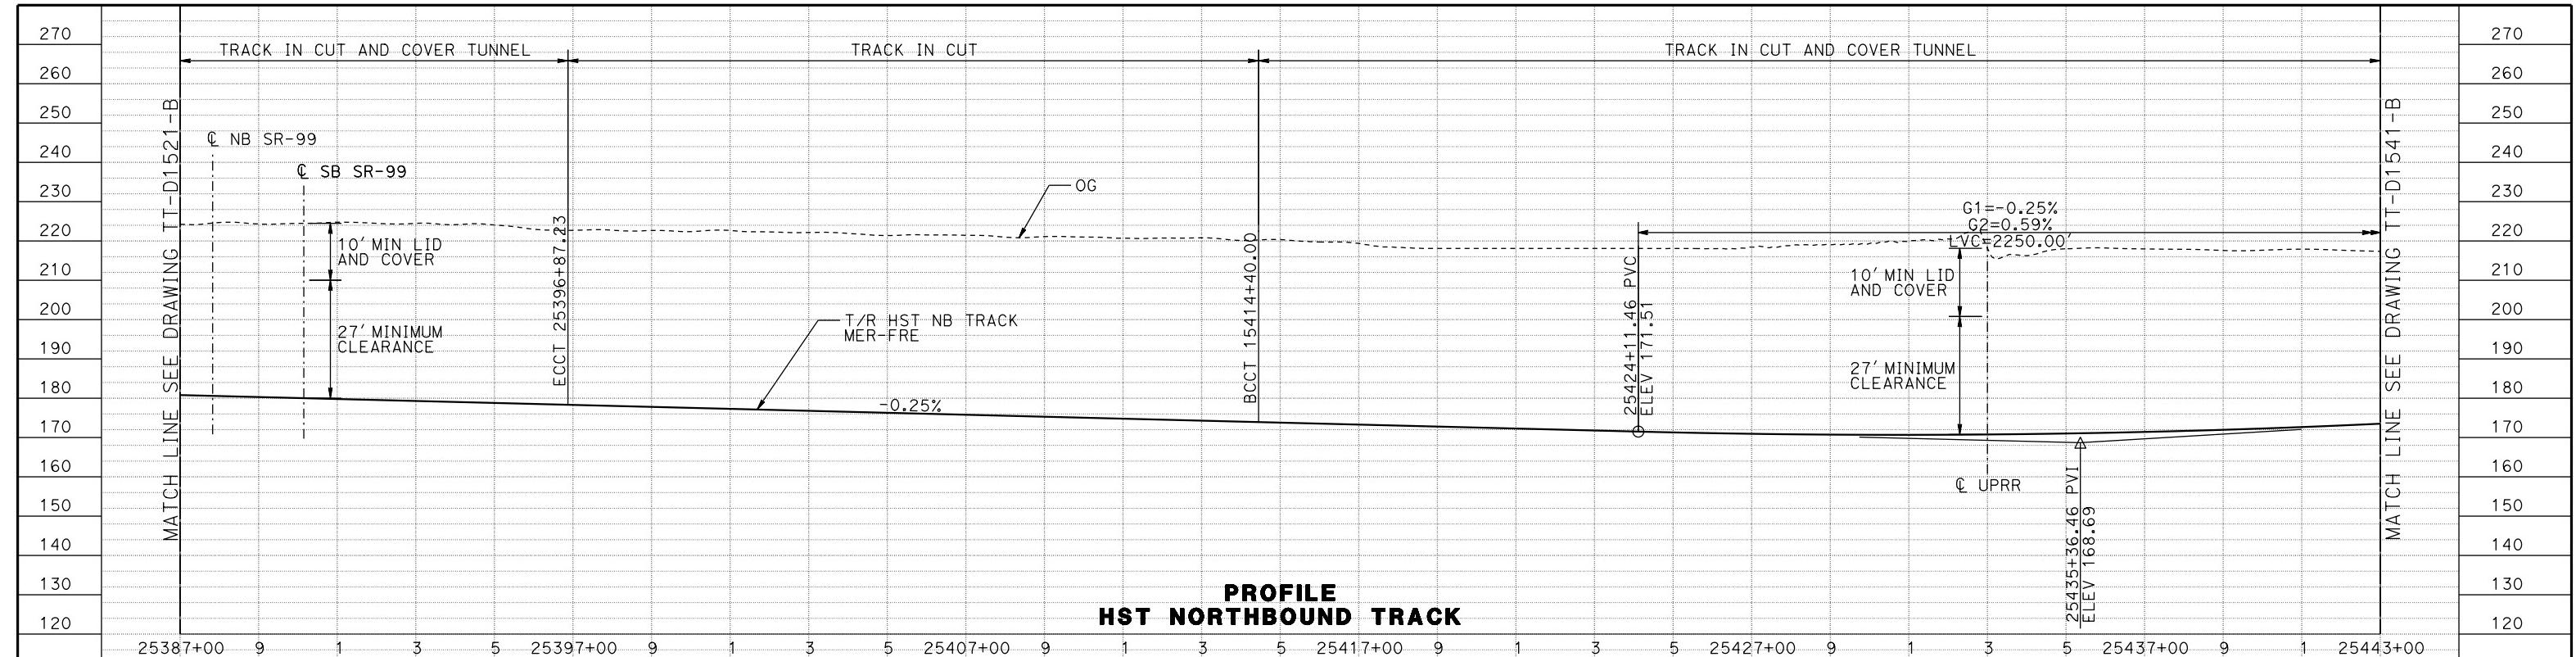

MARCH-2016	STATION		15387+00	9	1	3	5	15397+00	9	1	3	5	15407+00	9	1	3	5	15417+00	9	1	3	5	15427+00	9	1	3	5	15437+00	9	1	15443+00	TOTAL
	CY	EXC																														
		EMB																														

08
P0042226

DESIGNED BY
D. OLIVETI
DRAWN BY
S. WILSON
CHECKED BY
N. OUM
IN CHARGE
C. LEMLEY
DATE
03/18/2016


RECORD SET
15% DESIGN
SUBMITTAL
NOT FOR
CONSTRUCTION

**CALIFORNIA HIGH-SPEED TRAIN PROJECT
MERCED TO FRESNO SECTION**

CENTRAL VALLEY WYE
SR 152 (NORTH) TO ROAD 19 WYE ALTERNATIVE
TRACK PROFILE
MER-FRE 15387+00 TO 15443+00

CONTRACT NO.
HSR08-05
DRAWING NO.
TT-D1531-B
SCALE
AS SHOWN
SHEET NO.

MERCED COUNTY

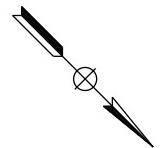

CURVE MER-FRE 4 SB
V = 220 mph
R = 867000.00
LS = 1000'
EA/EU= 0.25/0.00
DESIRABLE

DUTCHMAN CREEK

PG&E HV SWITCHING STATION ALTERNATE SITE 1
(BY OTHERS) (SEE TPF, INTERLOCKING AND
RADIO SITE PLANS; DRAWING TP-01540-B)

SUBSTATION E (SANDY MUSH)
ALTERNATE SITE 1 (SEE TPF,
INTERLOCKING AND RADIO SITE
PLANS; DRAWING TP-01540-B)

ST 15463+81.44

TS 15473+81.44

BCCT 15473+88.00

IECCT 15475+68.00

SC 15483+81.44

CS 15493+81.98

15445+00

15450+00

15455+00

15460+00

15465+00

15470+00

15475+00

15480+00

15485+00

15490+00

15495+00

15445+00

15450+00

15455+00

15460+00

15465+00

15470+00

15475+00

15480+00

15485+00

15490+00

15495+00

MATCH LINE SEE DRAWING TT-D1530-B

CS 15446+61.44

ECCT 15443+50.00

Z

15445+00

15450+00

15455+00

15460+00

15465+00

15470+00

15475+00

15480+00

15485+00

15490+00

15495+00

140+00

145+00

150+00

27'

VARIES
102'-330'

N 44°34' 03" W

UNION PACIFIC RAILROAD (UPRR)

(SB) SR 99 (EXIST)

(NB) SR 99 (EXIST)

HST R/W

AR FENCE

SR 99 WEST SIDE
FRONTAGE ROAD
(BY CALTRANS)

SR 99
REALIGNMENT (BY
CALTRANS END
CONST 2016, TYP)

PLAINSBURG ROAD
INTERCHANGE (BY
CALTRANS)

SR 99 EAST SIDE FRONTAGE
ROAD (BY CALTRANS)

(SB) SR 99 (BY CALTRANS)

(NB) SR 99 (BY CALTRANS)

200

0

200

400

1"=200'

PLAN

MF-TT-01540-B.dwg

10-MAR-2016 6:14

p004226

REV

DATE

BY

CHK


APP

DESIGNED BY
D. OLIVETI
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S. WILSON
CHECKED BY
N. OUM
IN CHARGE
C. LEMLEY
DATE
03/18/2016

RECORD SET
15% DESIGN
SUBMITTAL
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CONSTRUCTION



PARSONS

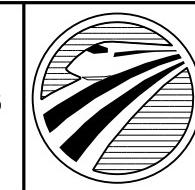


CALIFORNIA
HIGH-SPEED RAIL AUTHORITY

CALIFORNIA HIGH-SPEED TRAIN PROJECT
MERCED TO FRESNO SECTION

CENTRAL VALLEY WYE
SR 152 (NORTH) TO ROAD 19 WYE ALTERNATIVE
TRACK PLAN
MER-FRE 15443+00 TO 15499+00

CONTRACT NO.
HSR08-05
DRAWING NO.
TT-D1540-B
SCALE
AS SHOWN
SHEET NO.

MERCED COUNTY

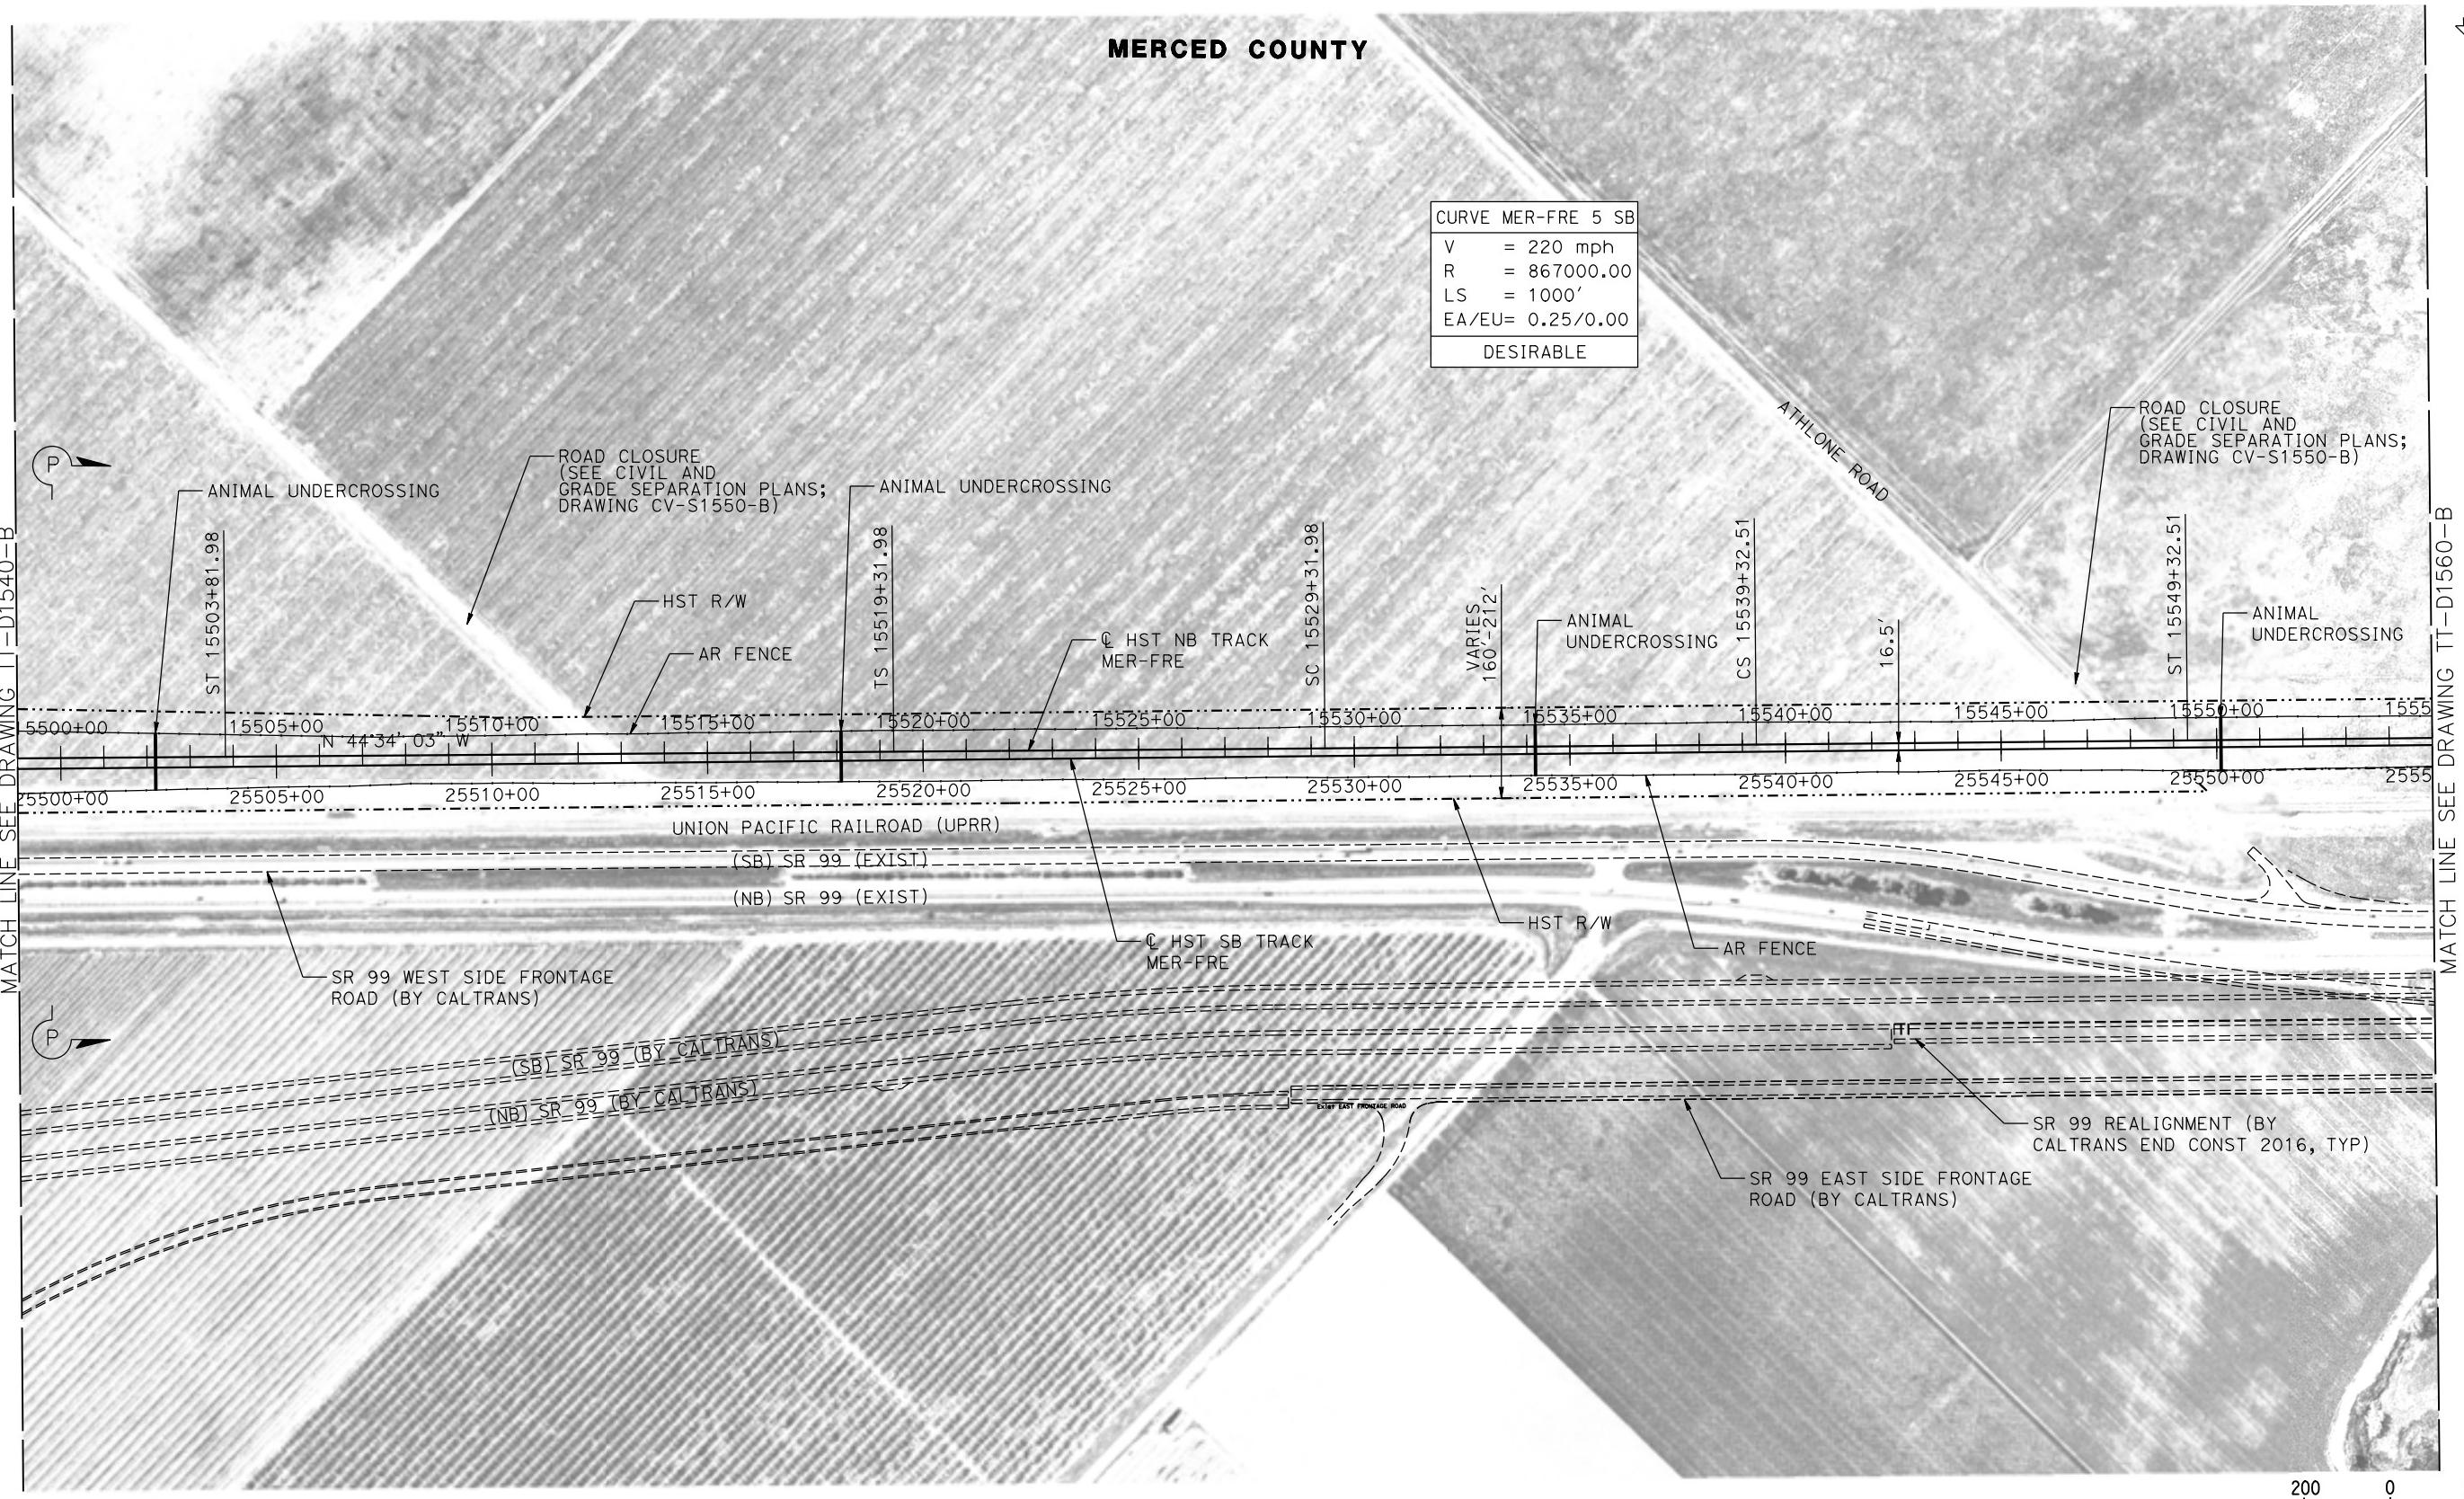


17-MAR-2016 1:31 MF-TT-01550-B.dgn

REV	DATE	BY	CHK	APP	DESCRIPTION
					03/18/2016

DESIGNED BY D. OLIVETI	RECORD SET 15% DESIGN SUBMITTAL
DRAWN BY S. WILSON	
CHECKED BY N. OUM	
IN CHARGE C. LEMLEY	
DATE 03/18/2016	NOT FOR CONSTRUCTION




PARSONS

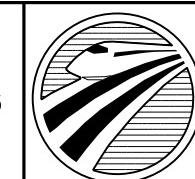



CALIFORNIA
HIGH-SPEED RAIL AUTHORITY


**CALIFORNIA HIGH-SPEED TRAIN PROJECT
MERCED TO FRESNO SECTION**
CENTRAL VALLEY WYE
SR 152 (NORTH) TO ROAD 19 WYE ALTERNATIVE
TRACK PLAN
MER-FRE 15499+00 TO 15555+00

CONTRACT NO.
HSR08-05
DRAWING NO.
TT-D1550-B
SCALE
AS SHOWN
SHEET NO.

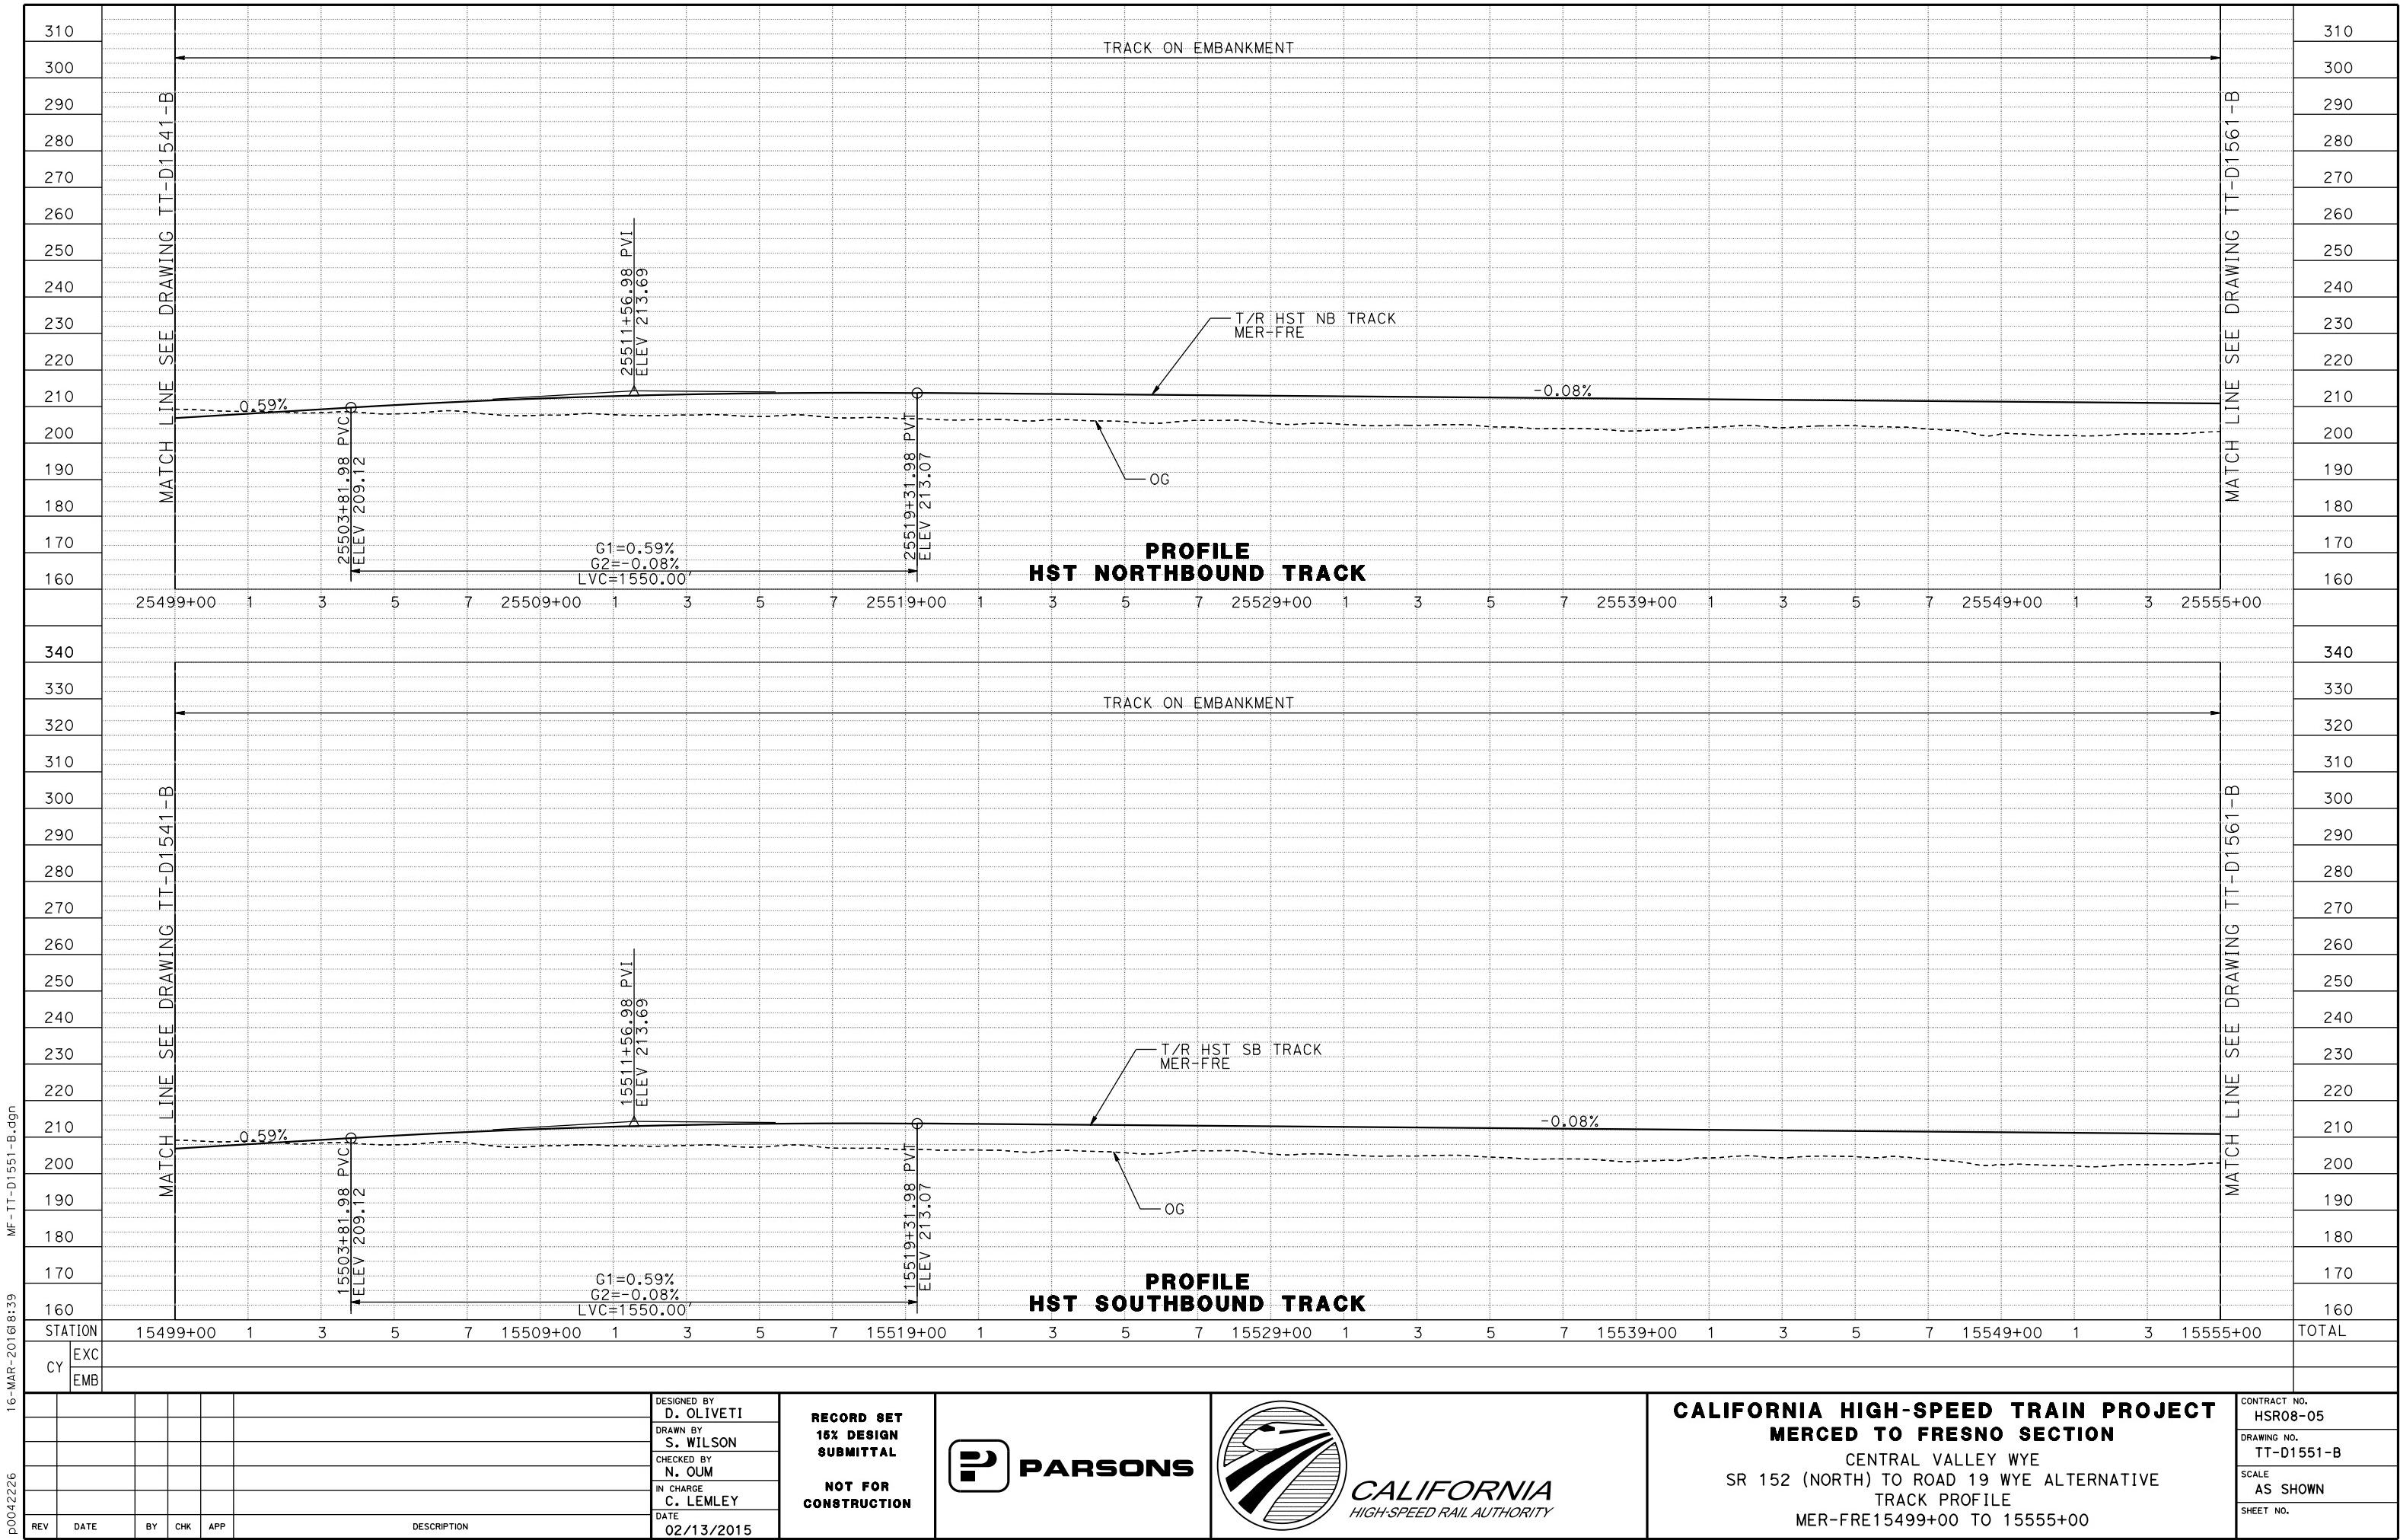


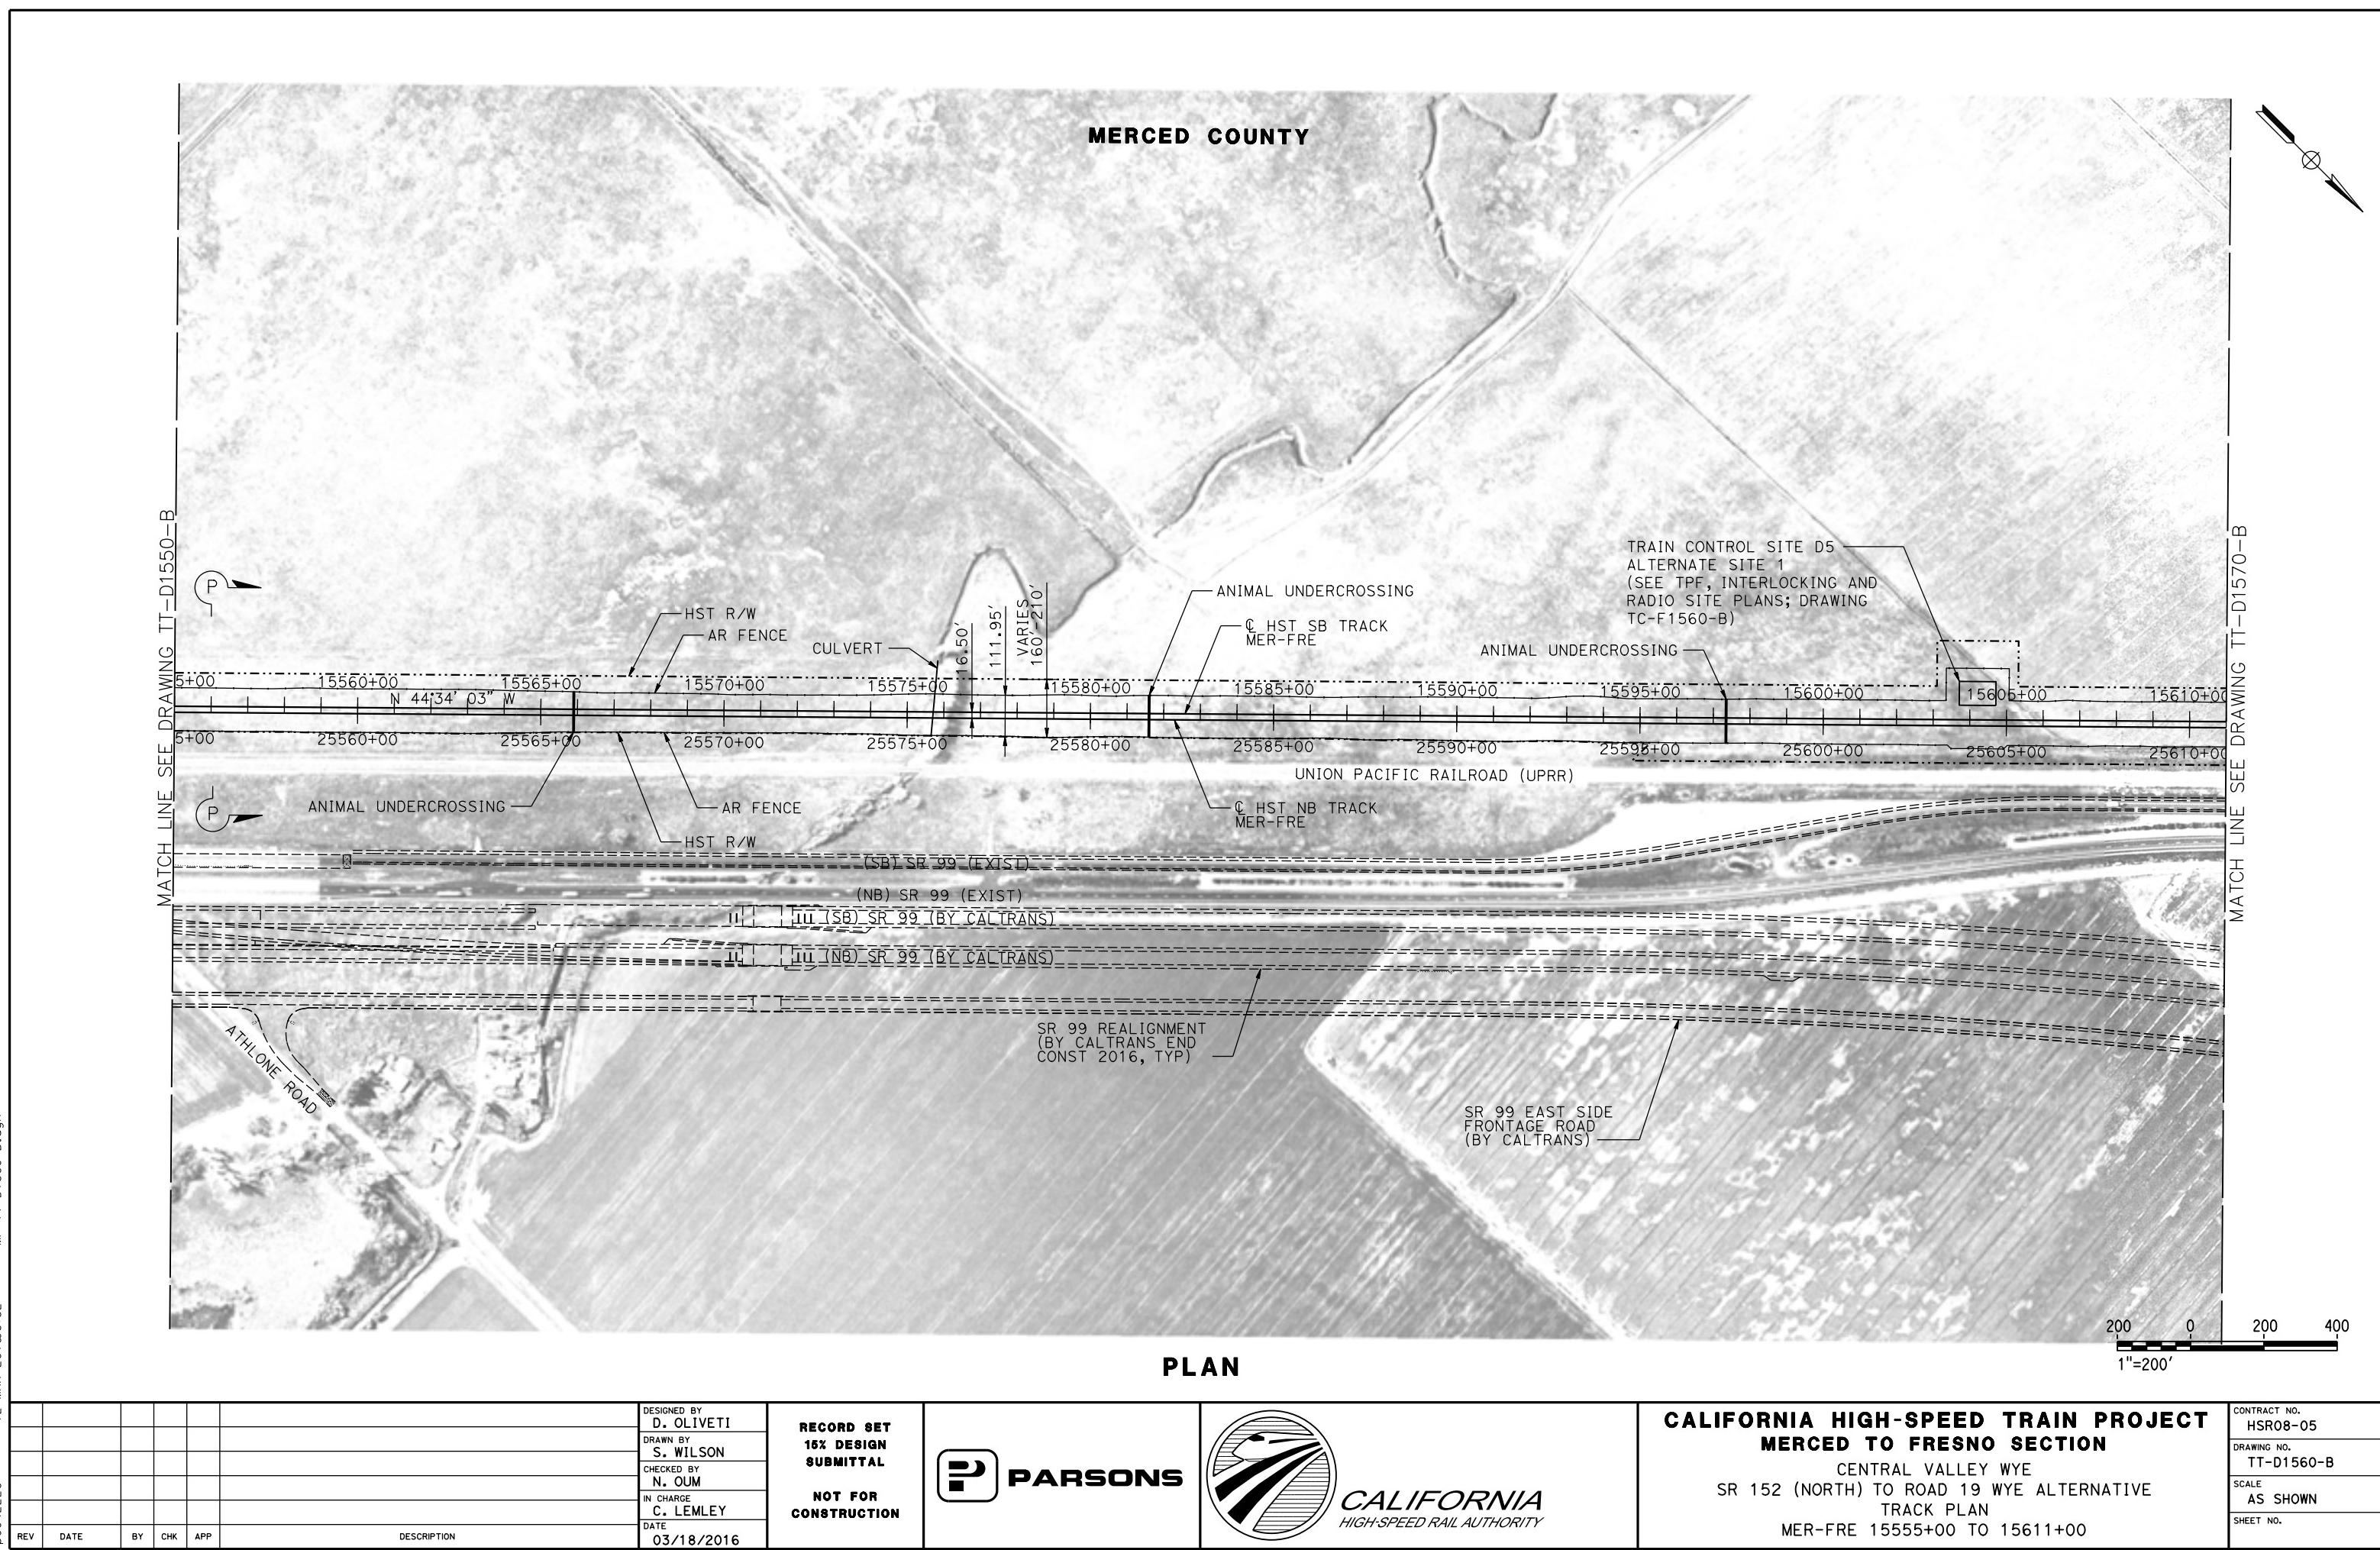

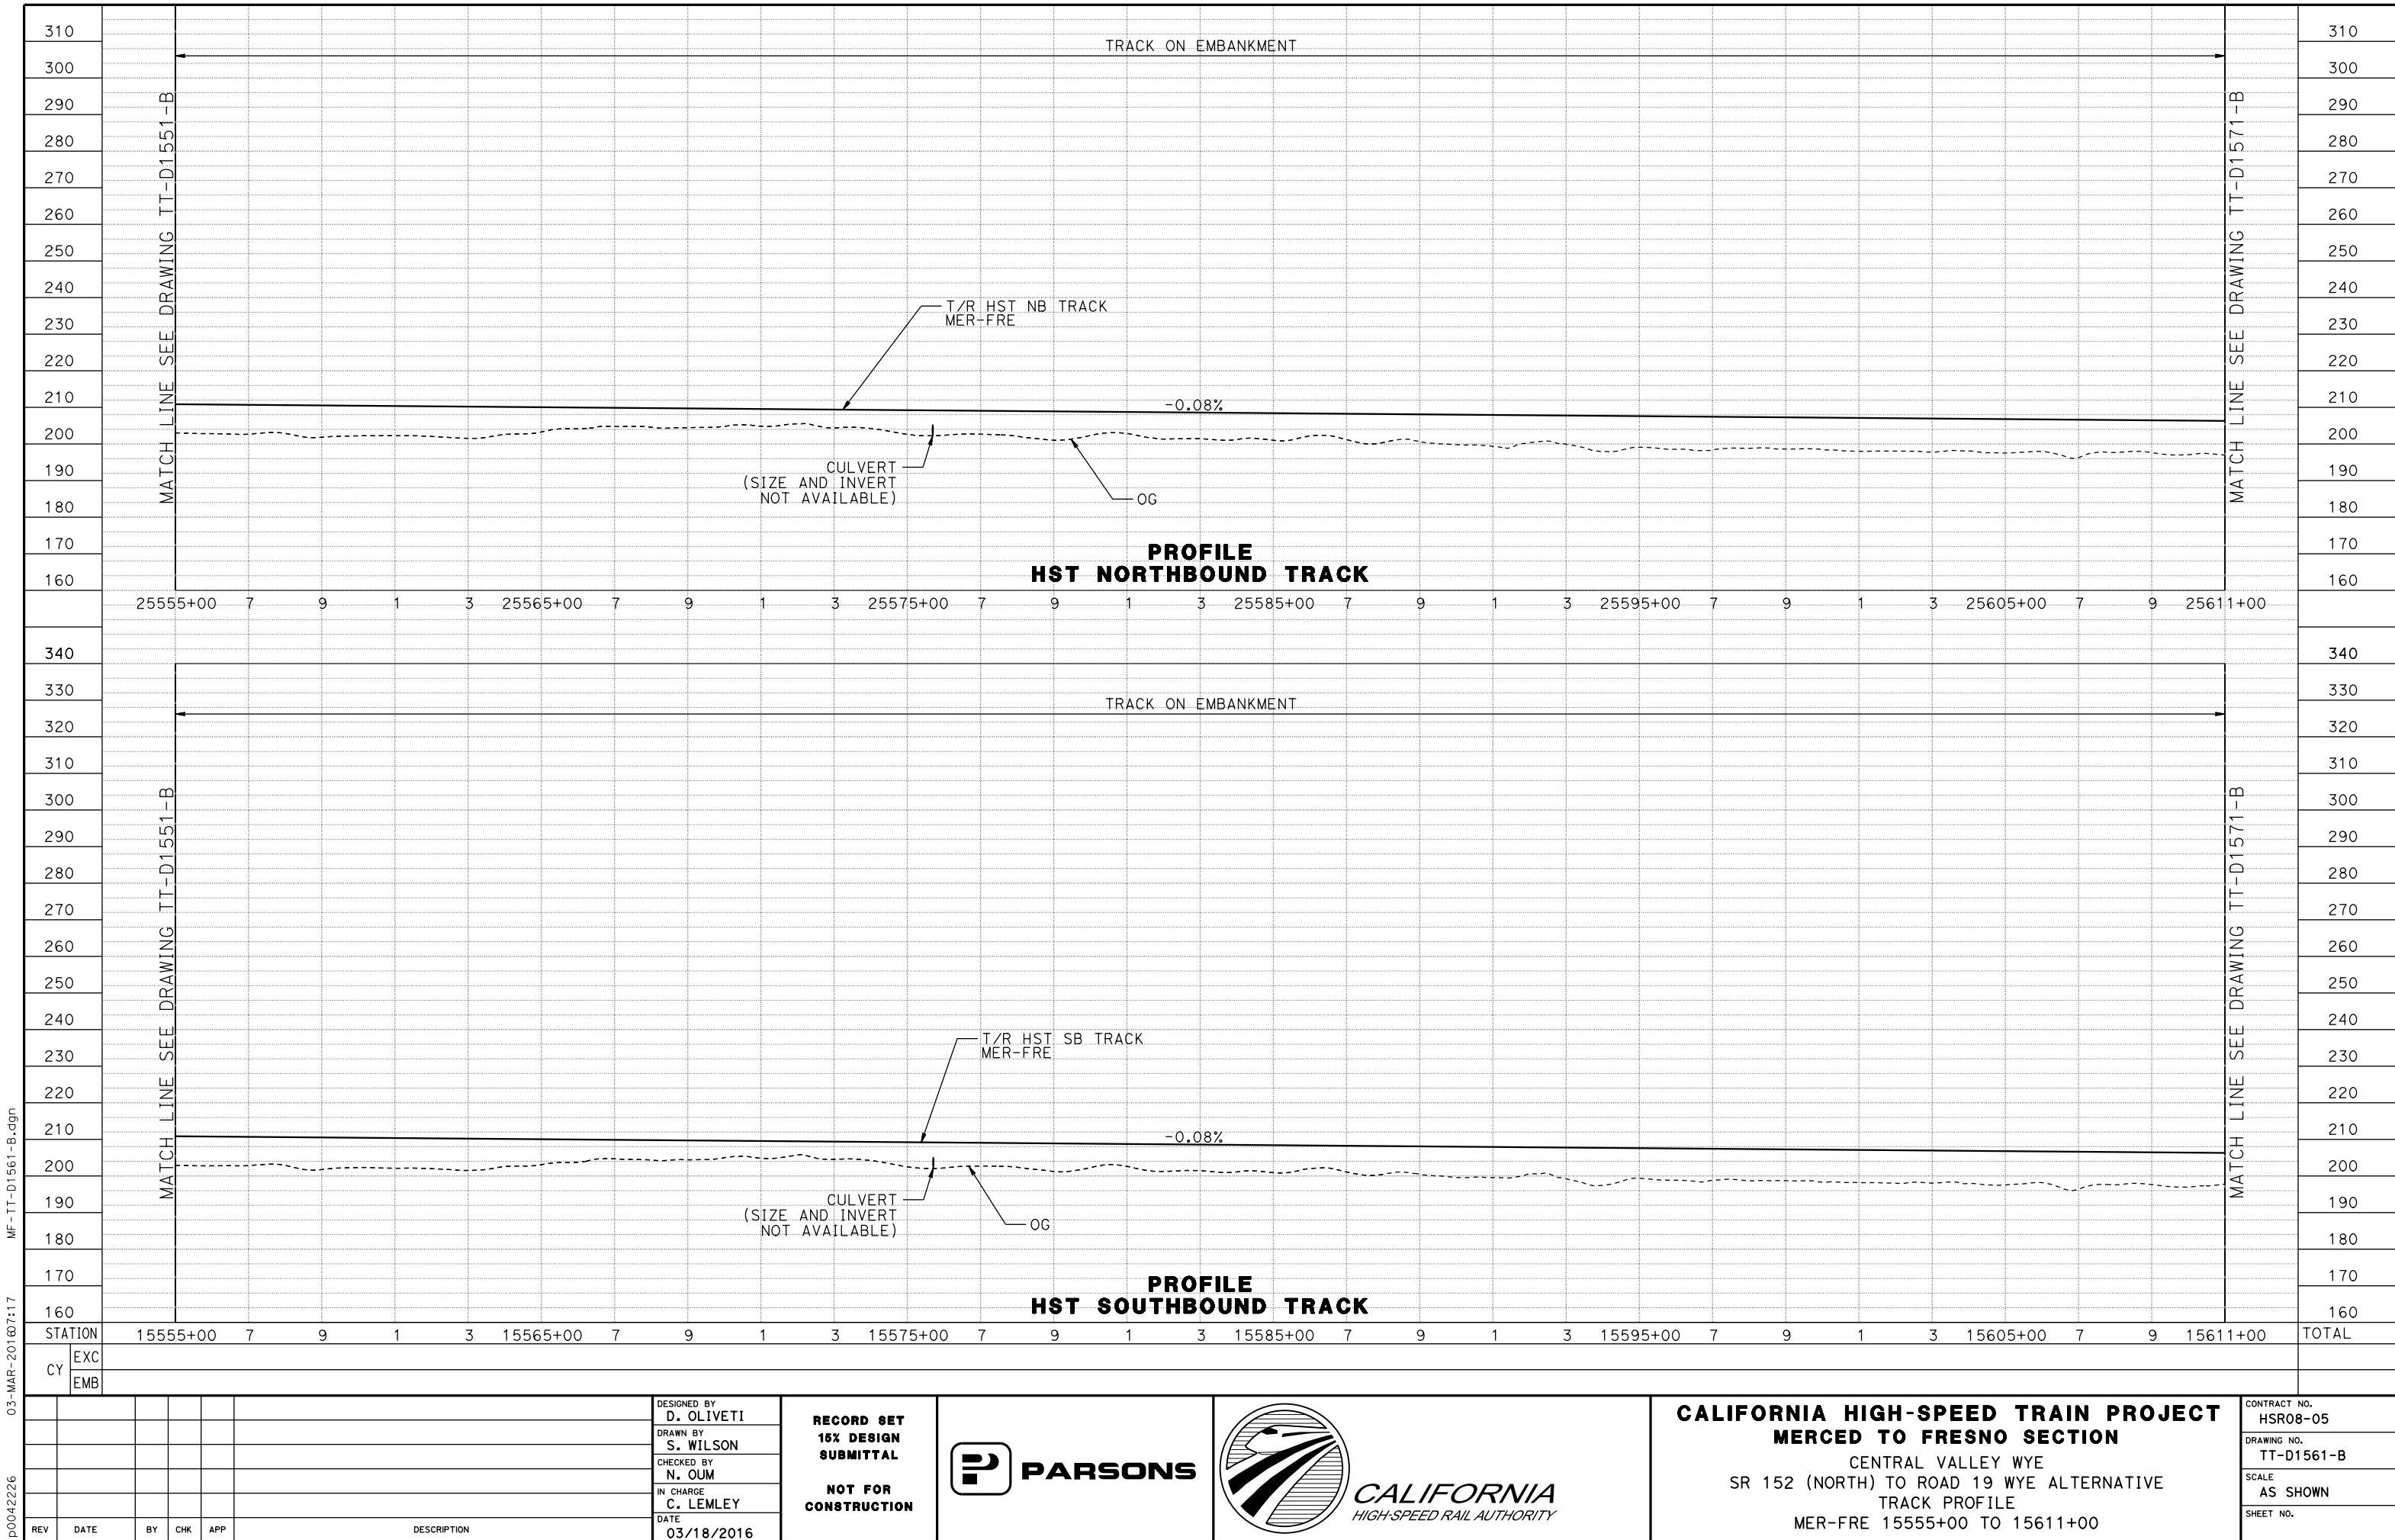

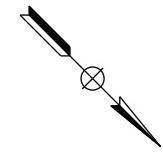

MERCED COUNTY

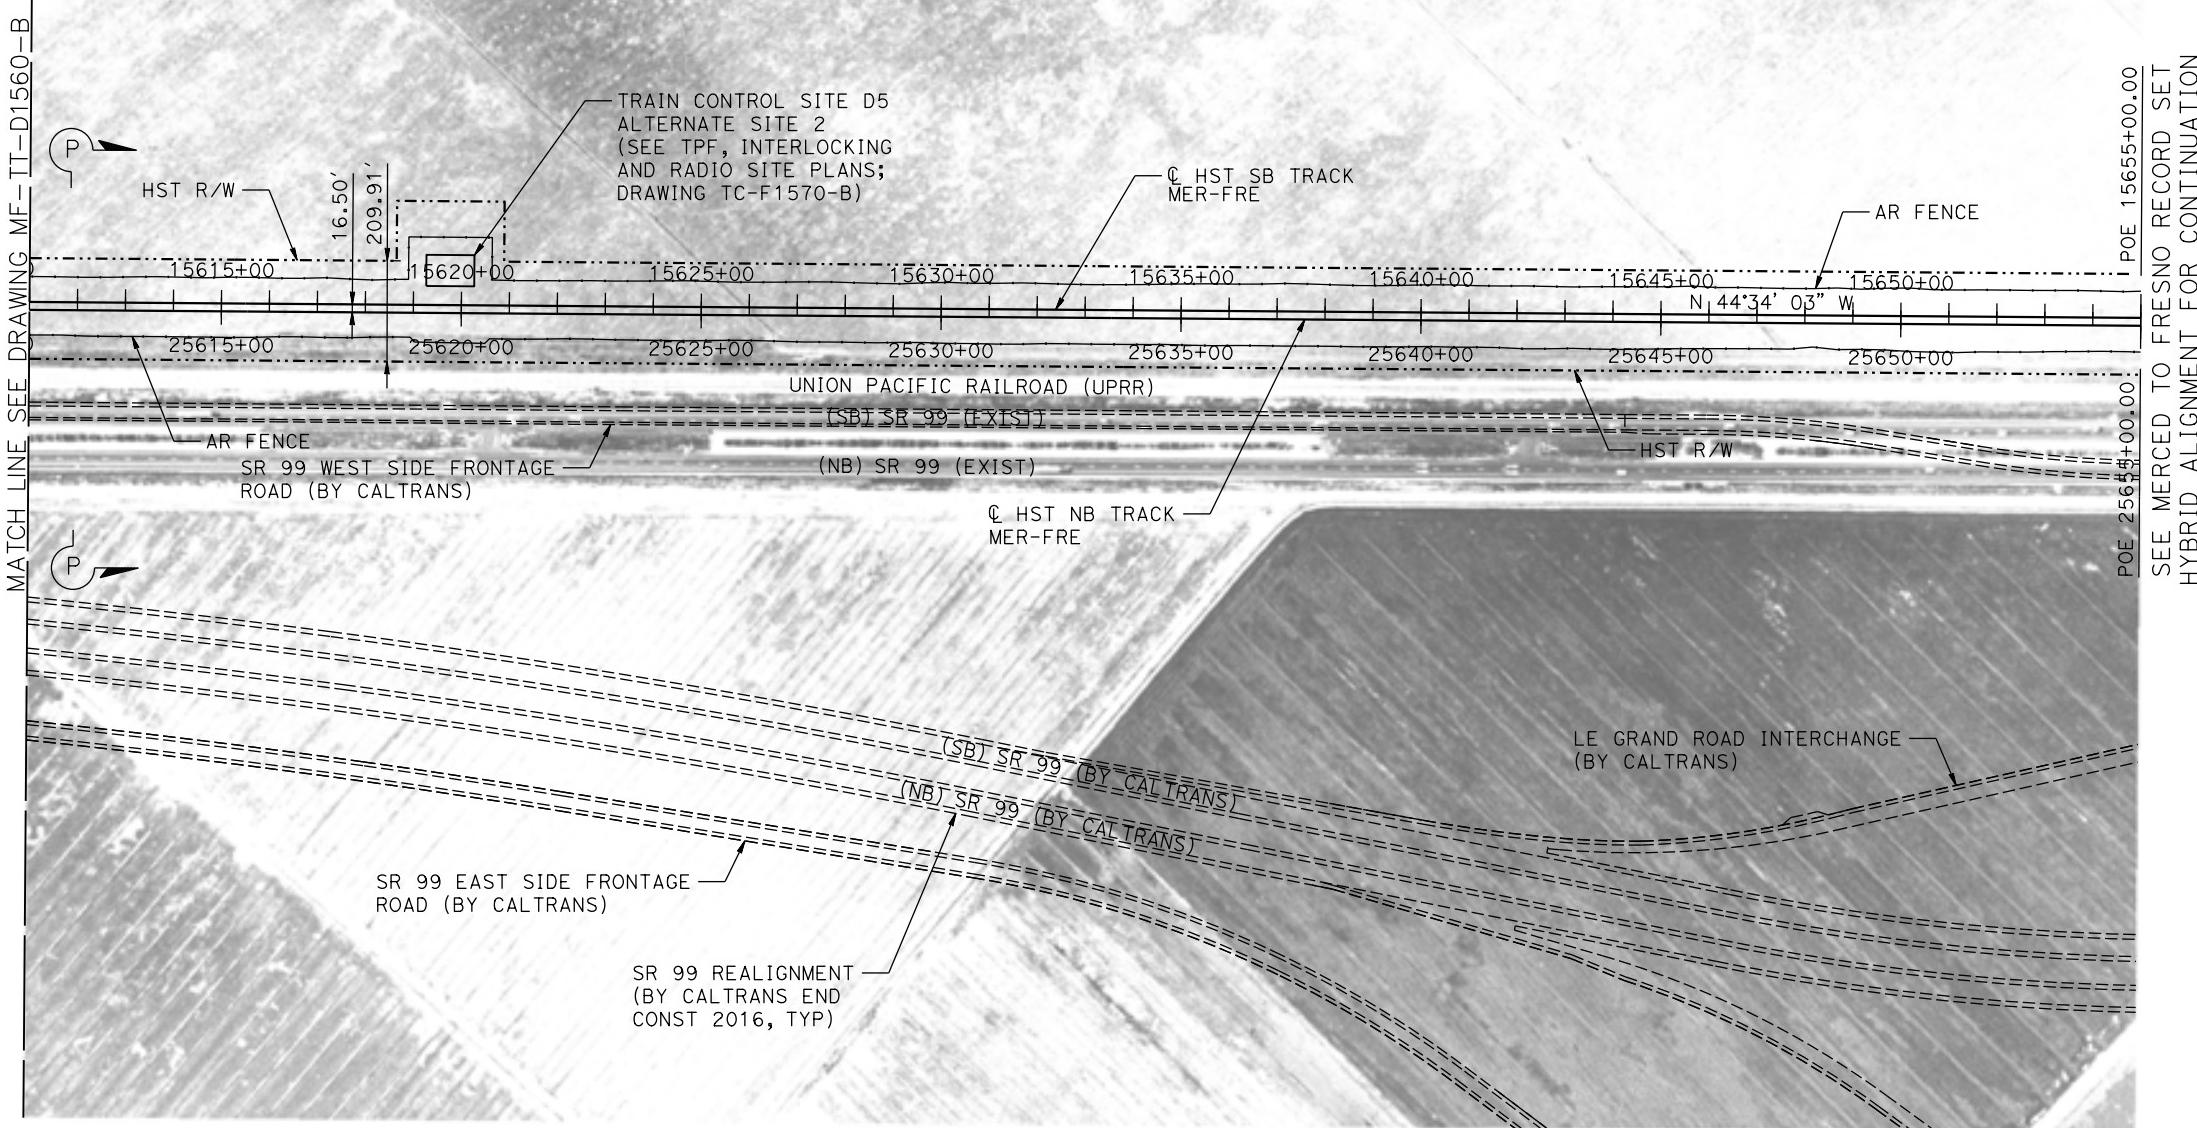


200 0 200 400
1"=200'

					DESIGNED BY D. OLIVETI
					DRAWN BY S. WILSON
					CHECKED BY N. OUM
					IN CHARGE C. LEMLEY
					DATE 03/18/2016
REV	DATE	BY	CHK	APP	DESCRIPTION

RECORD SET
15% DESIGN
SUBMITTAL
**NOT FOR
CONSTRUCTION**




PARSONS

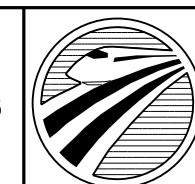

CALIFORNIA
HIGH-SPEED RAIL AUTHORITY

**CALIFORNIA HIGH-SPEED TRAIN PROJECT
MERCED TO FRESNO SECTION**
CENTRAL VALLEY WYE
SR 152 (NORTH) TO ROAD 19 WYE ALTERNATIVE
TRACK PLAN
MER-FRE 15611+00 TO 15655+00

CONTRACT NO.
HSR08-05
DRAWING NO.
TT-D1570-B
SCALE
AS SHOWN
SHEET NO.

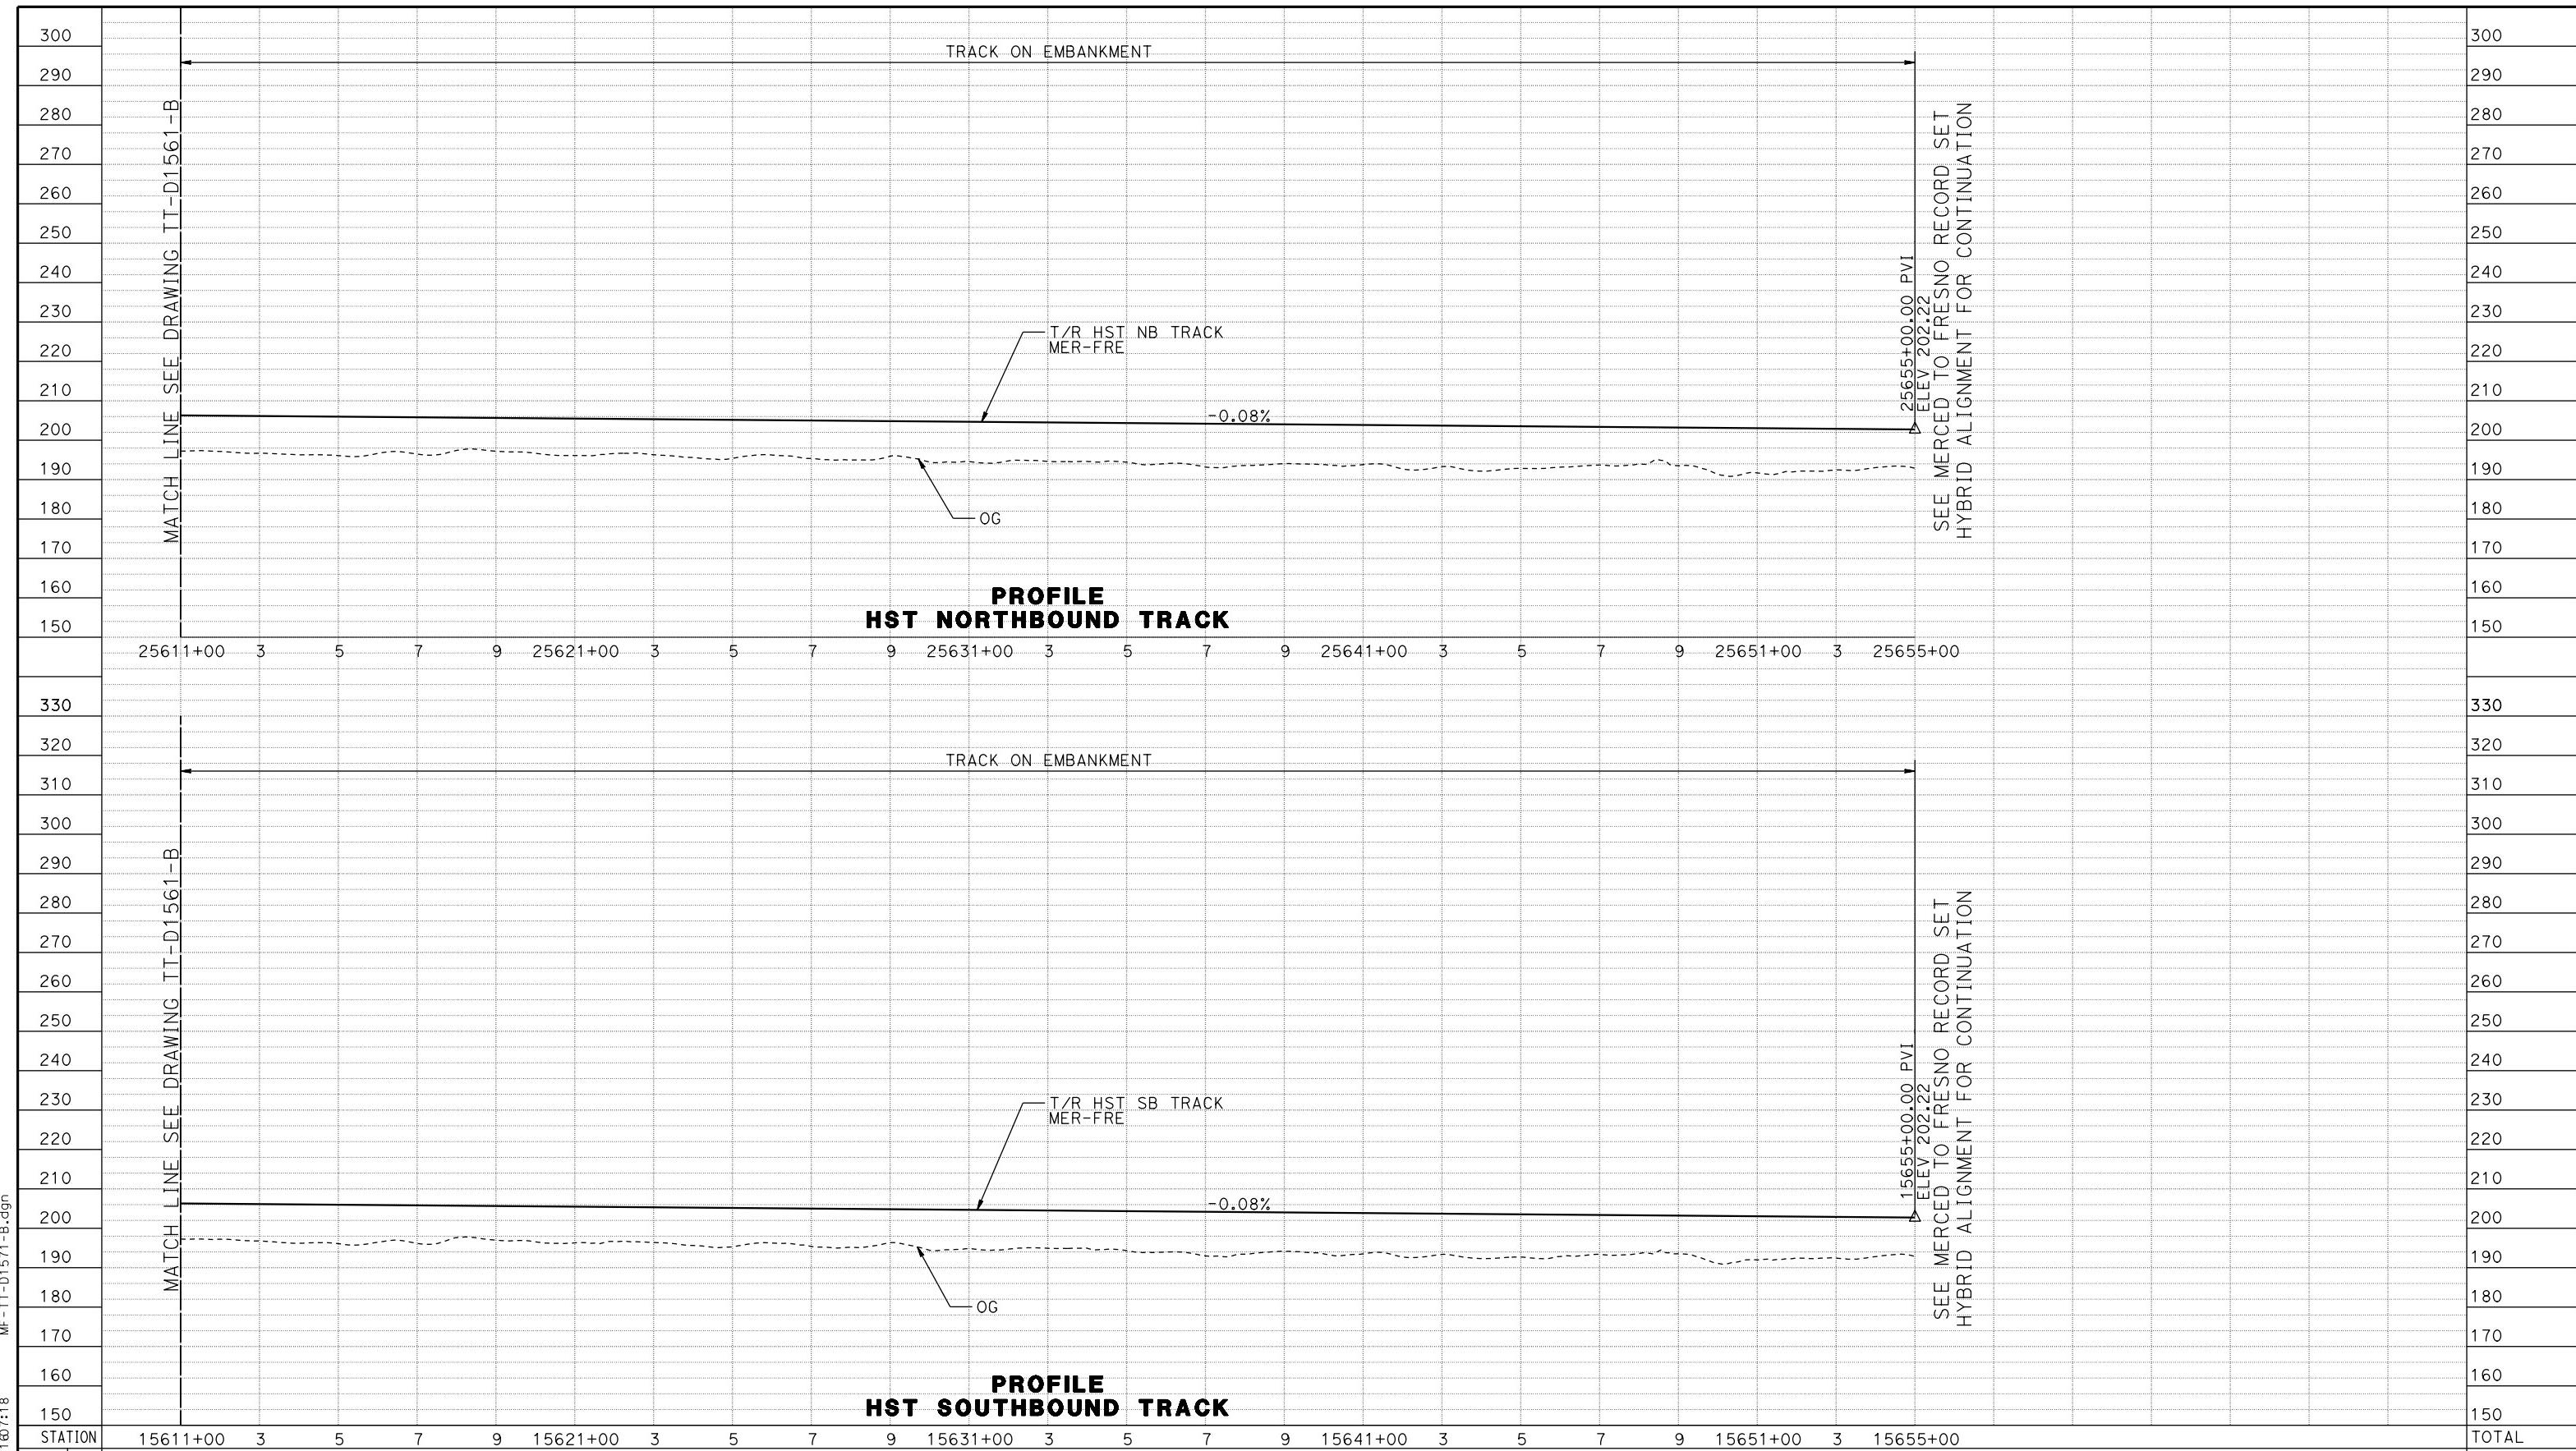

MF-11-D1571-B.dgn

3-MAR-2016 7:18

P00422

BY
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Y
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MLEY
3/2016

**RECORD SET
15% DESIGN
SUBMITTAL**

**NOT FOR
CONSTRUCTION**




CALIFORNIA HIGH-SPEED RAIL AUTHORITY

CALIFORNIA HIGH-SPEED TRAIN PROJECT MERCED TO FRESNO SECTION

CENTRAL VALLEY WYE
SR 152 (NORTH) TO ROAD 19 WYE ALTERNATIVE
TRACK PROFILE
MER-FRE 15611+00 TO 15665+00

TRACT NO.
HSR08-05
AWING NO.
TT-D1571-B
ALE
AS SHOWN
ET NO.

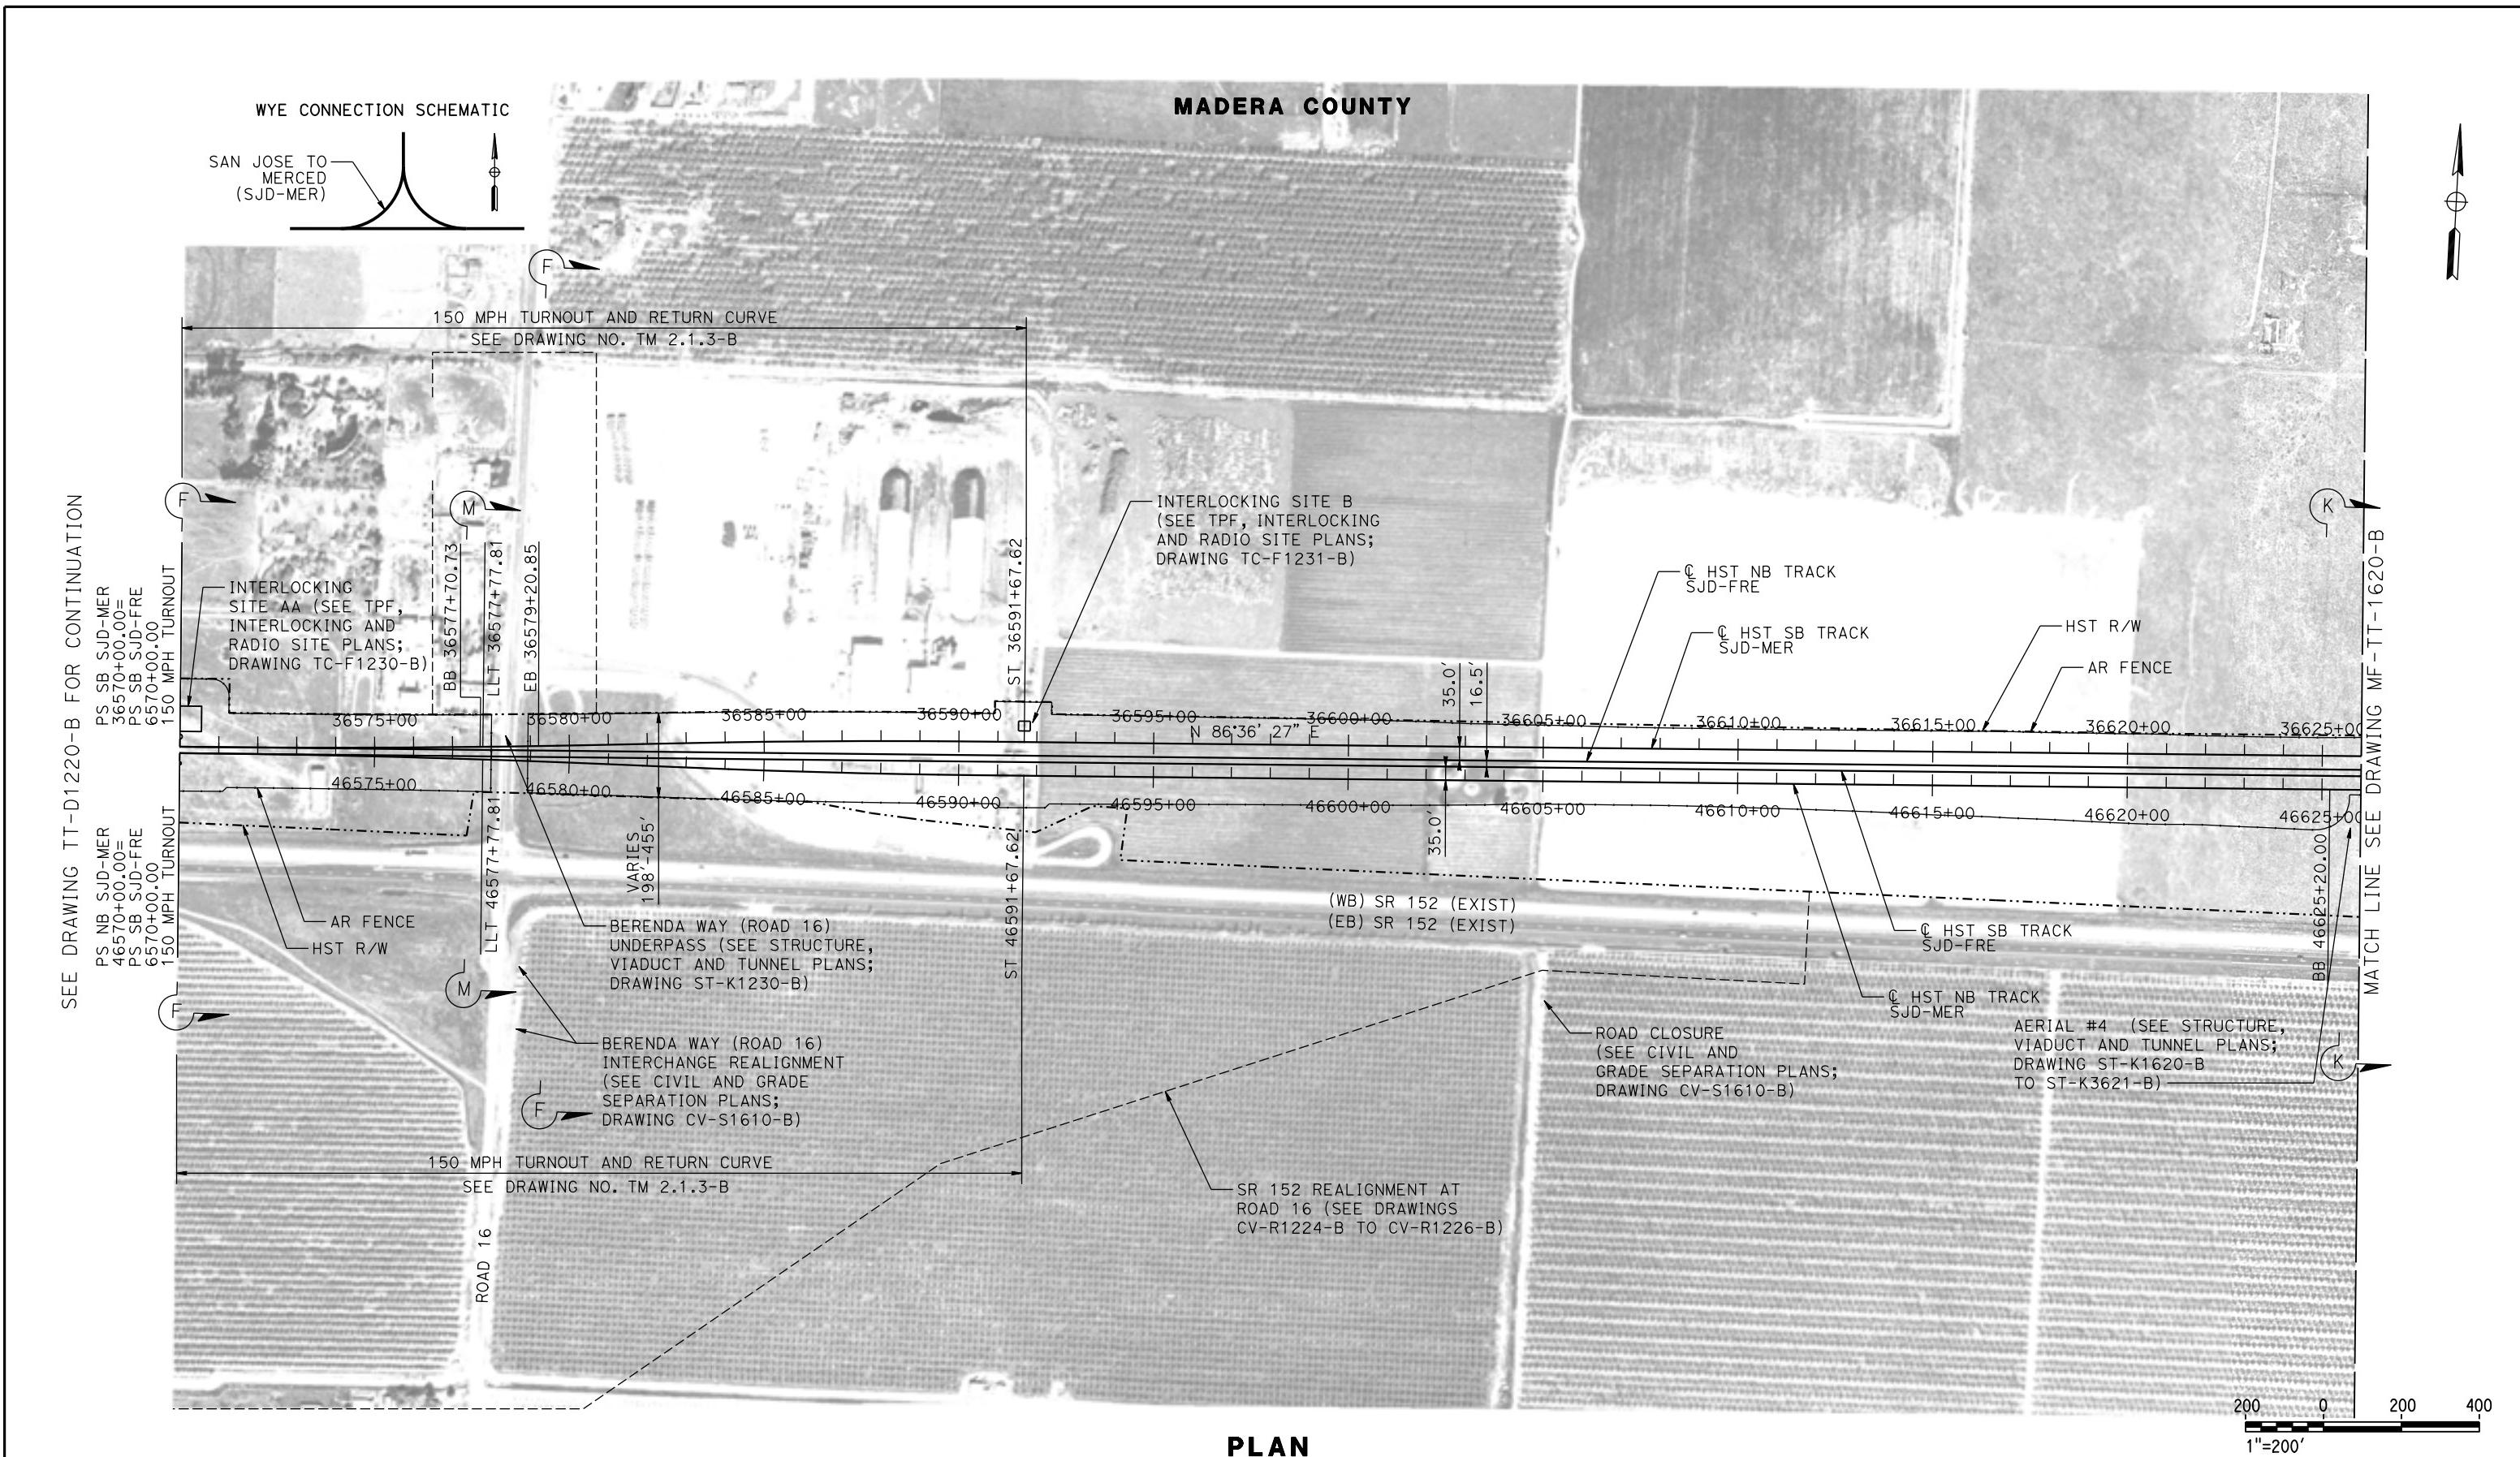**PLAN**

REV	DATE	BY	CHK	APP	DESCRIPTION
p004226	03/18/2016				

DESIGNED BY
D. OLIVETI
DRAWN BY
S. WILSON
CHECKED BY
N. OUM
IN CHARGE
C. LEMLEY
DATE
03/18/2016

RECORD SET
15% DESIGN
SUBMITTAL
**NOT FOR
CONSTRUCTION**




PARSONS




**CALIFORNIA HIGH-SPEED TRAIN PROJECT
MERCED TO FRESNO SECTION**

CENTRAL VALLEY WYE
SR 152 (NORTH) TO ROAD 19 WYE ALTERNATIVE
TRACK PLAN
SJD-MER STA 36570+00.00 TO 36626+00.00

CONTRACT NO.
HSR08-05
DRAWING NO.
TT-D1610-B
SCALE
AS SHOWN
SHEET NO.

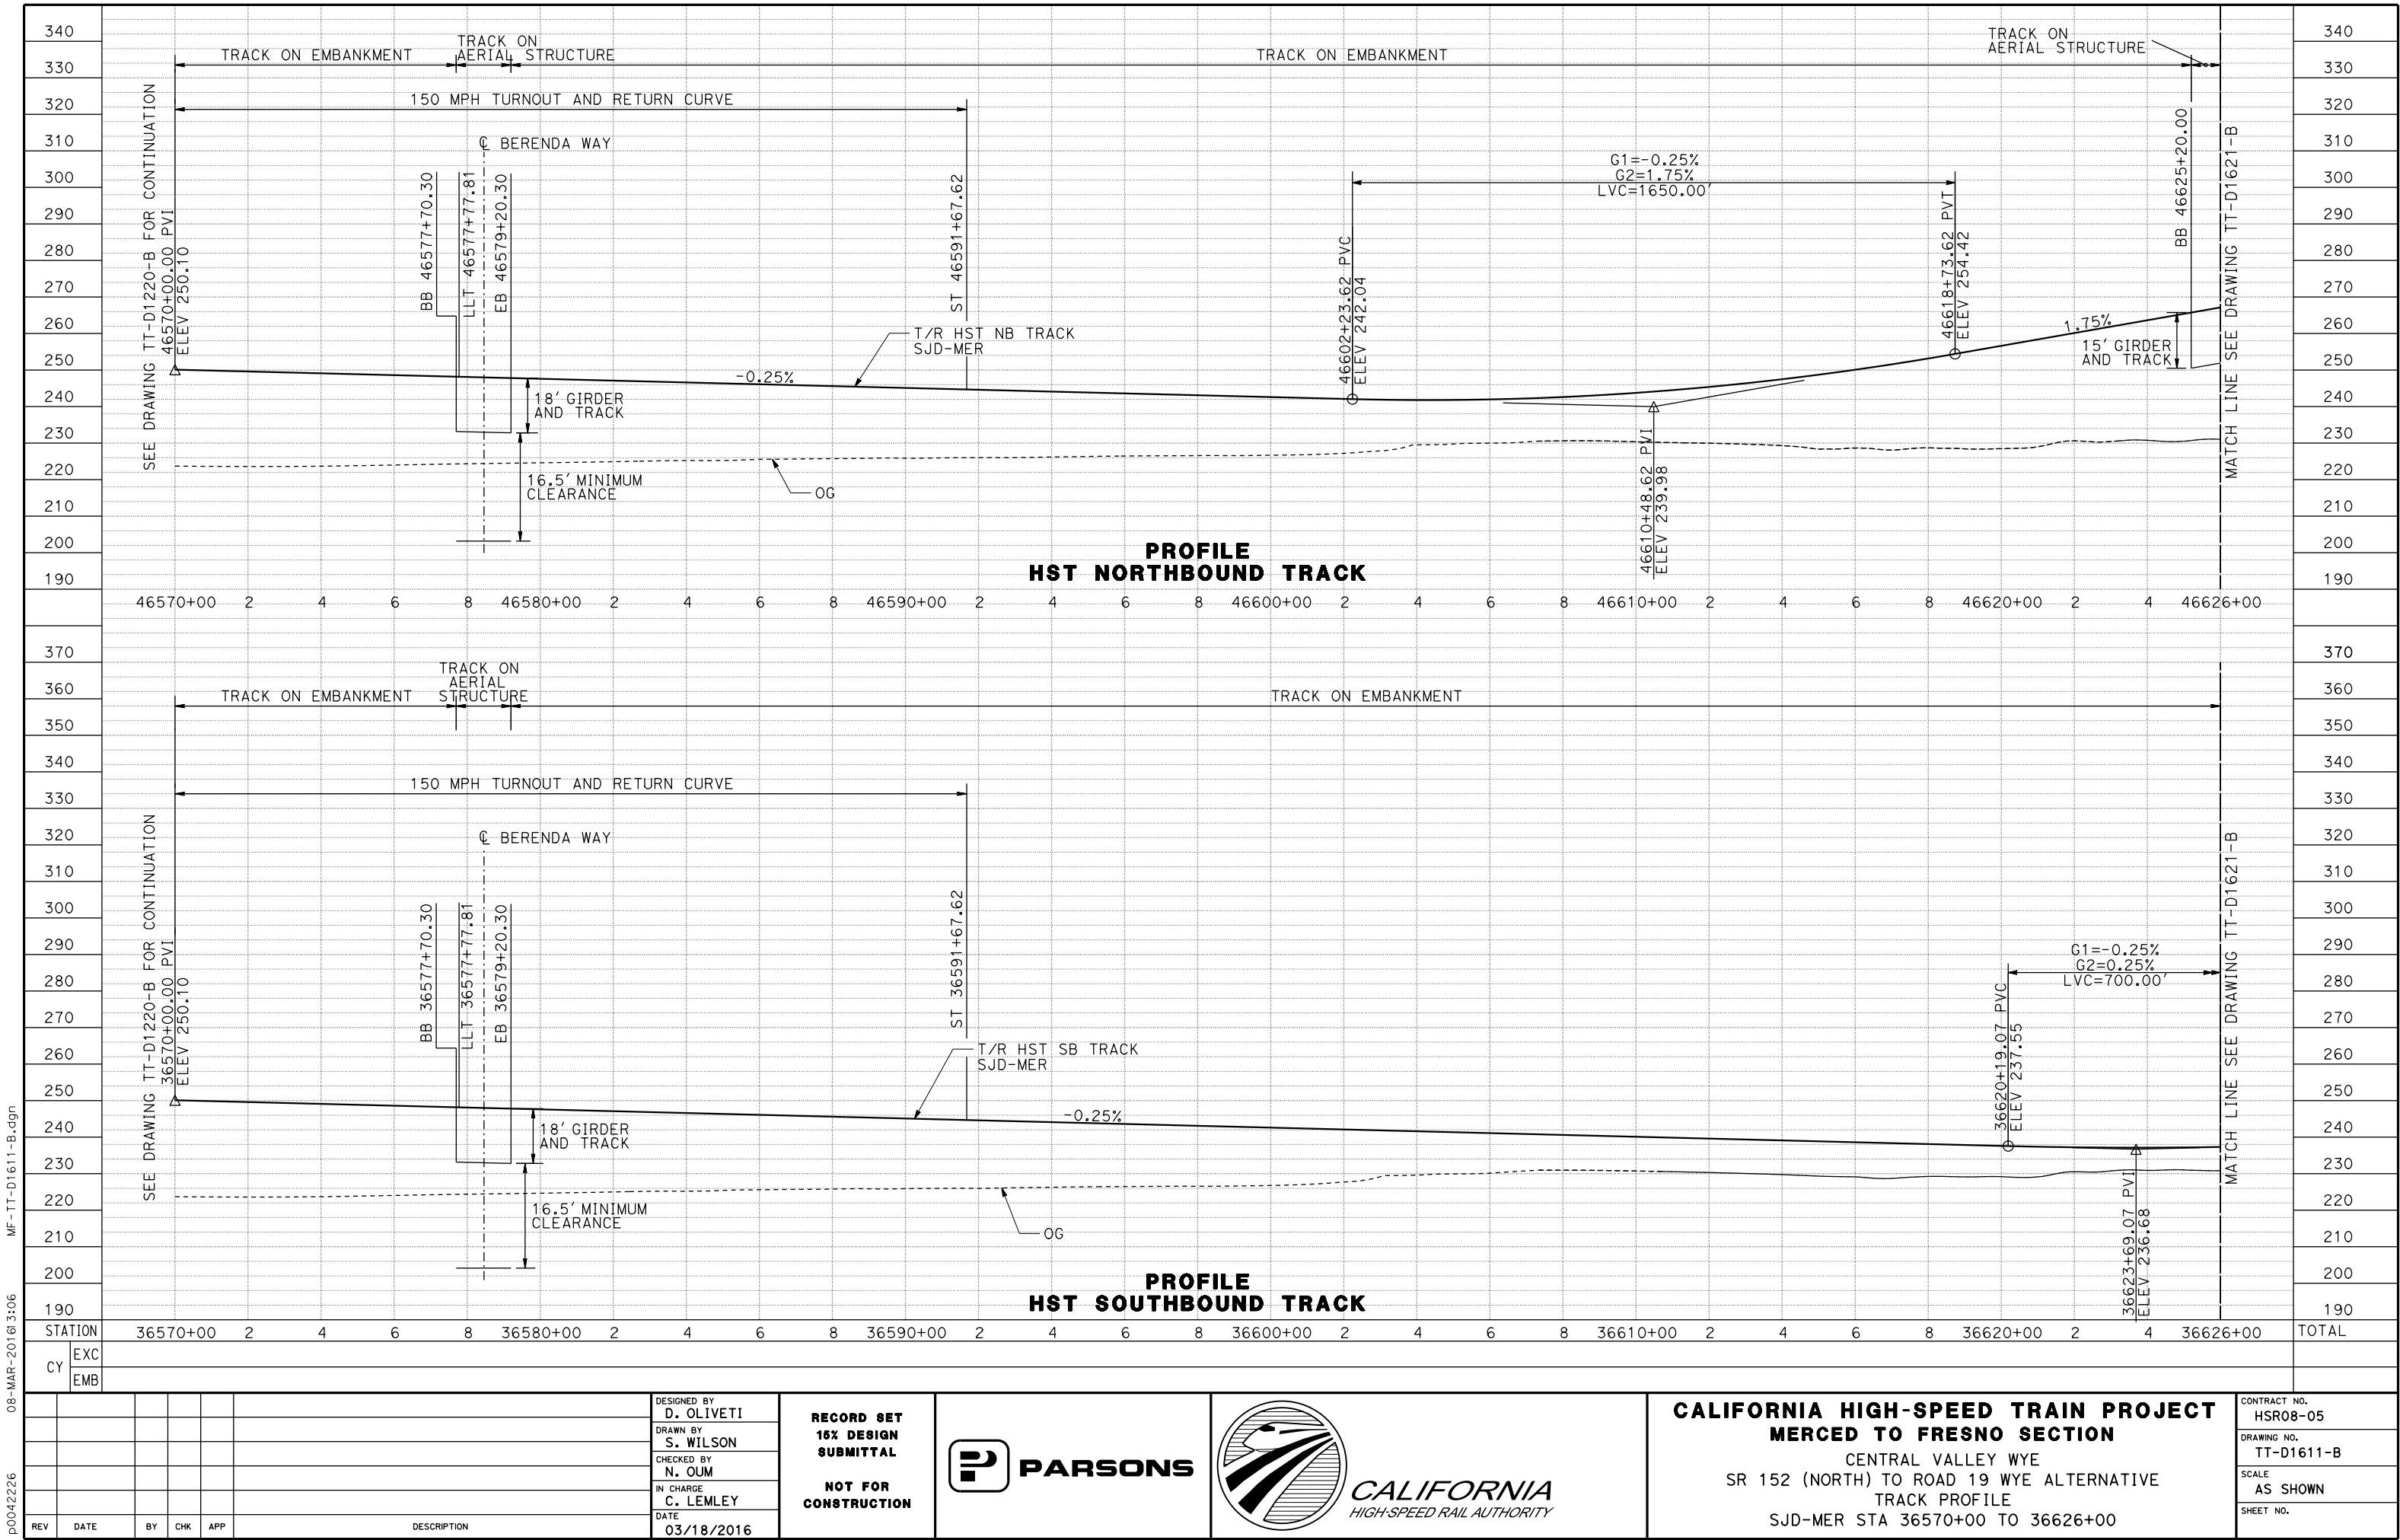

MADERA COUNTY

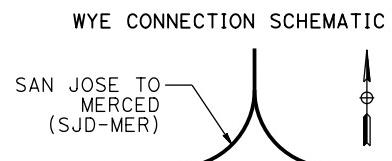

MATCH LINE SEE DRAWING TT-D1610-B

ROAD 17

TS 36634+19.07

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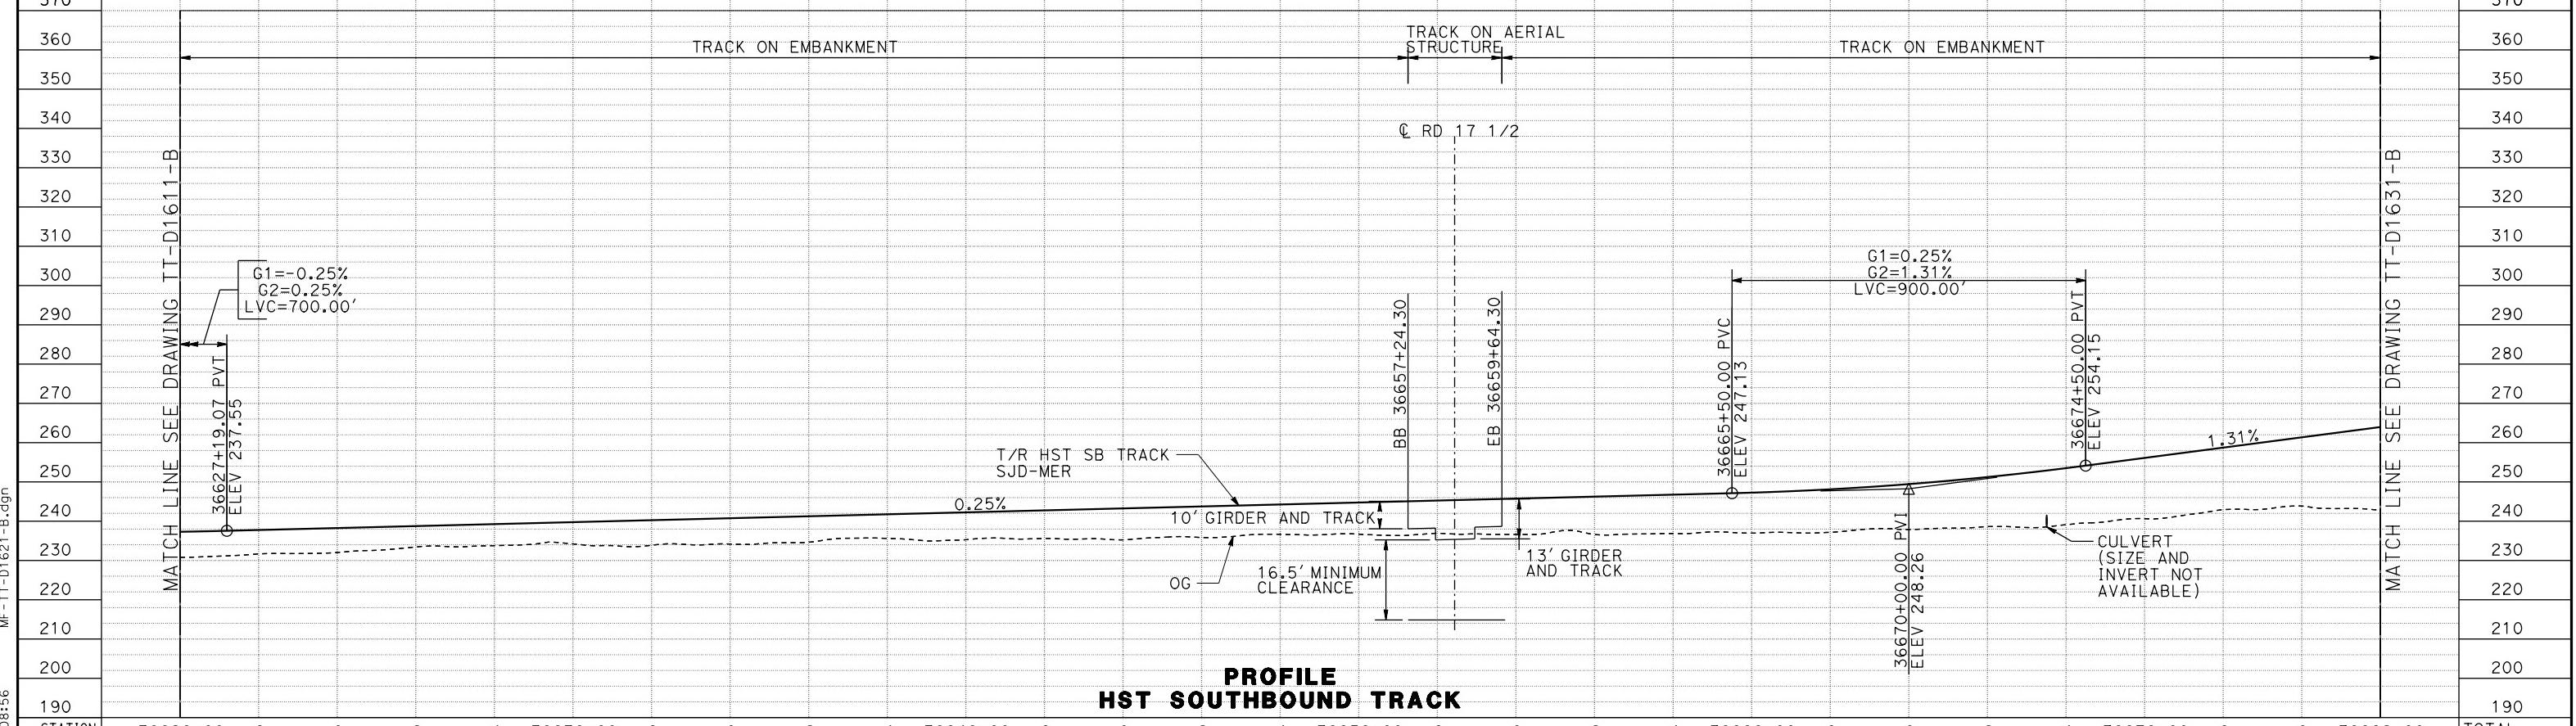
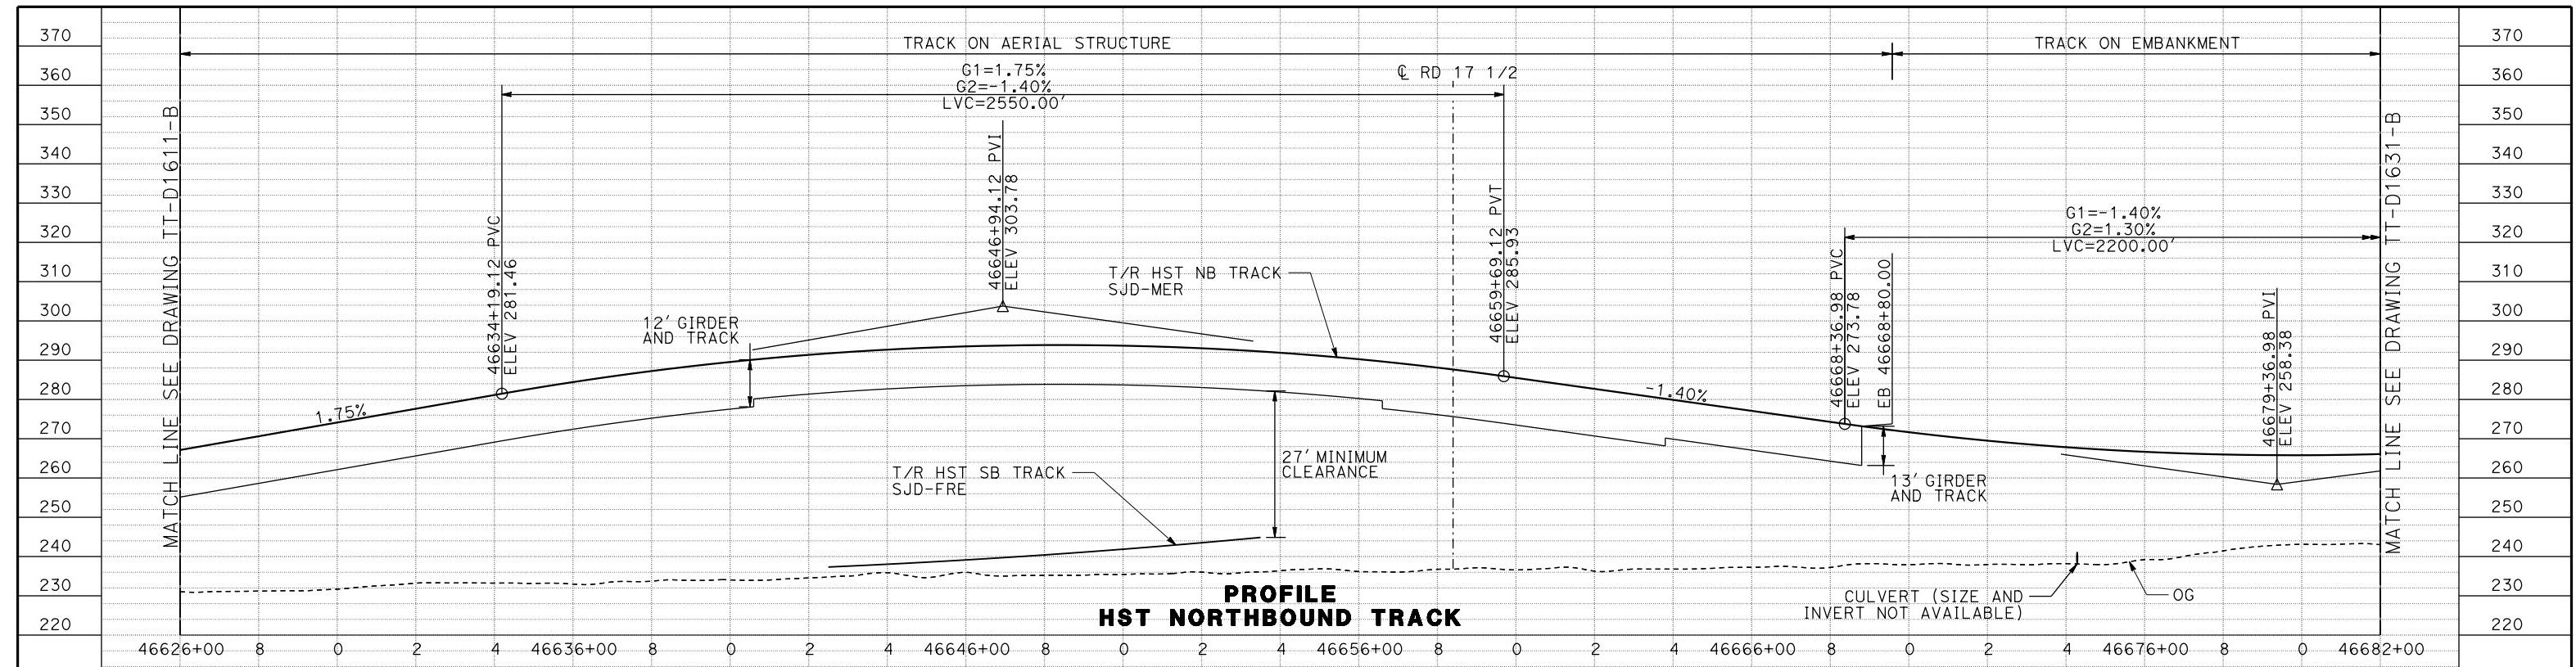
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2-MAR-201608:

P00422

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**RECORD SET
15% DESIGN
SUBMITTAL**

**NOT FOR
CONSTRUCTION**



PARSONS




CALIFORNIA HIGH-SPEED RAIL AUTHORITY

**CALIFORNIA HIGH-SPEED TRAIN PROJECT
MERCED TO FRESNO SECTION**

CENTRAL VALLEY WYE
SR 152 (NORTH) TO ROAD 19 WYE ALTERNATIVE
TRACK PROFILE
SJD-MER STA 36626+00 TO 36682+00

TRACT NO.
HSR08-05
AWING NO.
TT-D1621-B
ALE
AS SHOWN
ET NO.

MADERA COUNTY

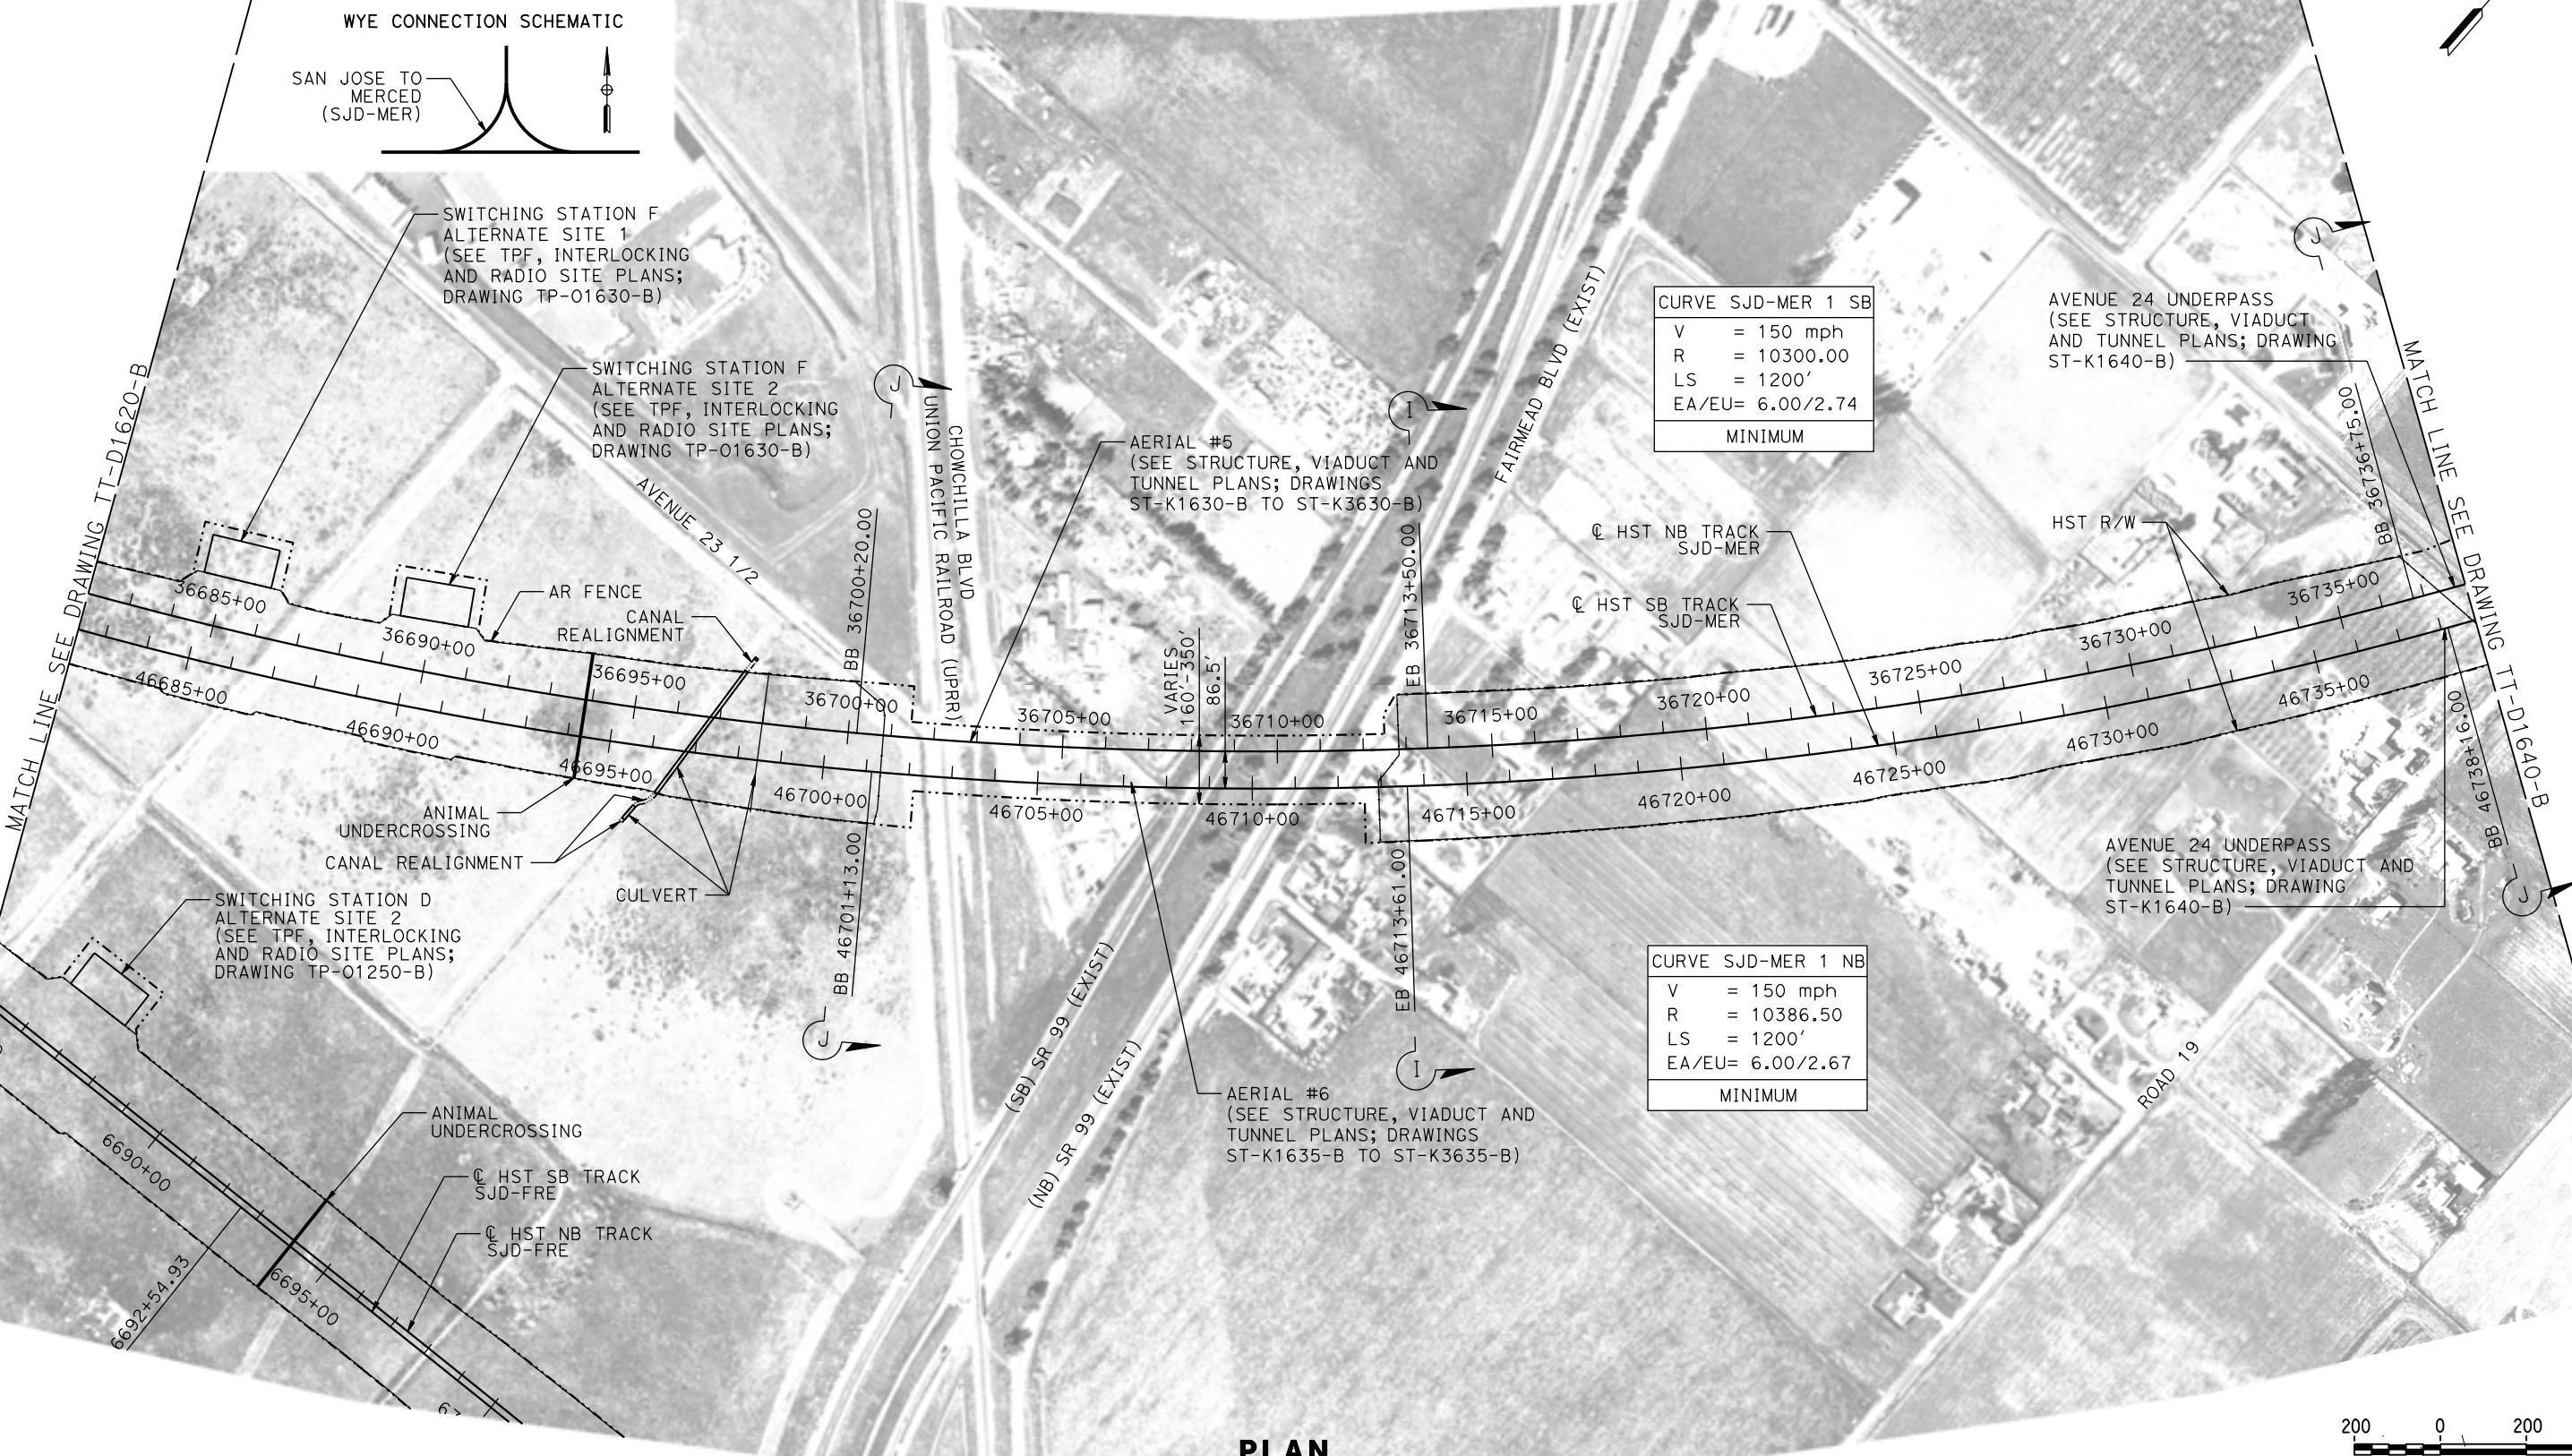

MF-TT-D1630-B.dgn

10-MAR-2016 6:15


p0042226

					DESIGNED BY D. OLIVETI
					DRAWN BY S. WILSON
					CHECKED BY N. OUM
					IN CHARGE C. LEMLEY
					DATE 03/18/2016
REV	DATE	BY	CHK	APP	DESCRIPTION

RECORD SET
15% DESIGN
SUBMITTAL
**NOT FOR
CONSTRUCTION**



PARSONS


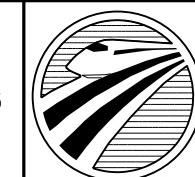


CALIFORNIA
HIGH-SPEED RAIL AUTHORITY

CALIFORNIA HIGH-SPEED TRAIN PROJECT MERCED TO FRESNO SECTION


CENTRAL VALLEY WYE
SR 152 (NORTH) TO ROAD 19 WYE ALTERNATIVE
TRACK PLAN
SJD-MER STA 36682+00 TO 36738+00

CONTRACT NO. HSR08-05
DRAWING NO. TT-D1630-B
SCALE AS SHOWN
SHEET NO.

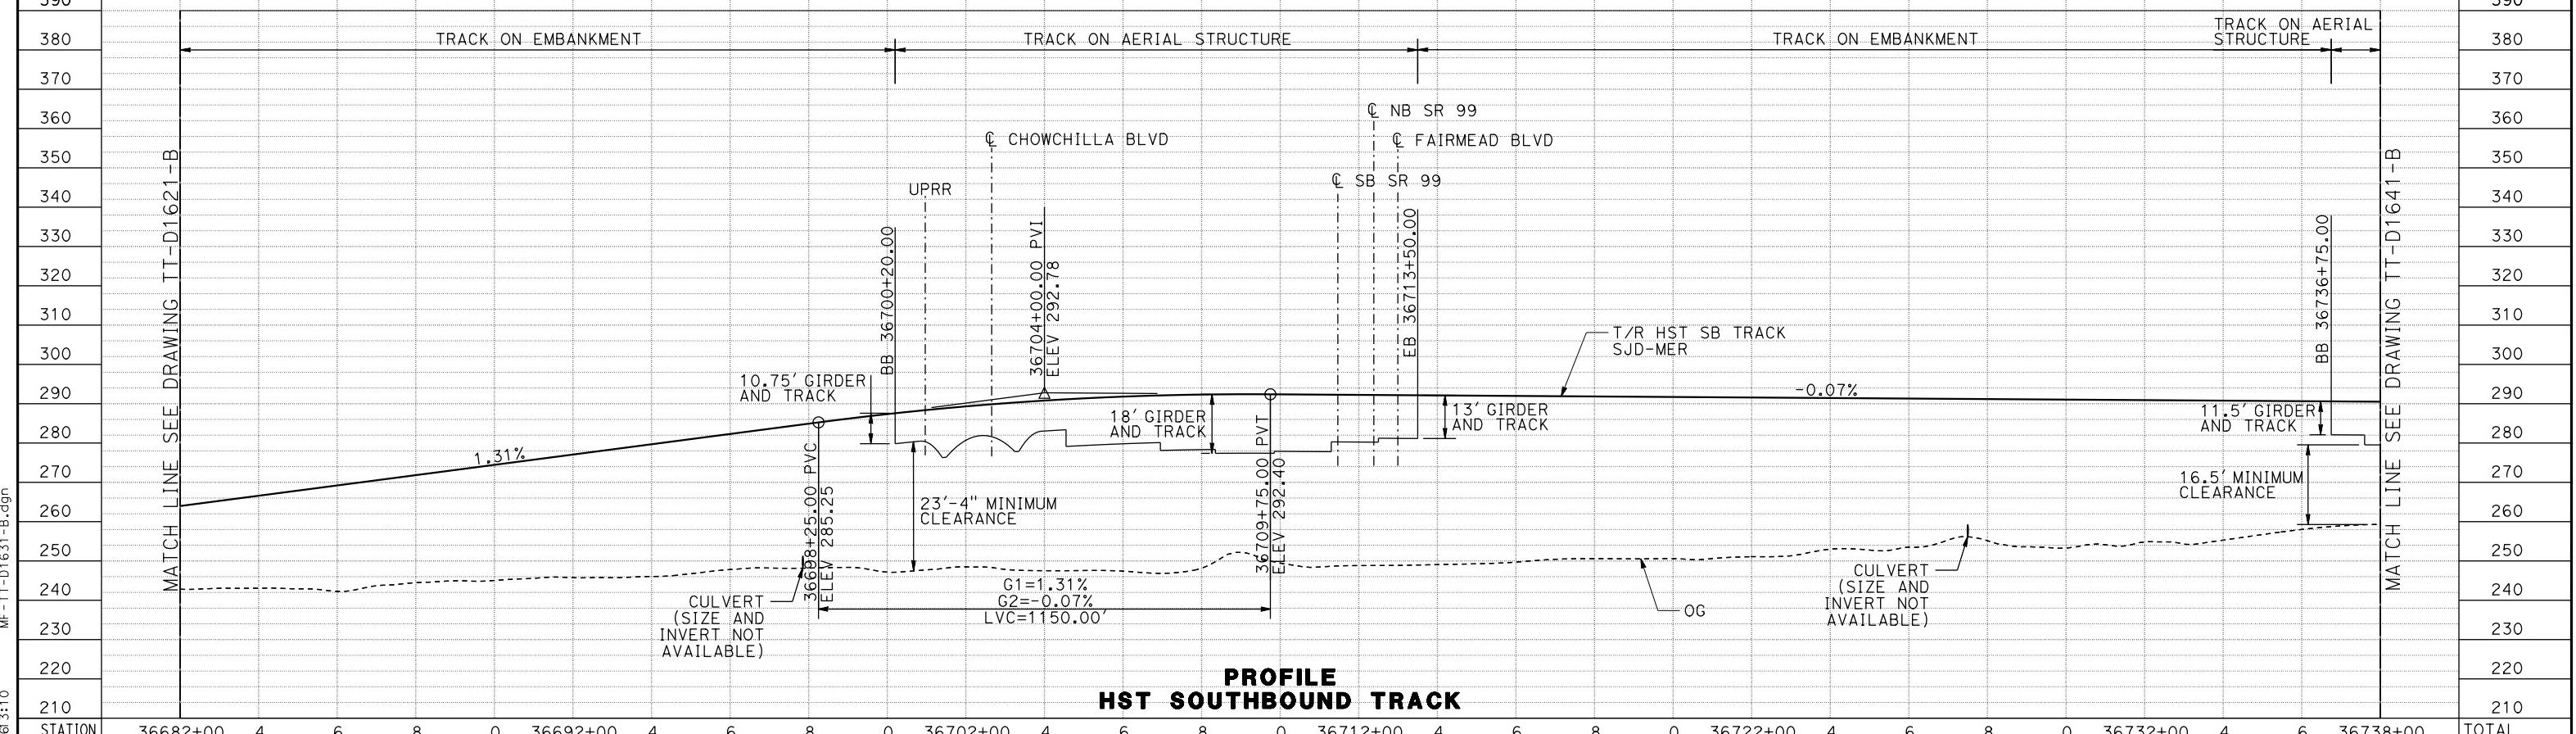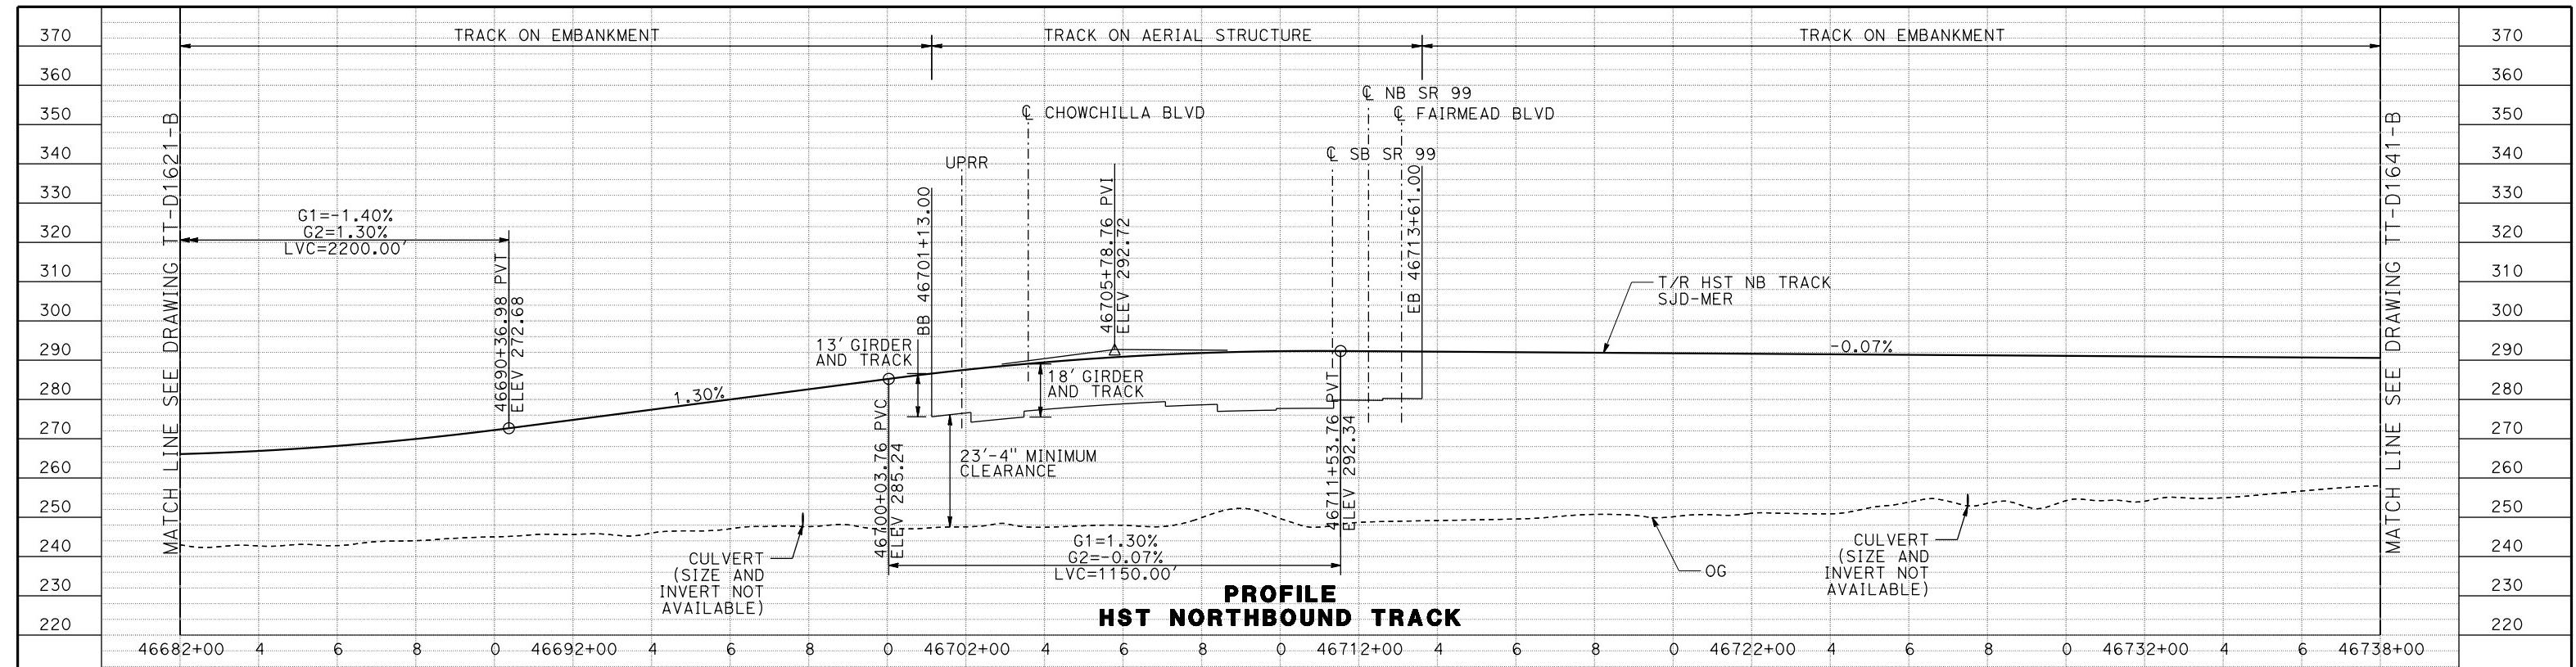

MAR-2011 50002100 4 0 0 0 50002100 4 0 0 0 50102100 4 0 0 0 50112100 4 0 0 0 50122100 4 0 0 0 50132100 4 0 0 0 50152100 4 0 0 0 50172100 4 0 0 0 50192100 4 0 0 0 501A2100 4 0 0 0

MADERA COUNTY

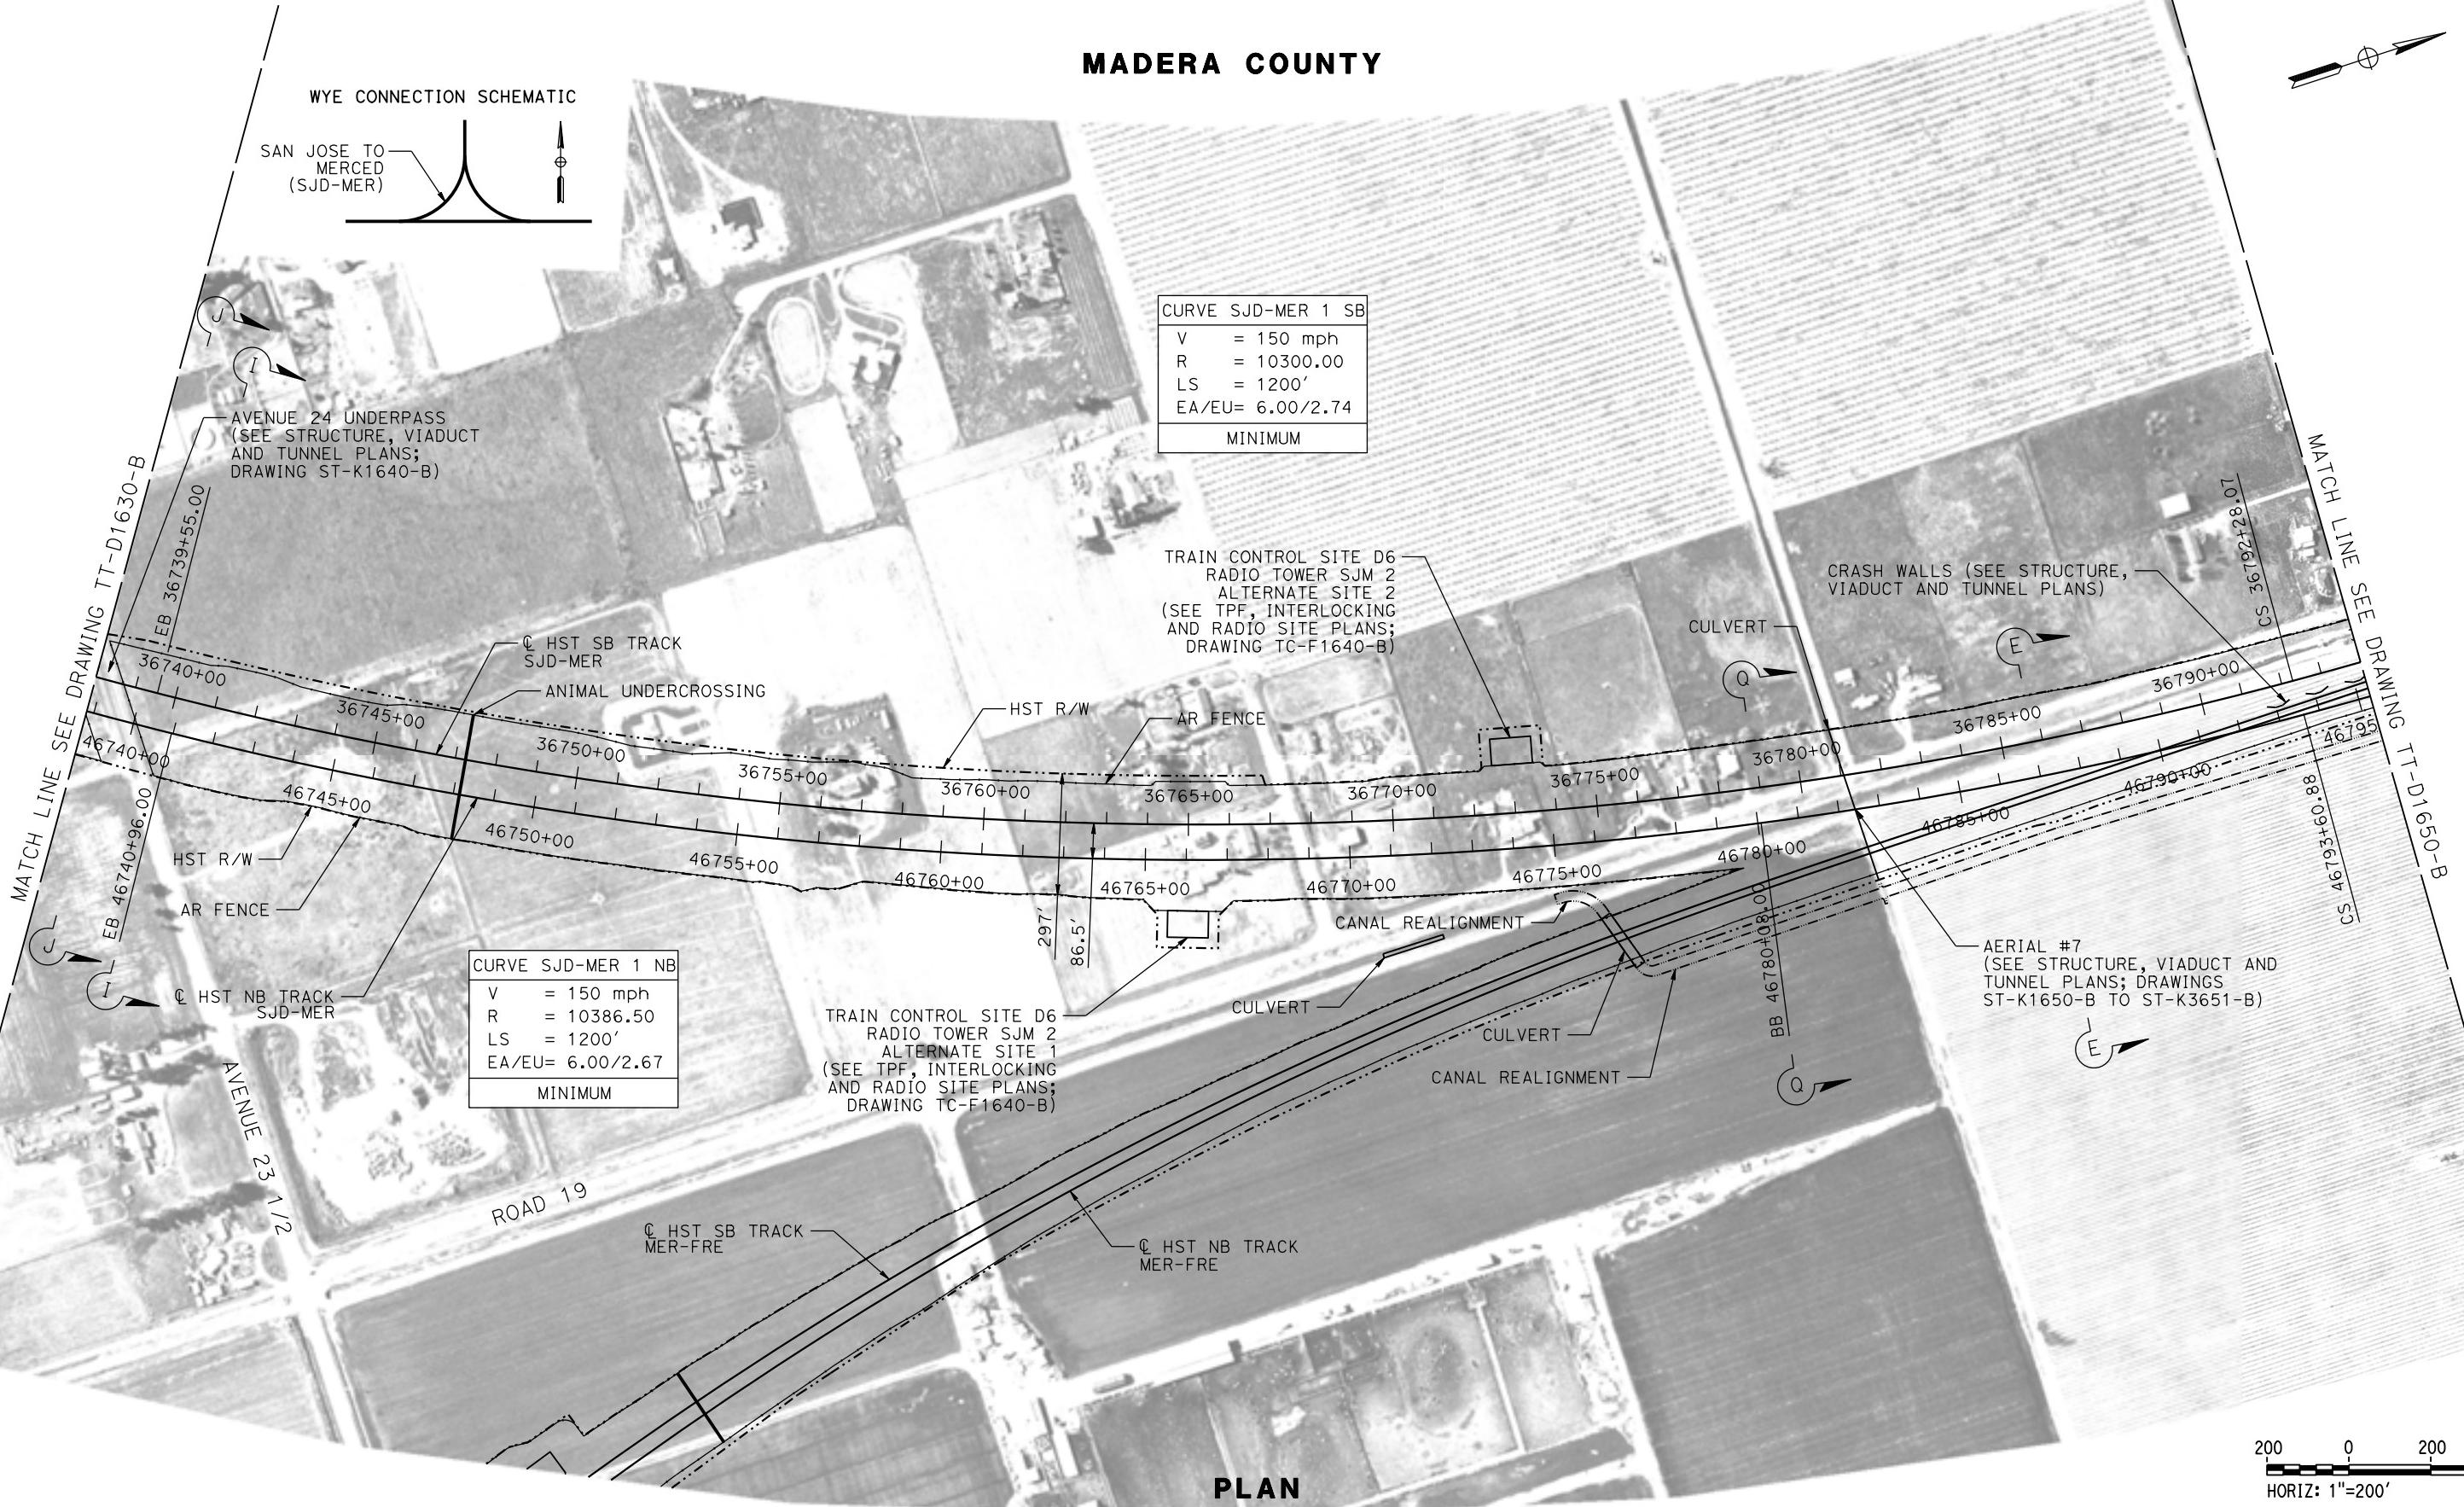

MF-TT-D1640-B.dwg

12-MAR-2016 08:56


p0042226

REV	DATE	BY	CHK	APP	DESCRIPTION
					03/18/2016

DESIGNED BY D. OLIVETI	RECORD SET 15% DESIGN SUBMITTAL	 PARSONS	 CALIFORNIA HIGH-SPEED RAIL AUTHORITY
DRAWN BY S. WILSON			
CHECKED BY N. OUM			
IN CHARGE C. LEMLEY			
DATE 03/18/2016			

CALIFORNIA HIGH-SPEED TRAIN PROJECT
MERCED TO FRESNO SECTION
CENTRAL VALLEY WYE
SR 152 (NORTH) TO ROAD 19 WYE ALTERNATIVE
TRACK PLAN
SJD-MER STA 36738+00 TO 36794+00

CONTRACT NO.
HSR08-05
DRAWING NO.
TT-D1640-B
SCALE
AS SHOWN
SHEET NO.

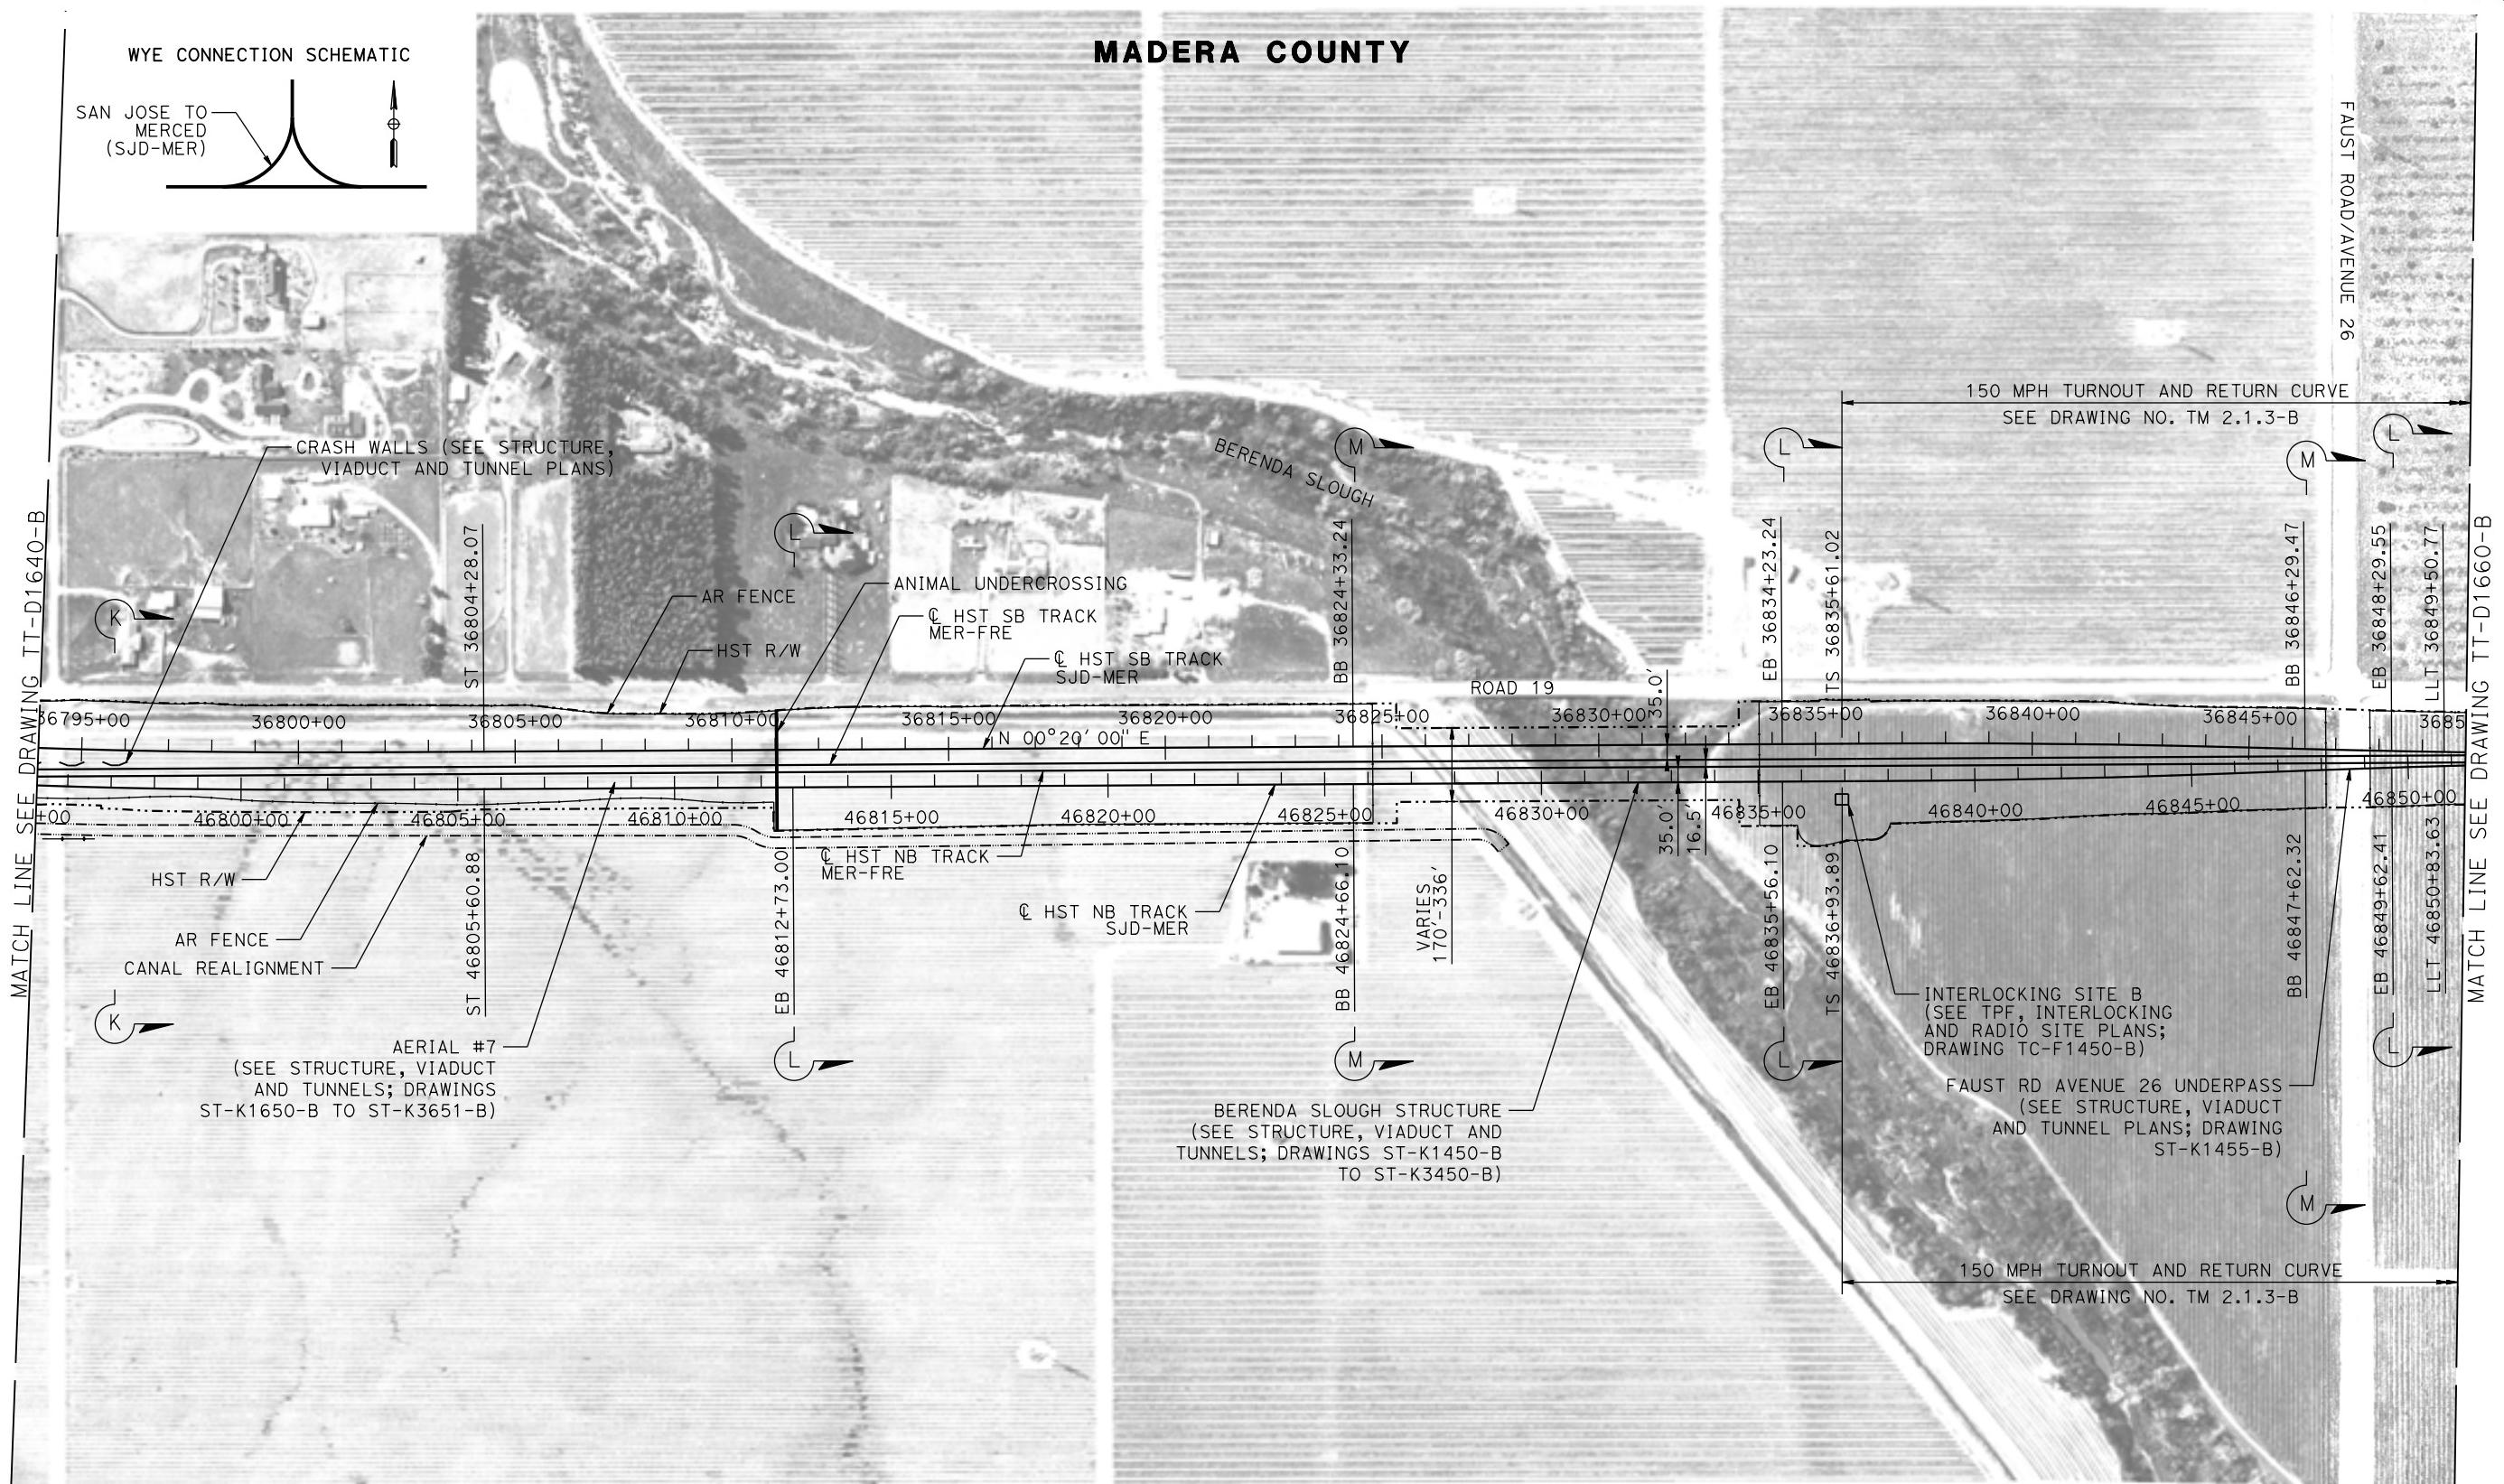


PLAN



**CALIFORNIA HIGH-SPEED TRAIN PROJECT
MERCED TO FRESNO SECTION**

CENTRAL VALLEY WYE
SR 152 (NORTH) TO ROAD 19 WYE ALTERNATIVE
TRACK PLAN
S-ID-MER STA 36794+00 TO 36850+00

CONTRACT NO.
HSR08-05
DRAWING NO.
TT-D1650-B
SCALE
AS SHOWN
SHEET NO.

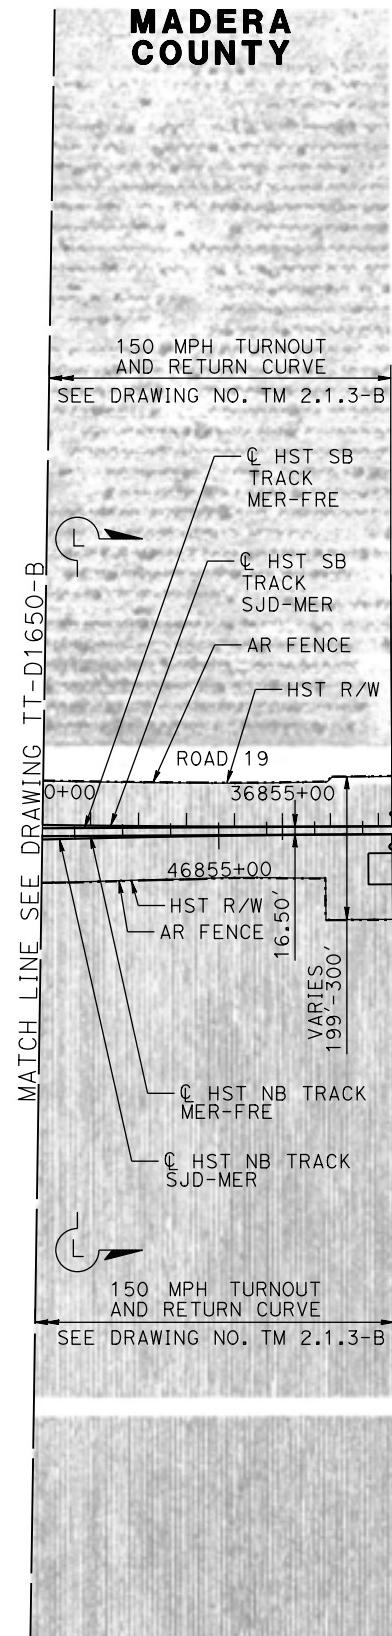

200 0 200 400
HORIZ: 1"=200'

PLAN

REV	DATE	BY	CHK	APP	DESCRIPTION

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DRAWN BY S. WILSON
CHECKED BY N. OUM
IN CHARGE C. LEMLEY
DATE 03/18/2016

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**CALIFORNIA HIGH-SPEED TRAIN PROJECT
MERCED TO FRESNO SECTION**
CENTRAL VALLEY WYE
SR 152 (NORTH) TO ROAD 19 WYE ALTERNATIVE
TRACK PLAN
SJD-MER STA 36850+00 TO 36857+28.64

CONTRACT NO. HSR08-05
DRAWING NO. TT-D1660-B
SCALE AS SHOWN
SHEET NO.

